

GENERAL NOTES

1. ZONING DESIGNATION: R1-10
2. PROPERTY OWNER IS RESPONSIBLE FOR MAINTAINING THE IRRIGATION SYSTEM AS LONG AS NECESSARY IN ORDER TO TRANSITION PLANTS OVER TO NATURAL SOURCES. ANY PLANT MATERIALS THAT DIE FOR ANY REASON SHALL BE REPLACED IN ACCORDANCE WITH SECTION 4-213.
3. PROPERTY OWNER SHALL MAINTAIN BUFFERYARD PLANTINGS TO ENSURE UNOBSTRUCTED VISIBILITY TO MOTORISTS. ALL SHRUBS, ACCENTS, AND GROUNDCOVERS SHALL NOT EXCEED 30" IN HEIGHT WITHIN SIGHT VISIBILITY TRIANGLES. TREES IN SVTS WILL BE MAINTAINED TO ENSURE THAT BRANCHES/FOLIAGE IS NOT BELOW A HEIGHT OF 6'.
4. IN THE EVENT OF ABANDONMENT OF THE SITE AFTER GRADING/DISTURBANCE OF NATURAL AREAS, DISTURBED AREAS SHALL BE RE-VEGETATED WITH A NON-IRRIGATED HYDROSEED MIX PER TOWN OF ORO VALLEY STANDARDS.
5. CONTRACTOR SHALL VERIFY WITH OWNER'S PROJECT MANAGER THAT PLANS ARE CURRENT AND APPROVED.
6. WORK SHALL BE IN ACCORDANCE WITH THE REQUIREMENTS OF THE ORO VALLEY CODE. WHENEVER SPECIAL REQUIREMENTS CONFLICT ON ANY MATTER, THE OWNER'S PROJECT MANAGER SHALL DETERMINE WHICH SPECIAL CONDITION OR CODE SHALL GOVERN.
7. THE CONTRACTOR SHALL COMPLY WITH THE ENGINEERING SOILS REPORT RECOMMENDATIONS AS THEY RELATE TO HIS WORK.
8. THE CONTRACTOR SHALL OBTAIN ALL NECESSARY AND/OR REQUIRED PERMITS AND PAY ALL RELATED FEES AND/OR TAXES REQUIRED TO INSTALL THE WORK ON THE PLANS.
9. THE CONTRACTOR SHALL BE APPROPRIATELY LICENSED AS REQUIRED BY THE STATE OF ARIZONA.
10. CONTRACTOR SHALL NOTIFY THE OWNER'S PROJECT MANAGER IMMEDIATELY OF ANY ERRORS, OMISSIONS OR DISCREPANCIES IN EXISTING CONDITIONS OR WITH THE PLANS PRIOR TO BEGINNING THE WORK.
11. UNIT PRICES FOR ALL IMPROVEMENTS SHALL BE ESTABLISHED AS A PART OF THE CONTRACT WITH THE OWNER'S PROJECT MANAGER PRIOR TO BEGINNING WORK, TO ACCOMMODATE ADDITIONS AND/OR DELETIONS OF MATERIAL AND/OR LABOR.
12. DETERMINATION OF "EQUAL" SUBSTITUTIONS SHALL BE MADE ONLY BY THE OWNER'S PROJECT MANAGER.
13. SITE OBSERVATION BY THE LANDSCAPE ARCHITECT DURING ANY PHASE OF THIS PROJECT DOES NOT RELIEVE THE CONTRACTOR OF HIS/HER PRIMARY RESPONSIBILITY TO PERFORM ALL WORK IN ACCORDANCE WITH THE PLANS, SPECIFICATIONS AND GOVERNING CODES.
14. THE CONTRACTOR SHALL PROVIDE FULL MAINTENANCE OF ALL LANDSCAPE AREAS AFTER INITIAL WRITTEN APPROVAL. SEE LANDSCAPE SPECIFICATIONS.
15. EXISTING UTILITIES AND STRUCTURES REPORTED BY OWNERS OR OTHERS AND THOSE SHOWN ON RECORDS EXAMINED, ARE INDICATED ON THE PLAN WITH THEIR APPROXIMATE LOCATION AND EXTENT. UNDERGROUND FACILITIES MAY EXIST WHICH HAVE NOT BEEN REPORTED OR OF RECORD. THE CONTRACTOR IS REQUIRED TO TAKE DUE PRECAUTIONARY MEASURES TO PROTECT THOSE FACILITIES FOUND AT THE SITE. IT SHALL BE THE CONTRACTOR'S RESPONSIBILITY TO NOTIFY THE OWNER(S) OF THESE FACILITIES BEFORE STARTING WORK. CAUTION: BEFORE EXCAVATING, VERIFY THE LOCATION OF UNDERGROUND UTILITIES. AT LEAST TWO (2) WORKING DAYS PRIOR TO EXCAVATION, THE CONTRACTOR SHALL REQUEST MARK OUT OF UNDERGROUND UTILITIES BY CALLING BLUE STAKE AT 1-800-782-5348.
16. CONTRACTOR AGREES THAT HE SHALL ASSUME SOLE AND COMPLETE RESPONSIBILITY FOR JOB SITE CONDITIONS DURING THE COURSE OF CONSTRUCTION OF THIS PROJECT. THIS INCLUDES THE SAFETY OF ALL PERSONS AND PROPERTY. THIS REQUIREMENT SHALL APPLY CONTINUOUSLY AND SHALL NOT BE LIMITED TO NORMAL WORKING HOURS. THE CONTRACTOR ALSO AGREES TO DEFEND, INDEMNIFY AND HOLD THE OWNER AND HIS REPRESENTATIVES HARMLESS FROM ANY AND ALL LIABILITY, REAL AND/OR ALLEGED IN CONNECTION WITH THE PERFORMANCE OF WORK ON THIS PROJECT.
17. 1.2 ACRES OF WASH RESTORATION AREA PER THESE PLANS IS TO BE USED AS ESL CREDIT FOR THE MILLER RANCH RESIDENTIAL DEVELOPMENT. IN THE EVENT THAT SALVAGED PLANT MATERIAL FROM THE COMMERCIAL/TECH PARK AREA THAT IS PROPOSED FOR USE WITHIN THE CREDIT AREA AS SHOWN ON THIS PLAN IS UNAVAILABLE AT THE TIME OF WASH RESTORATION IN THE CREDIT AREA, NURSERY STOCK OF LIKE SPECIES MAY BE SUBSTITUTED FOR PROPOSED SALVAGED PLANT MATERIAL. MINIMUM SIZE OF NURSERY STOCK SUBSTITUTIONS SHALL BE 15 GALLON FOR TREES AND 5 GALLON FOR SHRUBS.
18. THE DEVELOPER(S) SHALL POST ASSURANCES FOR WASH RESTORATION PRIOR TO RELEASE OF THE GRADING PERMIT(S). SEPARATE ASSURANCES SHALL BE POSTED FOR EACH PHASE OF WASH RESTORATION.
19. WASH RESTORATION WILL BE COMPLETED PER RE-ZONING CONDITION AND PER TOWN OF ORO VALLEY CLARIFICATION LETTER DATED MARCH 20, 2019. AS STATED IN THE LETTER, "THE PORTION OF THE WASH OWNED BY SCHOOLHOUSE ORO VALLEY LLC AND D.R. HORTON MUST BE RESTORED CONCURRENTLY WITH THE DEVELOPMENT OF THE RESIDENCES AT MILLER RANCH AND BE COMPLETED PRIOR TO 35% OF BUILDING PERMITS WITHIN THE SUBDIVISION BEING ISSUED."


GRADING NOTES

1. THE ARIZONA DEPARTMENT OF AGRICULTURE (AZDA), TUCSON OFFICE, SHALL BE NOTIFIED IN WRITING OF PLANS TO CLEAR, GRADE AND/OR CONDUCT SURFACE DISTURBING ACTIVITIES ASSOCIATED WITH THE PROJECT AT LEAST 30 DAYS IN ADVANCE OF CLEARING AND GRADING ACTIVITIES. NOTIFICATION SHALL BE IN CONFORMANCE WITH THE ARIZONA NATIVE PLANT LAW, ARIZONA REVISED STATUTES, CHAPTER 7, AS ADMINISTERED BY THE AZDA.
2. THE CONTRACTOR SHALL CAUSE THE PROJECT SITE TO BE BLUE-STAKED PRIOR TO THE START OF ANY EXCAVATION OR TRENCHING WORK, AND SHALL BE FAMILIAR WITH PLANS SHOWING UTILITY LOCATIONS. ENGINEERING PLANS SHALL BE REVIEWED TO IDENTIFY THE LOCATIONS OF KNOWN UNDERGROUND UTILITY AND TELEPHONE LINES. BLUE-STAKING SHALL BE KEPT CURRENT DURING THE COURSE OF THE PROJECT.
3. SURFACE DISTURBANCE WITHIN THE WASH RESTORATION AREA SHALL BE MINIMIZED TO THE GREATEST EXTENT POSSIBLE. DISTURBANCE SHOULD GENERALLY BE LIMITED TO EXCAVATION FOR IRRIGATION INSTALLATION AND FOR PLANTING OPERATIONS.
4. SURFACE AREA PREPARATION: SURFACE AREA TO BE DISTURBED BY IRRIGATION INSTALLATION, PLANTING OPERATIONS, OR TRAIL INSTALLATION SHALL BE RAKED AND THE RAKED SURFACE MATERIALS (I.E., ROCK, WOODY DEBRIS, AND VEGETATIVE MATERIALS) SHALL BE SET ASIDE PRIOR TO CONSTRUCTION. THIS MATERIAL SHALL BE EVENLY DISTRIBUTED OVER THE SURFACE OF THE RESTORATION AREA AFTER ALL EXCAVATION, PLANTING, AND IRRIGATION INSTALLATION IS COMPLETE. ROUGH RAKE THE SURFACE TO BLEND WITH ADJACENT UNDISTURBED SOIL SURFACE.
5. LOCATIONS AND OUTLINES OF WATER HARVESTING BASINS SHALL BE FIELD STAKED BY THE CONTRACTOR AND THEN FIELD-EVALUATED AND APPROVED BY THE LANDSCAPE ARCHITECT PRIOR TO ANY SURFACE DISTURBANCE. MINOR ADJUSTMENTS IN LAYOUT MAY BE MADE IN ORDER TO BEST CAPTURE BASIN OUTFLOW AND MINIMIZE DISTURBANCE TO EXISTING VEGETATION.
6. WATER HARVESTING BASIN EXCAVATION:
- BASINS SHALL BE DUG, SHAPED AND CONTOURED USING THE SMALLEST EQUIPMENT POSSIBLE, PREFERABLY HAND TOOLS TO AVOID EXCESSIVE SITE COMPACTION.
 - MAXIMUM DEPTH OF ANY BASIN SHALL NOT EXCEED 4" (BELOW EXISTING GRADE).
 - ROCK AND BOULDERS THAT ARE EXCAVATED SHALL BE UTILIZED IN PLANTING AREAS TO ENHANCE STORMWATER CAPTURE. BROKEN CONCRETE AND OTHER INORGANIC DEBRIS SHALL BE REMOVED FROM SITE.

MAINTENANCE NOTES

1. THE PROJECT OWNER, AND/OR HIS SUCCESSORS, AGREE TO PRESERVE AND PROTECT THE MITIGATION FOR THE DURATION OF THE PROJECT. FURTHER, SAID PROJECT OWNER, OR HIS SUCCESSORS, AGREE TO ACTIVELY MAINTAIN THE MITIGATED AREA FOR A PERIOD OF NOT LESS THAN FIVE YEARS. MAINTENANCE ACTIVITIES SHALL INCLUDE, BUT NOT BE LIMITED TO, THE REGULAR OPERATION OF THE IRRIGATION SYSTEM, THE REPLACEMENT OF DEAD TREES, AND THE REMOVAL OF NON-INDIGENOUS, INVASIVE PLANT SPECIES.
2. PLANTINGS SHALL NOT BE PRUNED EXCEPT IF NECESSARY FOR SAFETY. RESTORATION AREA WILL BE MAINTAINED IN A MANNER THAT PRESERVES ITS NATURAL APPEARANCE AND HABITAT VALUES. MISTLETOE WILL BE LEFT IN TREES.
3. AREAS SHALL NOT BE RAKED OR OTHERWISE CLEARED OF NATURAL DEBRIS EXCEPT AS NECESSARY FOR INVASIVE SPECIES MANAGEMENT.
4. CONTAINER PLANTS WILL BE WEANED OFF IRRIGATION ONCE ESTABLISHED.
5. PLANTING BASINS SHALL BE MONITORED FOR ACCUMULATION OF SEDIMENT AND CLEANED OUT AS NECESSARY.


WASH RESTORATION PLAN FOR:
MILLER RANCH
OV1802195

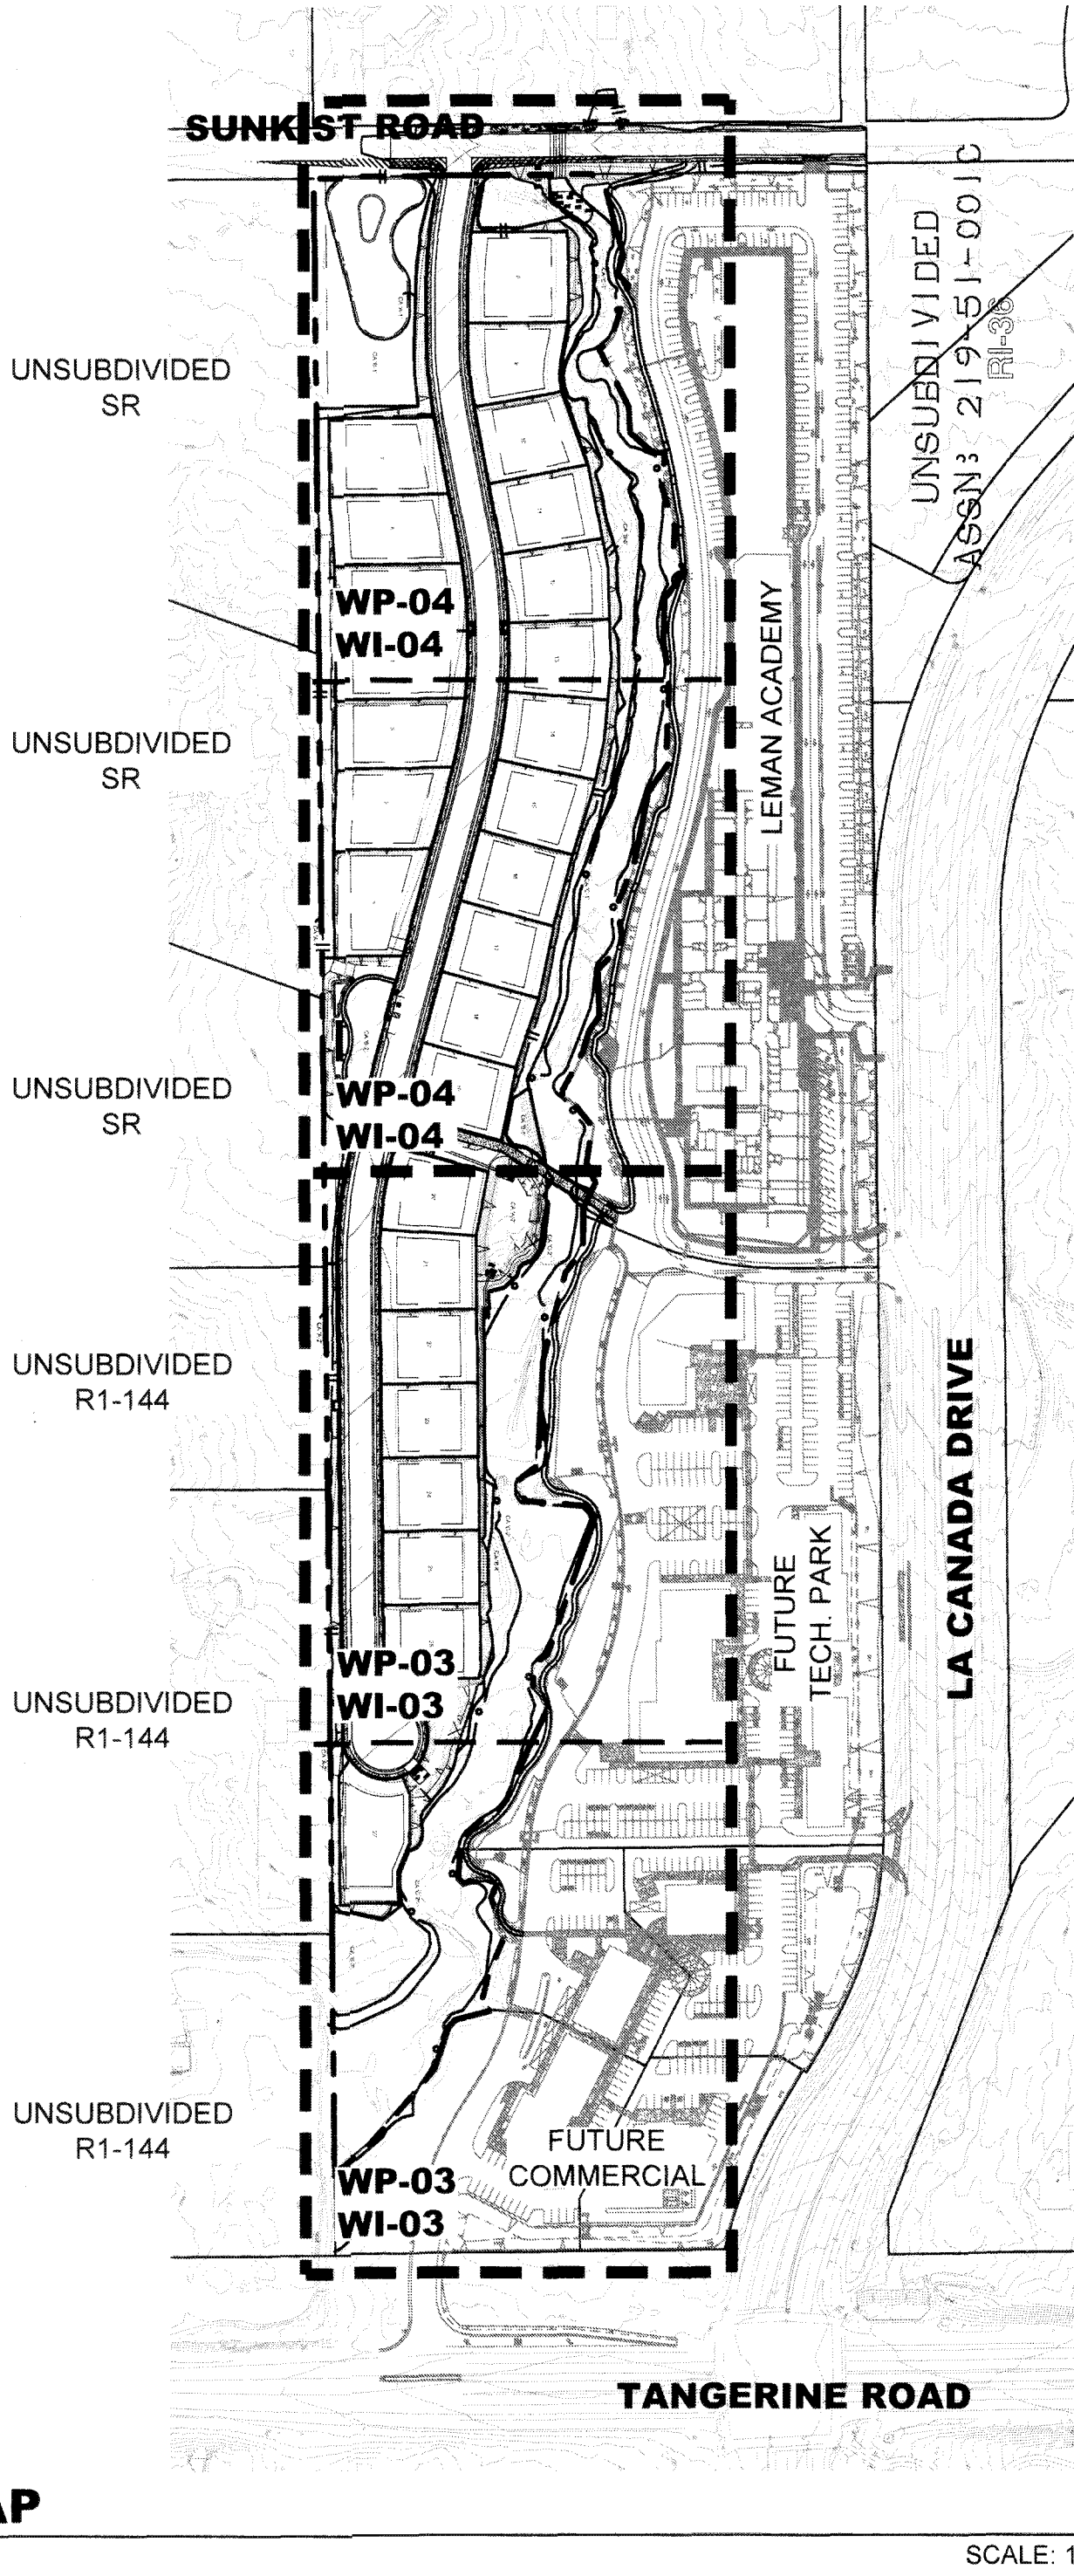

KEY MAP

SYMBOL LEGEND

---	PROPERTY BOUNDARY	---	GRADING LIMIT
---	LOT LINE	---	100 YR. FLOODPLAIN
---	BUILDING SETBACK	---	10 YR. FLOODPLAIN
---	EASEMENT	---	PROPOSED SEWER LINE
---	TOP/TOE OF SLOPE	---	PROPOSED WATER LINE
---	PROPOSED RET. WALL		

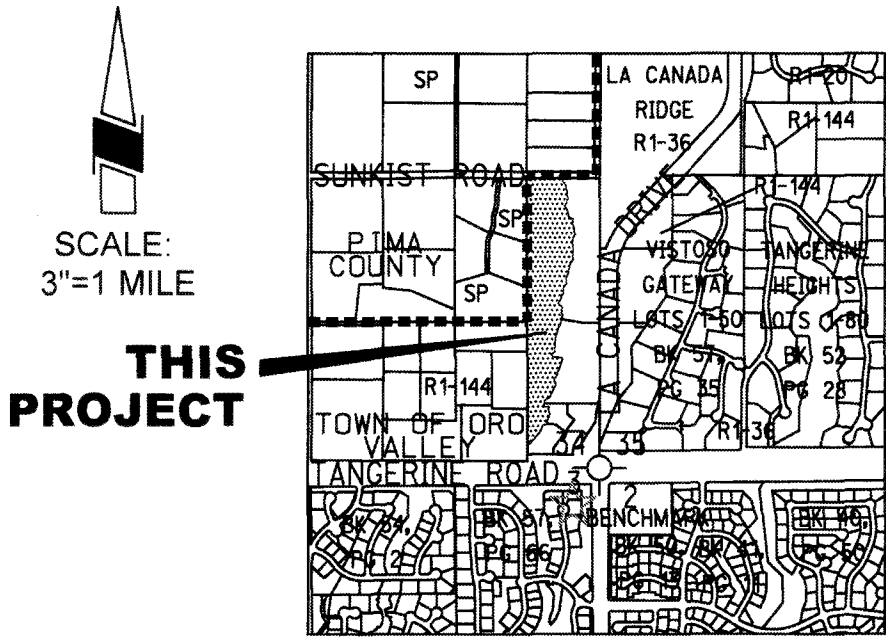

LOCATION MAP
A PORTION OF SECTION 34, T 11 S, R 13 E
G & SRM TOWN OF ORO VALLEY,
PIMA COUNTY, ARIZONA

PROJECT DIRECTORY:

OWNER/DEVELOPER

DESCO - MILLER, LLC.
AN ARIZONA LIMITED LIABILITY COMPANY
1795 E. SKYLINE DRIVE #193
TUCSON, ARIZONA 85718
(520) 297-8929
ATTN: MICHAEL SARABIA

LANDSCAPE ARCHITECT

RICK ENGINEERING CO.
3945 E. FORT LOWELL ROAD, SUITE 111
TUCSON, AZ 85712
CONTACT PERSON: MARK FELLINGER
PHONE: 520-795-1000
FAX: 520-322-6956
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CIVIL ENGINEER

RICK ENGINEERING CO.
3945 E. FORT LOWELL ROAD, SUITE 111
TUCSON, AZ 85712
CONTACT PERSON: PAUL IEZZI
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E-MAIL: piezzi@rickengineering.com

SHEET INDEX

SHT.	#	SHEET DESCRIPTION
WT-01	1	COVER SHEET
WP-01	2	PLANTING LEGEND
WP-02	3	PLANTING NOTES AND DETAILS
WP-03	4	PLANTING PLAN
WP-04	5	PLANTING PLAN
WI-01	6	IRRIGATION LEGEND AND NOTES
WI-02	7	IRRIGATION PLAN
WI-03	8	IRRIGATION PLAN
WI-04	9	IRRIGATION PLAN
WD-01	10	LANDSCAPE DETAILS
WS-1	11	LANDSCAPE SPECIFICATIONS
WS-2	12	LANDSCAPE SPECIFICATIONS
WS-3	13	LANDSCAPE SPECIFICATIONS
WS-4	14	LANDSCAPE SPECIFICATIONS

APPROVAL

By *Mark Felling* 3/12/19
PLANNING AND ZONING
ADMINISTRATOR DATE

REVISIONS PER OV914-006 REVIEW COMMENTS

NO.	BY	DATE
1	MEF	1-12-15
2	MEF	2-13-18

REVISIONS TO REFLECT LEMAN AS-BUILT CONDITIONS AND PROPOSED RESIDENTIAL IMPROVEMENTS

REGISTERED LANDSCAPE ARCHITECT

36734

MARK E. FELLINGER

7/24/19

ARIZONA

M. Felling

3945 EAST FORT LOWELL ROAD - SUITE 111
TUCSON, AZ 85712
520-795-1000
(520) 322-6956
Phoenix - San Diego - Sacramento - Riverside - Orange - San Luis Obispo - Bakersfield

RICK ENGINEERING COMPANY

TUCSON

DESIGNED: MEF
DRAWN: MEF

CHECKED BY:
APPROVED BY:

DATE: 7/19
DATE: 7/19

WASH RESTORATION PLANS PREPARED FOR:
MASTER SUBMITAL
MILLER RANCH
BEING A PORTION OF THE SOUTHEAST QUARTER OF
SECTION 34, TOWNSHIP 11 SOUTH, RANGE 13 EAST
GILA & SALT RIVER MERIDIAN, PIMA COUNTY, ARIZONA

OV1802195
REFERENCE:
OV914-006, OV1113-003,
OV114-020, OV1208-07,
OV1208-7A, OV904-02,
OV1800713, OV1702695,
(O)18-09, (R)14-10

WT-01

SCALE : 1" = 200'

SHEET 1 OF 14

PLANT DENSITY CALCULATIONS

GROSS WASH RESTORATION AREA * : 6.3 ACRES

AREA OF 10-YEAR FLOODPLAIN: 2.4 ACRES

NET WASH RESTORATION AREA ** : 3.9 ACRES

* GROSS WASH RESTORATION AREA IS AREA FROM PARKING LOTS/VEHICULAR ACCESS DRIVES TO RESIDENTIAL LOTS.

** NET WASH RESTORATION AREA IS GROSS AREA MINUS AREA OF 10-YEAR FLOODPLAIN.

PROPOSED TREE QUANTITY:
(EXCLUDING EXISTING TREES TO REMAIN IN PLACE) 263

PROPOSED SHRUB QUANTITY:
(EXCLUDING EXISTING SHRUBS TO REMAIN IN PLACE) 991

PROPOSED TREES PER ACRE: 67

PROPOSED SHRUBS PER ACRE: 254

NON-IRRIGATED HYDROSEED MIX "A"

	SPECIES	PLS RATE LBS./ACRE
	ACACIA CONSTRICTA, WHITETHORN ACACIA	2.0
	AMBROSIA DELTIODEA, TRIANGLE LEAF BURSAGE	2.0
	ARISTIDA PURPUREA, PURPLE THREE-AWN	1.0
	ATRIPLEX CANESCENS, FOUR-WING SALTBUSH	2.0
	BAHIA ABSINTHIFOLIA, DESERT BAHIA	1.0
	BAILEYA MULTIRADIATA, DESERT MARIGOLD	1.5
	BOTHRIOCHLOA BARBINODIS, CANE BEARDGRASS	1.0
	BOUTELOUA CURTIPENDULA, SIDE-OATS GRAMA	1.0
	BOUTELOUA BARBATA, SIX WEEKS GRAMA	1.0
	ENCELIA FARINOSA, BRITTLEBUSH	2.0
	KALLSTROEMIA GRANDIFLORA, ARIZONA POPPY	1.0
	LARREA DIVARICATA, CREOSOTE	2.0
	LEPTOCHLOA DUBIA, GREEN SPRANGLETOP	1.0
	LUPINUS SPARSIFLORUS, DESERT LUPINE	1.0
	MUHLENBERGIA PORTERI, BUSH MUHLY	1.0
	PENSTEMON PARRYI, DESERT PENSTEMON	1.5
	PLANTAGO INSULARIS, INDIAN WHEAT	1.5
	PROBOSCIDEA PARVIFLORA, DEVIL'S CLAW	1.0
	SENNA COVESII, DESERT SENNA	1.0
	SPHAERALCEA AMBIGUA, DESERT GLOBE-MALLOW	2.0
	SPOROBOLUS CRYPTANDRUS, SAND DROPSEED	1.0
TOTAL LBS./ACRE:		28.5 TOTAL
TOTAL ACRES:		3.58 AC (156,012 SF)




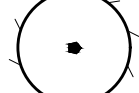



NON-IRRIGATED HYDROSEED MIX "B"

	SPECIES	PLS RATE LBS./ACRE
	ARISTIDA PURPUREA, PURPLE THREE-AWN	1.0
	BAHIA ABSINTHIFOLIA, DESERT BAHIA	1.0
	BAILEYA MULTIRADIATA, DESERT MARIGOLD	1.5
	BOUTELOUA CURTIPENDULA, SIDE-OATS GRAMA	1.0
	KALLSTROEMIA GRANDIFLORA, ARIZONA POPPY	1.0
	LUPINUS SPARSIFLORUS, DESERT LUPINE	1.0
	PLANTAGO INSULARIS, INDIAN WHEAT	1.5
	SPOROBOLUS CRYPTANDRUS, SAND DROPSEED	1.0
TOTAL LBS./ACRE:		9.0 TOTAL
TOTAL ACRES:		0.64 AC (27,982 SF)

HYDROSEED NOTES:


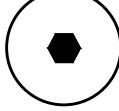
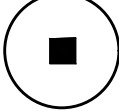





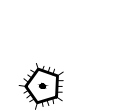

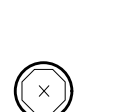
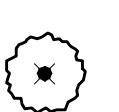



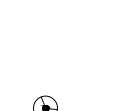






1. SLURRY MIX FOR NATIVE SEED APPLICATION SHALL CONSIST OF THE FOLLOWING:
- | | |
|---|------------------------|
| SEED | =LBS/ACRE PER SEED MIX |
| WOOD FIBER MULCH | =2000 LBS/ACRE |
| AMMONIUM PHOSAPhte FERTILIZER (16-20-0) | =200 LBS/ACRE |
2. SURFACE DISTURBANCE WITHIN THE WASH RESTORATION AREA SHALL BE MINIMIZED TO THE GREATEST EXTENT POSSIBLE. DISTURBANCE SHOULD GENERALLY BE LIMITED TO EXCAVATION FOR IRRIGATION INSTALLATION AND FOR PLANTING OPERATIONS. DO NOT TILL SOIL SURFACE PRIOR TO HYDROSEEDING. DIRECT HYDROSEEDING OF SURFACE IS PREFERRED.
3. THIS SEED MIX WILL NOT BE IRRIGATED. APPLICATION OF SEED MIX SHALL COINCIDE WITH PERIODS OF SEASONAL RAIN (JULY-AUGUST OR NOVEMBER-DECEMBER) IN ORDER TO ENCOURAGE GERMINATION.

PLANT MATERIAL LEGEND

SYMBOL	BOTANICAL NAME COMMON NAME		QTY.	SIZE	H x W (CALIPER)	WATER USE TYPE	ADWR ANNUAL USE (GAL.)	ANNUAL USE (GAL.)	MONTHLY USE (GAL.)
TREES									
	CERCIDIUM FLORIDUM BLUE PALO VERDE		32	15 GAL.	6' x 2' (.75 ")	2	5,702	182,464	15,205
	CERCIDIUM MICROPHYLLUM FOOTHILLS PALO VERDE		62	15 GAL.	4' x 2' (.5 ")	1	1,754	108,748	9,062
	CHILOPSIS LINEARIS DESERT WILLOW		63	24" BOX	7' x 4' (1.25")	2	5,702	359,226	29,935
	OLNEYA TESOTA IRONWOOD		43	15 GAL.	3' x 2' (.75 ")	1	2,741	117,863	9,822
	PROSOPIS VELUTINA VELVET MESQUITE		63	15 GAL.	5.5' x 3' (.5")	2	5,702	359,226	29,935
	EXISTING TREE TO REMAIN		55 +/-	BASED ON 2008 INVENTORY CONDUCTED BY RICK ENGINEERINGAND CURRENT AERIAL PHOTO ANALYSIS		(N/A - NOT IRRIGATED)			
						TOTAL (GAL.)	1,127,527	93,961	

PLANTING NOTES:

IF SEASONAL VARIATIONS IN PLANT MATERIAL AVAILABILITY NECESSITATE SUBSTITUTION OF CONTAINER PLANT OR SEED MIX SPECIES, THE SPECIES DIVERSITY (NUMBER OF SPECIES) PRESENTED IN THE PLAN MUST BE MAINTAINED. ANY NEW SPECIES MUST BE NATIVE, SITE-APPROPRIATE, AND APPROVED BY THE TOWN OF ORO VALLEY.

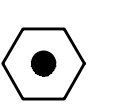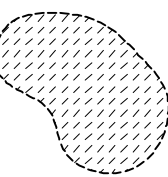SYMBOL	BOTANICAL NAME COMMON NAME	 QTY.	SIZE	WATER USE TYPE	ADWR ANNUAL USE (GAL.)	ANNUAL USE (GAL.)	MONTHLY USE (GAL.)
SHRUBS							
	ACACIA CONSTRICTA WHITETHORN ACACIA	98	5 GAL.	1	1,754	171,892	14,324
	ACACIA GREGGII CATCLAW ACACIA	63	5 GAL.	1	1,754	110,502	9,209
	AMBROSIA DELTOIDEA TRIANGLE-LEAF BURSAGE	48	1 GAL.	3	39	1,872	156
	CALLIANDRA ERIOPHYLLA FAIRY DUSTER	66	1 GAL.	1	70	4,620	385
	CELTIS PALLIDA DESERT HACKBERRY	80	5 GAL.	2	634	51,274	4,273
	CLEMATIS DRUMMONDII VIRGIN'S BOWER	29	1 GAL.	2	35	1,015	85
	CYLINDROPUNTIA FULGIDA CHAINFRUIT CHOLLA	15	5 GAL.	1	158	2,370	198
	ECHINOCEREUS SPP. HEDGEHOG CACTUS	15	5 GAL.	1	18	270	23
	ENCELIA FARINOSA BRITTLE BUSH	147	1 GAL.	1	39	5,733	478
	HYMENOCLEA SALSOLA BURROBRUSH	51	1 GAL.	1	281	14,331	1,194
	LYCIUM FREMONTII WOLFBERRY	39	5 GAL.	1	281	10,959	913
	MAMMILLARIA SPP. PINCUSHION CACTUS	20	5 GAL.	1	1	20	2
	MUHLENBERGIA EMERSLEYI BULL GRASS	18	1 GAL.	1	110	1,980	165
	OPUNTIA SPP. PRICKLY PEAR CACTUS	25	5 GAL.	1	158	3,950	329
	PENSTEMON PARRYI PARRY'S PENSTEMON	41	1 GAL.	2	57	2,337	195
	PSILOSTROPHE COOPERI PAPER FLOWER	87	1 GAL.	2	25	2,175	181
	SIMMONDSIA CHINENSIS JOJOBA	30	5 GAL.	1	281	8,430	703
	SPOROLOBUS CRYPTANDRUS SAND DROPSEED	40	1 GAL.	3	9	360	30
	YUCCA ELATA SOAPTREE YUCCA	22	5 GAL.	1	281	6,182	515
	ZIZYPHUS OBTUSIFOLIA GRAY THORN	57	5 GAL.	2	634	36,138	3,012
	EXISTING SHRUBS TO REMAIN	175 +/-	BASED ON 2008 INVENTORY CONDUCTED BY RICK ENGINEERING AND CURRENT AERIAL PHOTO ANALYSIS		(N/A - NOT IRRIGATED)		
				TOTAL (GAL.)	438,487	36,540	

TOTAL WATER USE AT MATURITY	ANNUAL USE (GAL.)	MONTHLY USE (GAL.)
TREES	1,127,527	93,961
SHRUBS	438,487	36,540
TOTAL	1,566,014	130,501

REVISIONS TO REFLECT LEMAN AS-BUILT CONDITIONS AND PROPOSED RESIDENTIAL IMPROVEMENTS

2-13-18

MEF

DATE

NO.

BY

REVISION

3668

3945 EAST FORT LOWELL ROAD, SUITE 111
TUCSON, AZ 85712
520.995.0000
(FAX) 520.322.6956

RICK
ENGINEERING COMPANY
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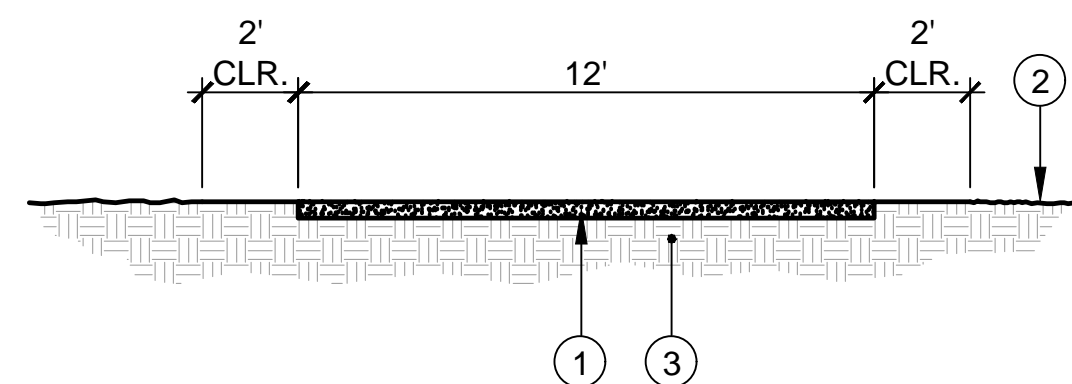
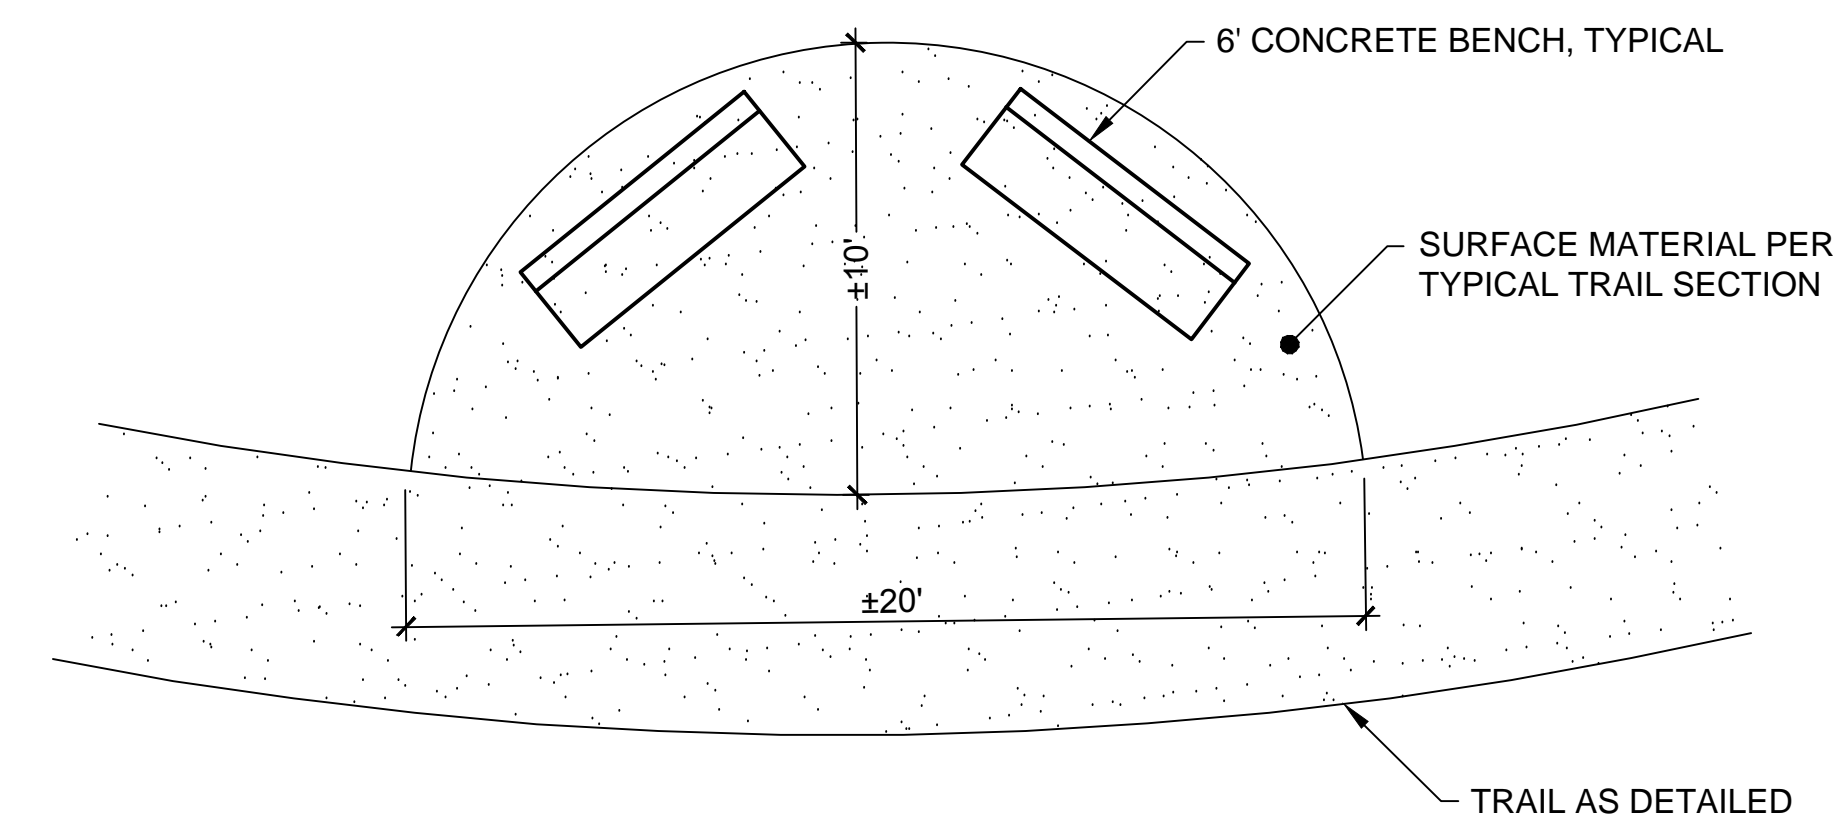
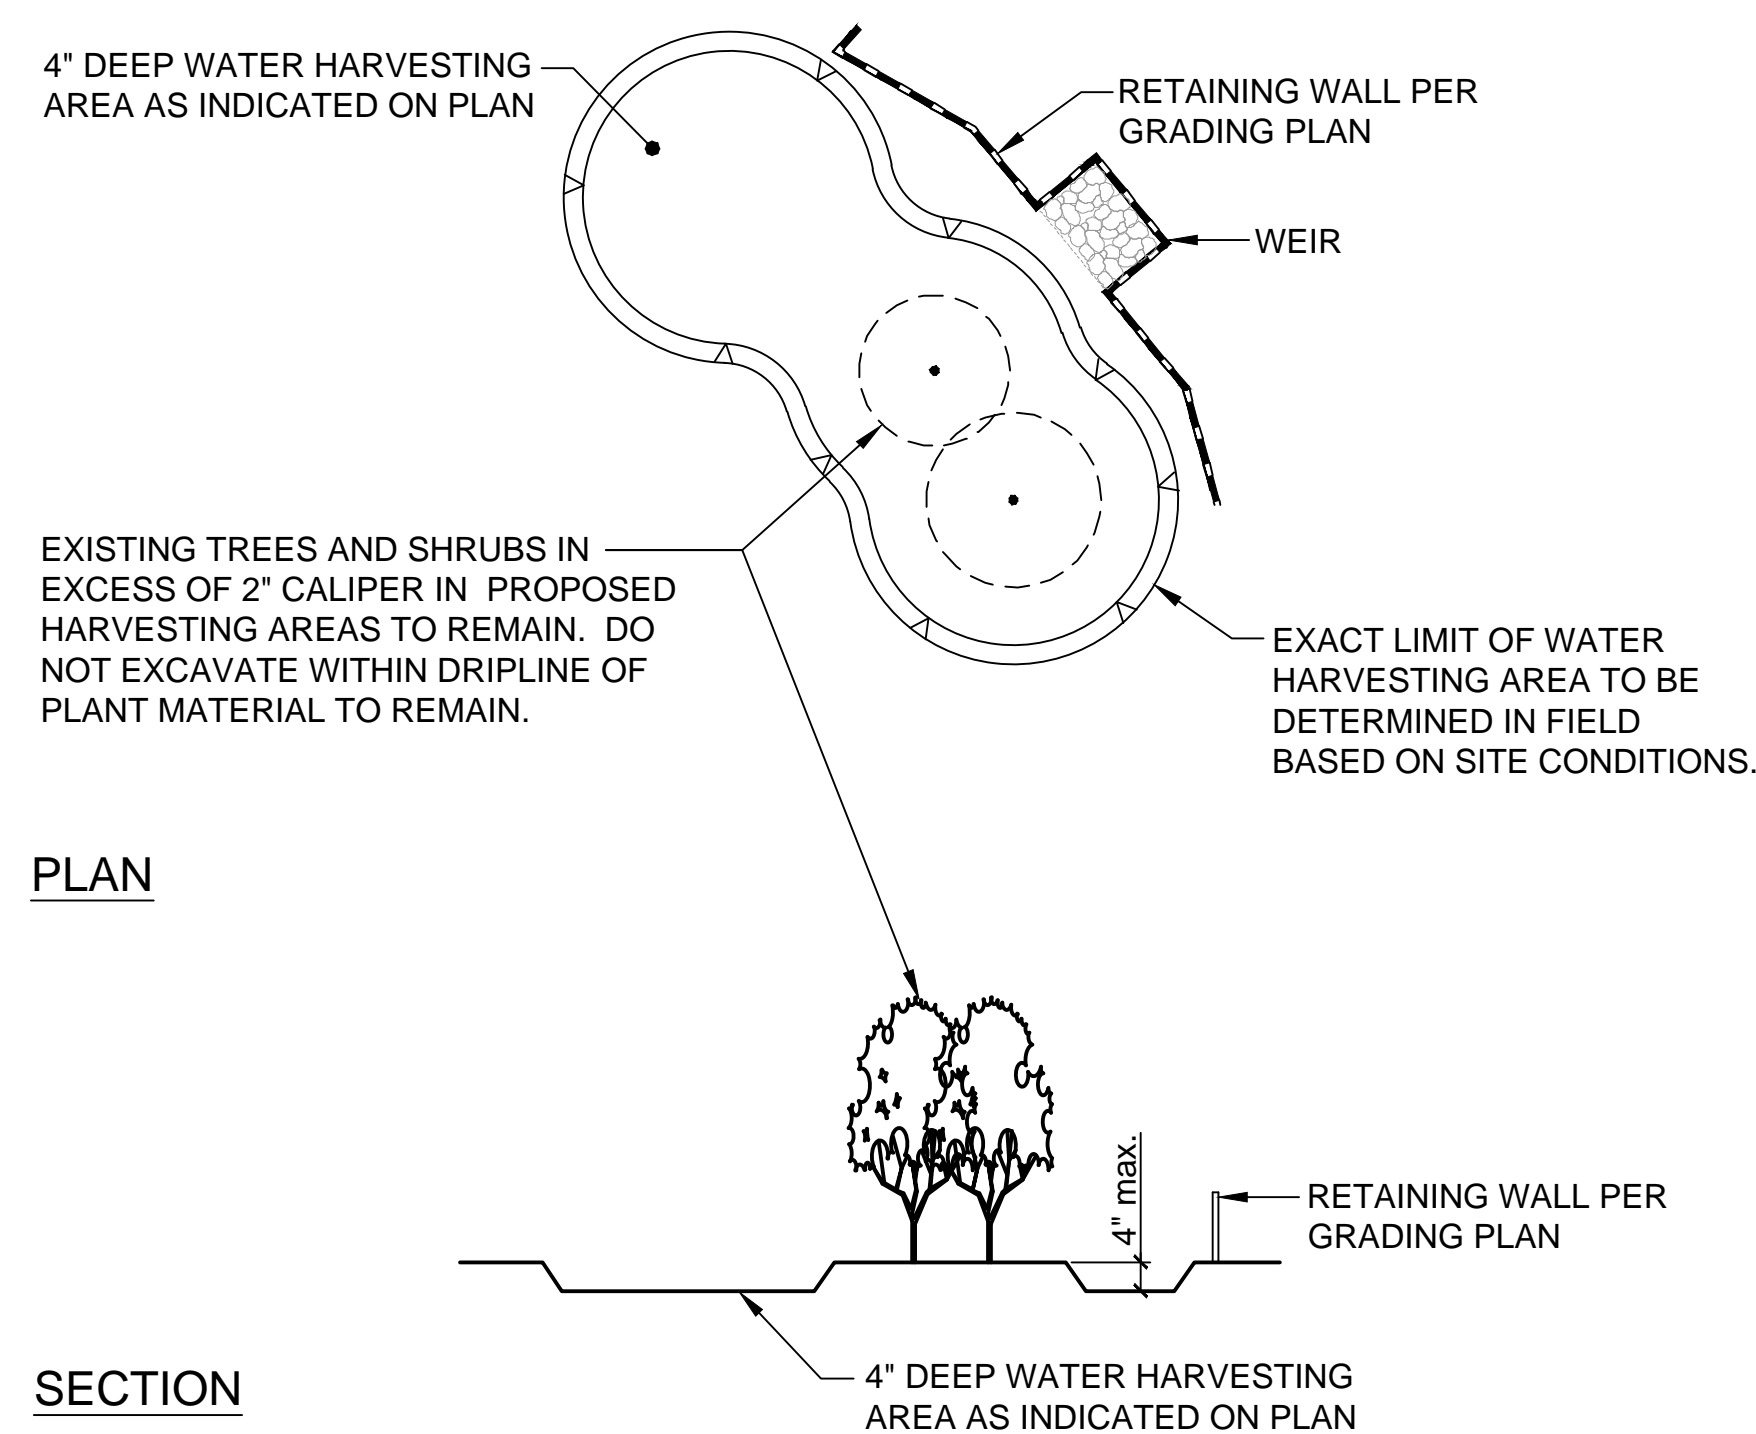
WASH RESTORATION PLANS PREPARED FOR:
MASTER SUBMITTAL
MILLER RANCH
BEING A PORTION OF THE SOUTHEAST QUARTER OF SECTION 34, TOWNSHIP 11 SOUTH, RANGE 13 EAST, GILA & SALT RIVER MERIDIAN, PIMA COUNTY, ARIZONA

OV1802195
REFERENCE:
OV914-006, OV1113-003,
OV114-020, OV1208-07,
OV1208-7A, OV904-02,
OV1800713, OV1702695,
(O)18-09, (R)14-10

WP-01

SCALE : N/A

SHEET 2 OF 14





- ① DG TRAIL 2" THICK LAYER OF 1/4" MINUS DECOMPOSED GRANITE OVER 95% COMPACTED NATIVE SOIL. DG SHALL BE INSTALLED IN 1" LIFTS WITH EACH LIFT MOISTENED AND COMPACTED TO 95%. DG COLOR SHALL BE 'DESERT GOLD' OR EQUAL UNLESS OTHERWISE SPECIFIED ON PLANS.
- ② FINISH GRADE
- ③ NATIVE SOIL SUBGRADE. COMPACT TO 95% FOR WIDTH OF TRAIL, PLUS 2' ON EITHER SIDE OF TRAIL.

- INVASIVE SPECIES MANAGEMENT NOTES

1. INVASIVE SPECIES HAVE BEEN IDENTIFIED FOR REMOVAL. INVASIVE SPECIES MANAGEMENT WILL OCCUR DURING CONSTRUCTION AS WELL AS THROUGH THE LIFE OF THE PROJECT. INDIVIDUAL SPECIES SHALL BE REMOVED AS INDICATED IN THE INVASIVE SPECIES MANAGEMENT TABLE.
2. IF HERBICIDE APPLICATION IS NECESSARY, IT SHALL BE APPLIED DIRECTLY TO INDIVIDUAL PLANTS AND NOT BROADCAST ON THE SOIL. HERBICIDE WILL BE APPLIED ONLY BY PERSONNEL WITH ALL CURRENT AND APPLICABLE APPLICATOR LICENSING FROM THE STATE OF ARIZONA. HERBICIDES SHALL BE APPLIED ACCORDING TO MANUFACTURER'S LABEL, AND ALL APPLICABLE SAFE-HANDLING MEASURES SHALL BE FOLLOWED.
3. THE RESTORATION SITE WILL BE MONITORED FOR INVASIVE SPECIES FOR FIVE YEARS FOLLOWING CONSTRUCTION. AREAS THAT HAVE BEEN TREATED FOR INVASIVE SPECIES SHOULD BE CLOSELY MONITORED FOR RESPROUTING AND/OR SEEDLING GERMINATION; APPROPRIATE CONTROL METHODS SHOULD BE PROMPTLY APPLIED. THE RESTORATION AREA'S COVER OF INVASIVE NON-NATIVE PLANT SPECIES WILL NOT EXCEED AN ABSOLUTE VALUE OF 5 PERCENT.

INVASIVE SPECIES MANAGEMENT TABLE

SPECIES	MECHANICAL TREATMENT	CHEMICAL TREATMENT	TIMING	IMPORTANT CONSIDERATIONS
BUFFELGRASS	REMOVE INDIVIDUAL PLANTS BY SHOVEL OR DIGGING BAR IMMEDIATELY. INFLORESCENCES SHOULD BE CLIPPED AND SECURELY BAGGED PRIOR TO DIGGING TO REDUCE THE NUMBER OF SEEDS THAT ESCAPE.	GLYPHOSATE	TREAT WITH GLYPHOSATE WHILE PLANT IS ACTIVELY GROWING.	FOLLOW UP CONTROL SHOULD OCCUR AT LEAST TWICE PER YEAR
BERMUDA GRASS	MULCHING OR SOLARIZATION	GLYPHOSATE	MULCHING/SOLARIZATION METHODS MUST OCCUR DURING HOT SUMMER MONTHS. GLYPHOSATE APPLICATION SHOULD OCCUR DURING VIGOROUS ACTIVE GROWTH.	FOLLOW UP CONTROL SHOULD OCCUR AT LEAST TWICE PER YEAR
LEHMANN'S LOVEGRASS	REMOVE INDIVIDUAL PLANTS BY SHOVEL OR DIGGING BAR.	SPOT APPLICATIONS OF HERBICIDES MAY BE USED AS DEEMED NECESSARY		
FOUNTAIN GRASS	REMOVE INDIVIDUAL PLANTS BY SHOVEL OR DIGGING BAR IMMEDIATELY. INFLORESCENCES SHOULD BE CLIPPED AND SECURELY BAGGED PRIOR TO DIGGING TO REDUCE THE NUMBER OF SEEDS THAT ESCAPE.	GLYPHOSATE	TREAT WITH GLYPHOSATE WHILE PLANT IS ACTIVELY GROWING.	FOLLOW UP CONTROL SHOULD OCCUR AT LEAST TWICE PER YEAR

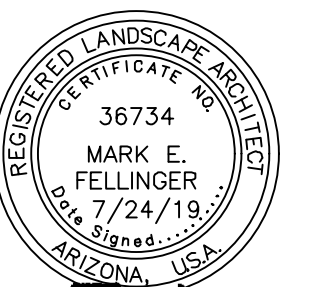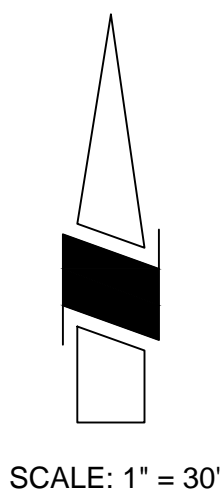

M. Felig

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Tucson

DESIGNED: MEF	DATE: 7/19	CHECKED BY:	DATE:
DRAWN: MEF	DATE: 7/19	APPROVED BY:	DATE:

WASTEWATER TREATMENT PLANT PREPARED FOR:
MASTER SUBMITTAL
MILLER RANCH
BEING A PORTION OF THE SOUTHEAST QUARTER OF
SECTION 34, TOWNSHIP 11 SOUTH, RANGE 13 EAST
GILA & SALT RIVER MERIDIAN, PIMA COUNTY, ARIZONA


OV1802195
REFERENCE:
OV914-006, OV1113-003,
OV114-020, OV1208-07,
OV1208-7A, OV904-02,
OV1800713, OV1702695,
OV118-09, (R)14-10

WP-02

SCALE : N/A

SHEET 3 OF 14

SHEET INDEX

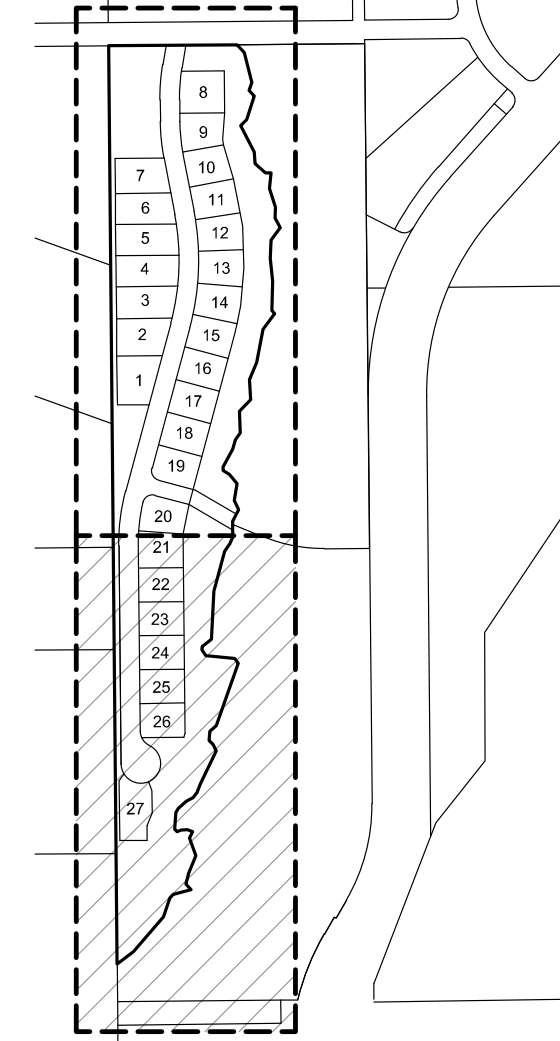


WASH RESTORATION PHASING:
PHASE 1 SHALL BE COMPLETED CONCURRENTLY
WITH RESIDENTIAL SUBDIVISION.
PHASE 2 SHALL BE COMPLETED WITH FUTURE
COMMERCIAL AND TECH. PARK DEVELOPMENT.

RETAINING WALL
PER GRADING PLAN,
TYPICAL





TANGERINE ROAD

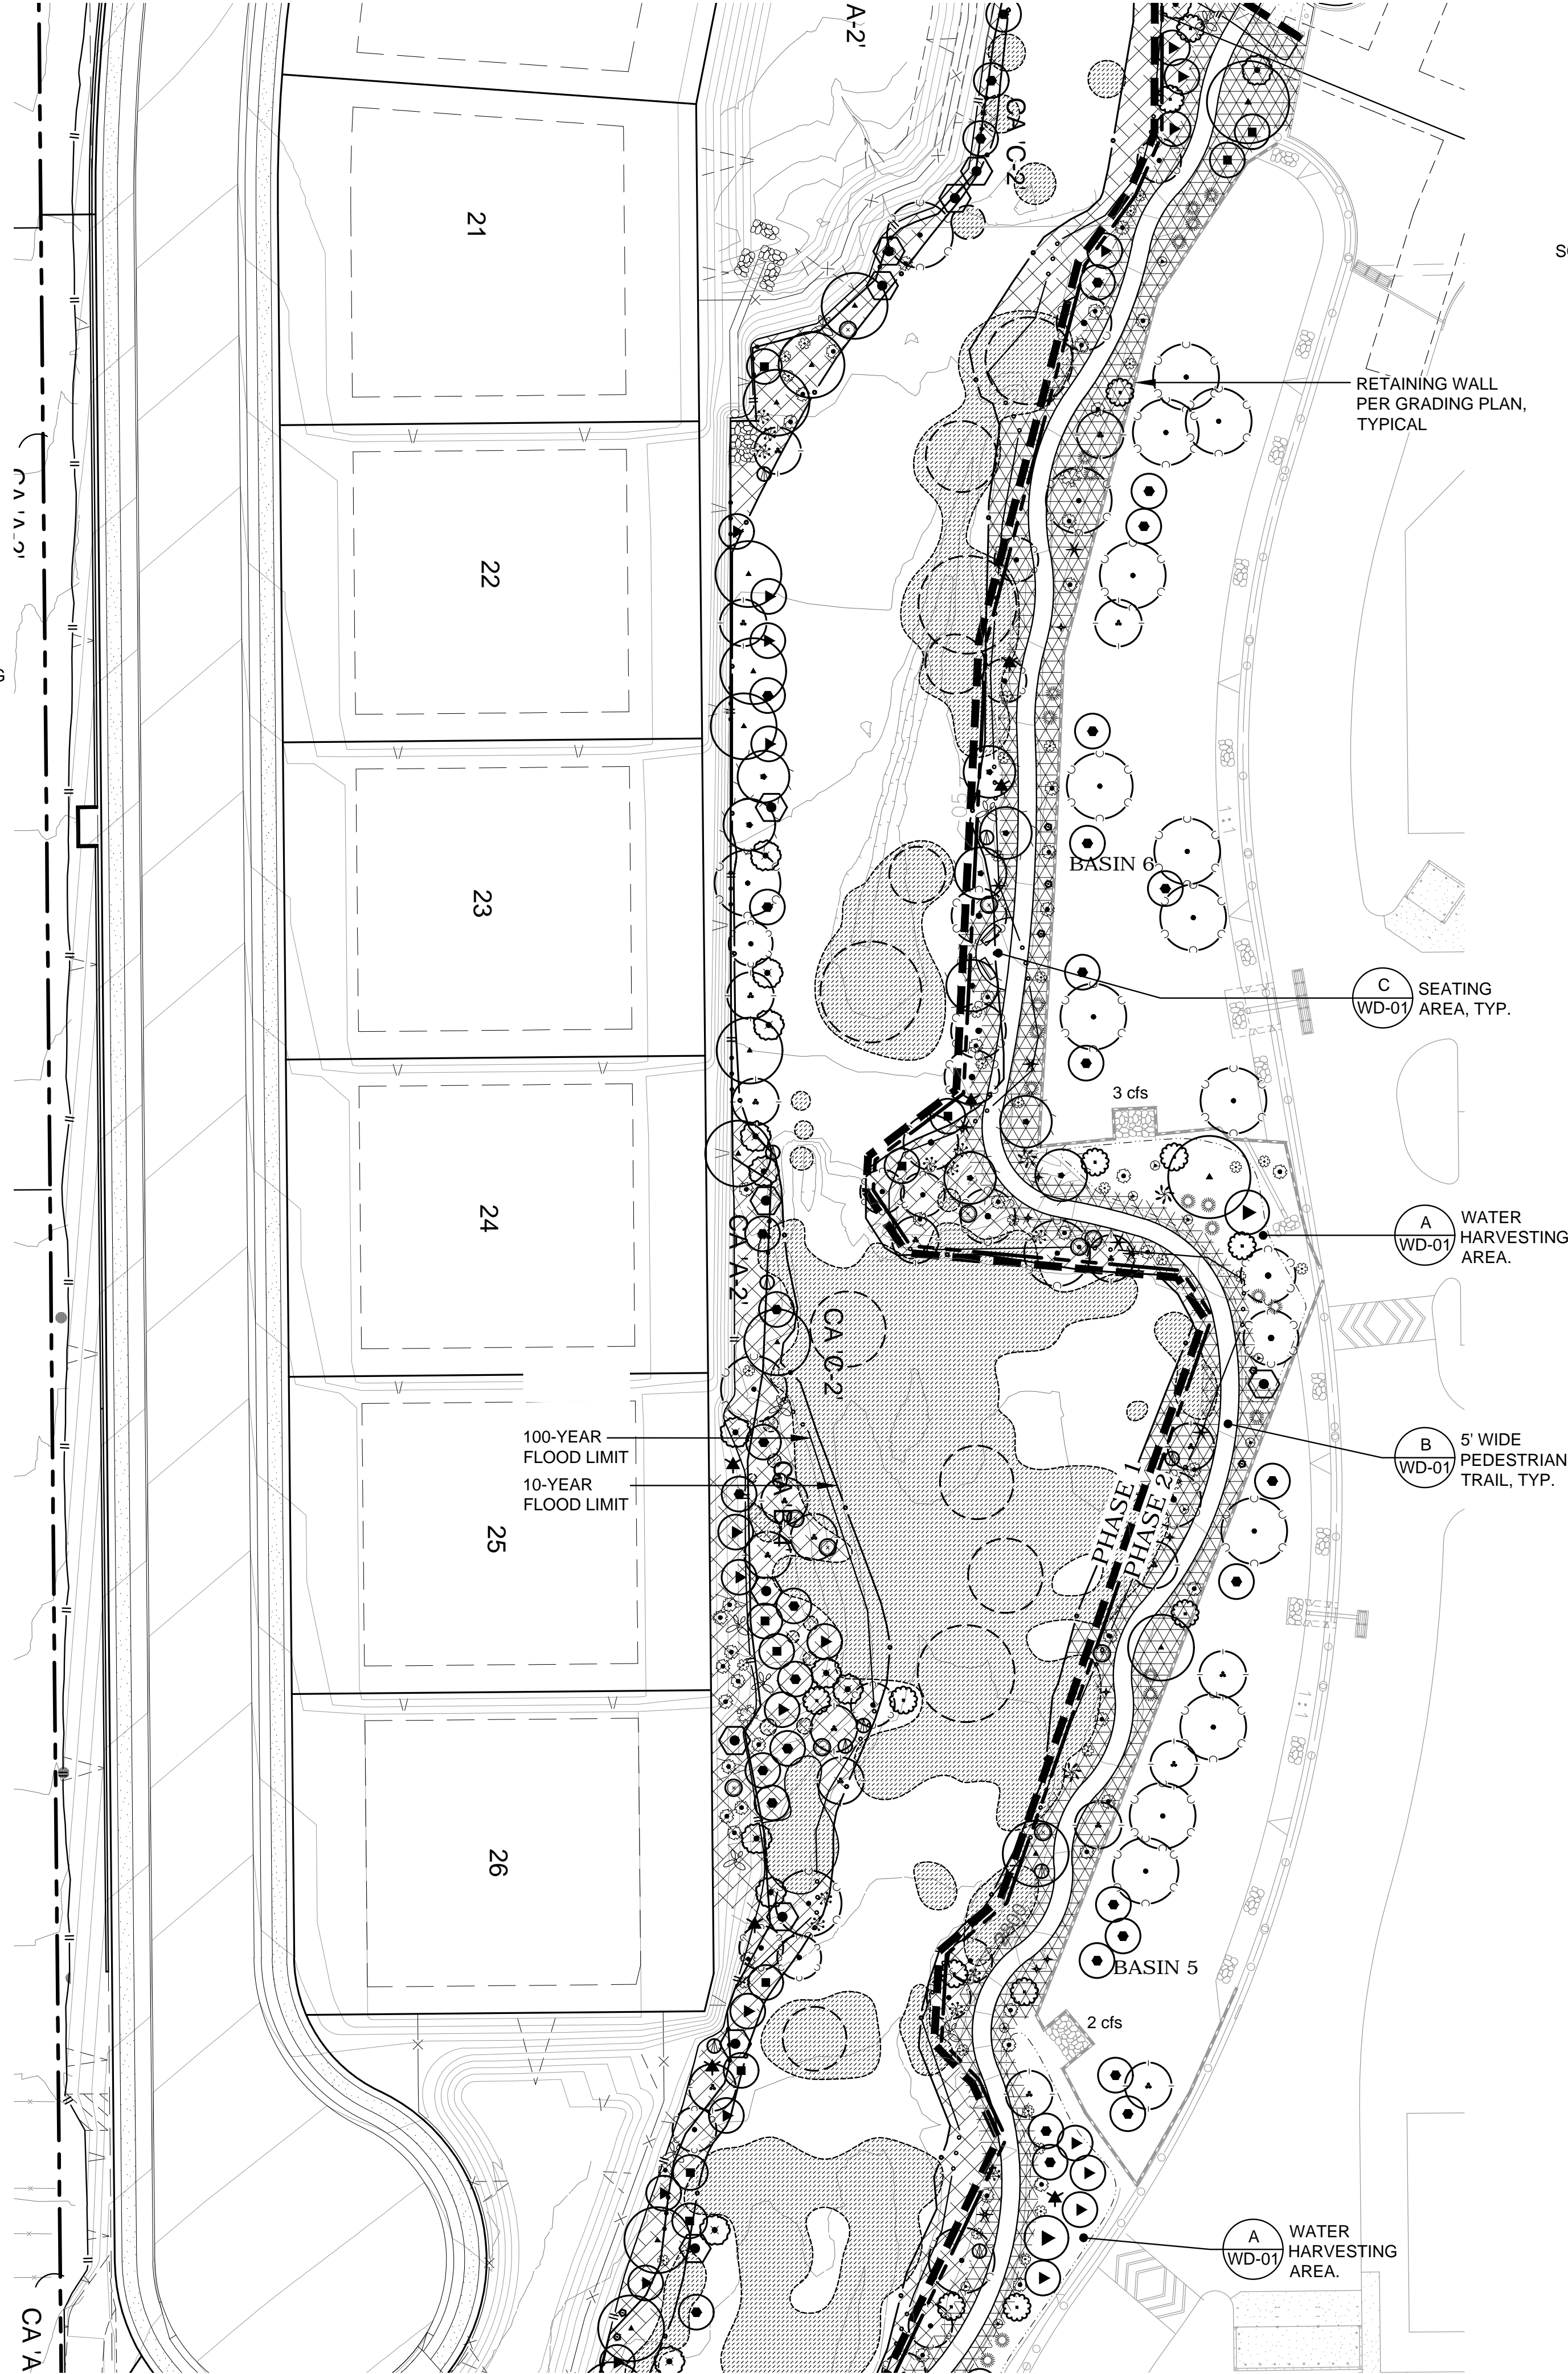

SCALE: 1" = 30'

WASH RESTORATION PLANS PREPARED FOR: MASTER SUBMITTAL MILLER RANCH BEING A PORTION OF THE SOUTHEAST QUARTER OF SECTION 34, TOWNSHIP 11 SOUTH, RANGE 13 EAST GILA & SALT RIVER MERIDIAN, PIMA COUNTY, ARIZONA		OV1802195 REFERENCE: OV914-006, OV1113-003, OV114-020, OV1208-07, OV1208-7A, OV904-02, OV1800713, OV1702695, (O)18-09, (R)14-10		WP-03	
DESIGNED: MEF DRAWN: MEF		DATE: 7/19 DATE: 7/19		CHECKED BY: APPROVED BY:	
RICK ENGINEERING COMPANY Tucson		3945 EAST FORT LOWELL ROAD - SUITE 111 TUCSON, AZ 85712 520.995.0000 (FAX) 520.322.6956 Project: San Diego - Sacramento - Riverside - Orange - San Luis Obispo - Saltwater		JUN 36681	
REVISIONS PER OV914-006 REVIEW COMMENTS		REVISIONS TO REFLECT LEMAN AS-BUILT CONDITIONS AND PROPOSED RESIDENTIAL IMPROVEMENTS		ADDED PHASE LINE	
NO. BY		DATE		REVISION	

SHEET INDEX

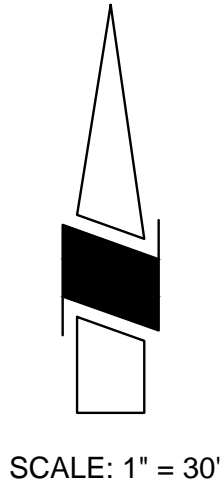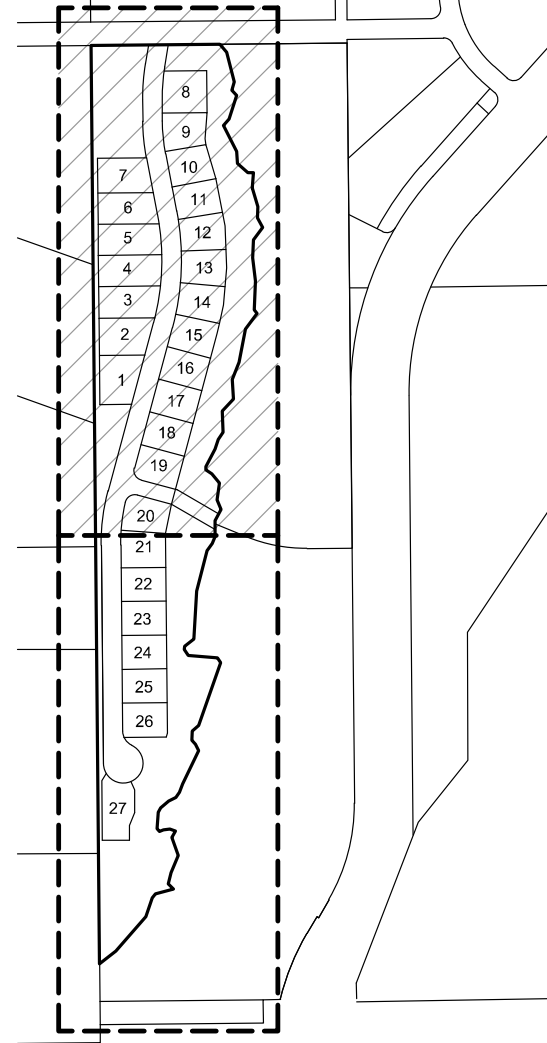

WASH RESTORATION PLANS PREPARED FOR: MASTER SUBMITTAL MILLER RANCH BEING A PORTION OF THE SOUTHEAST QUARTER OF SECTION 34, TOWNSHIP 11 SOUTH, RANGE 13 EAST GILA & SALT RIVER MERIDIAN, PIMA COUNTY, ARIZONA		OV1802195 REFERENCE: OV914-006, OV1113-003, OV114-020, OV1208-07, OV1208-7A, OV904-02, OV1800713, OV1702695, (O)18-09, (R)14-10		WP-04	
DESIGNED: MEF DRAWN: MEF		DATE: 7/19	CHECKED BY: MEF	APPROVED BY: MEF	DATE: 7/19
3945 EAST FORT LOWELL ROAD - SUITE 111 TUCSON, AZ 85712 520.795.0000 (FAX) 520.322.6956 rickengineering.com Tucson		JUN 36681		REVISIONS PER OV914-006 REVIEW COMMENTS REVISIONS TO REFLECT LEMAN AS-BUILT CONDITIONS AND PROPOSED RESIDENTIAL IMPROVEMENTS ADDED PHASE LINE	
RICK ENGINEERING COMPANY		M. E. FELLINGER REGISTERED LANDSCAPE ARCHITECT 36734 7/24/19 ARIZONA, USA		SCALE : 1" = 30'	
SHEET 5 OF 14		NO.		BY	
DATE		DATE		REVISION	

IRRIGATION NOTES

WATER SOURCE

1.

THE IRRIGATION P.O.C. SHALL BE AT NEW RECLAIMED WATER METER AS SHOWN. VERIFY LOCATION IN FIELD.
2.

THE IRRIGATION SYSTEM IS DESIGNED TO OPERATE AT 50 PSI AT THE POINT OF CONNECTION. THE IRRIGATION SYSTEM IS DESIGNED TO OPERATE WITH ONLY ONE VALVE OPEN AT A TIME.
3.

THE CONTRACTOR SHALL VERIFY THE WATER PRESSURE IN THE FIELD PRIOR TO PURCHASE OF ANY EQUIPMENT AND PERFORMING ANY INSTALLATIONS, IF THE PRESSURE IS NOT AS STATED ABOVE, THE CONTRACTOR SHALL CONTACT THE LANDSCAPE ARCHITECT FOR INSTRUCTIONS BEFORE PROCEEDING. PROCUREMENT AND/OR INSTALLATION OF ANY IRRIGATION EQUIPMENT WITHOUT VERIFICATION OF SATISFACTORY WATER PRESSURE SHALL BE AT THE SOLE RESPONSIBILITY OF THE CONTRACTOR.
4.

ALL WATER USE FOR LANDSCAPE IRRIGATION AND ENHANCEMENT SHALL CONFORM TO THE ARIZONA GROUNDWATER CODE, ARIZONA REVISED STATUTES TITLE 45, CHAPTER 2.

GENERAL

1.

DRAWINGS ARE DIAGRAMMATIC. THE SCALE OF THE PLANS SOMETIMES MAKES IT NECESSARY TO SHOW IRRIGATION PIPELINES WITHIN BUILDINGS, WALKS OR OTHERWISE OUTSIDE OF PLANTING AREAS. THIS IS ONLY FOR CLARITY OF THE PLANS. ALL IRRIGATION EQUIPMENT SHALL BE INSTALLED IN PLANTER AREAS WHEREVER POSSIBLE.
2.

UNLESS OTHERWISE SPECIFIED ON THE PLANS: ALL LATERAL END RUNS ARE TO BE 3/4"; MAINLINE IS TO BE TO BE 1" UNLESS OTHERWISE SPECIFIED ON PLAN; ALL PIPE SHALL BE DOWNSIZED IN DIRECTION OF FLOW ONLY.
3.

THE CONTRACTOR SHALL NOT INSTALL THE IRRIGATION SYSTEM AS SHOWN ON THE PLANS WHEN IT IS OBVIOUS THAT FIELD CONDITIONS SUCH AS OBSTRUCTIONS, GRADING DIFFERENCES OR DIFFERENCES IN SIZE AND SHAPE OF THE PLANTED AREAS MAY NOT HAVE BEEN ACCOMMODATED IN THE ORIGINAL DESIGN. THE CONTRACTOR SHALL NOTIFY THE LANDSCAPE ARCHITECT OF SUCH CHANGE IN FIELD CONDITIONS. IF NOTIFICATION IS NOT PERFORMED, THE CONTRACTOR SHALL BE FULLY RESPONSIBLE FOR THE INSTALLATION AND FOR THE NEED OF ANY SUBSEQUENT REVISIONS.
4.

ALL PIPE LINES AND CONTROL WIRES CROSSING UNDER PAVING SHALL BE SLEEVED. SLEEVES SHALL BE PVC SCH 40 PIPE WITH BELLED ENDS AND SHALL BE TWO TIMES THE DIAMETER OF THE SLEEVED PIPE OR WIRE BUNDLE (2" MINIMUM). CONTROL WIRE TO BE SLEEVED SEPARATELY FROM PIPE.
5.

IN CASE OF POSSIBLE CONTROL WIRE FAILURE OR FUTURE EXPANSION, THE CONTRACTOR SHALL INSTALL A MINIMUM OF TWO SPARE CONTROL WIRES FROM THE CONTROLLER TO THE FARTHEST VALVE IN EACH CONTROLLER SERVICE AREA. ADDITIONALLY SPARE WIRE FROM ALL EMPTY STATIONS SHALL BE INSTALLED SIMILARLY. ALL SPARE WIRES SHALL PASS THROUGH ALL VALVE BOXES ALONG THE MAINLINE ROUTE. THESE WIRES SHALL BE A DIFFERENT COLOR FROM OTHER CONTROL WIRES AND BE LABELED AS SPARE AT THE CONTROLLER CABINET, IN THE VALVE BOX OF THE FARTHEST VALVE, AND AT ALL OTHER VALVE BOXES.
6.

CONTRACTOR SHALL VERIFY LOCATION OF ALL UNDERGROUND UTILITIES WITHIN WORK AREA PRIOR TO START OF CONSTRUCTION. AT LEAST TWO WORKING DAYS PRIOR TO EXCAVATION, THE CONTRACTOR SHALL REQUEST MARKOUT OF UNDERGROUND UTILITIES BY CALLING BLUESTAKE AT 1-800-782-5348. THE CONTRACTOR SHALL ALSO REFER TO ALL OTHER IMPROVEMENT PLANS FOR THIS PROJECT FOR UTILITY LOCATIONS.

CONTROLS

1.

SYSTEMS OF THIS PROJECT ARE CONTROLLED BY SOLID STATE, COMPUTER IRRIGATION CONTROLLERS. THE CONTRACTOR SHALL EXERCISE STRICT COMPLIANCE WITH THE MANUFACTURERS' INSTRUCTIONS FOR INSTALLATION AND GROUNDING.
2.

CONTROLLER LOCATION IS SHOWN DIAGRAMMATICALLY. FINAL LOCATION TO BE APPROVED BY THE OWNER'S REPRESENTATIVE. POWER SHALL BE PROVIDED BY OTHERS (SEE ELECTRICAL AND/OR ARCHITECTURAL DRAWINGS). THE CONTRACTOR SHALL BE RESPONSIBLE FOR CONNECTION OF POWER TO THE CONTROLLER IN COMPLIANCE TO ALL GOVERNING CODES.

EMITTERS

1.

INSTALL 3/4" EMITTER TUBING WITH DRIP EMITTERS AS REQUIRED TO PROVIDE IRRIGATION TO ALL NEW SHRUBS AND TREES (EXCEPT CACTUS) AS SHOWN ON PLANTING PLAN.
2.

LAYOUT EMITTER TUBING PARALLEL TO TOPOGRAPHY WHEREVER POSSIBLE. INSTALL AUTOMATIC FLUSH TYPE END CAP AT ENDS OF ALL 3/4" LINES AND FLUSH THOROUGHLY BEFORE INSTALLING EMITTERS.
3.

INSTALL ONE SINGLE OUTLET EMITTER AT EACH SHRUB. MULTI-OUTLET EMITTERS MAY BE SUBSTITUTED FOR INDIVIDUAL EMITTERS.
4.

INSTALL ONE MULTI-OUTLET EMITTER (6 PORT) AT EACH TREE. LOCATE TWO (2) OF THE OUTLET POINTS AT 12" FROM THE TREE TRUNK AND LOCATE FOUR (4) OUTLET POINTS AT 30" FROM THE TREE TRUNK. SPACE OUTLET POINTS EVENLY AROUND THE TREE.
5.

USE SHORT PIECES OF 1/4" DISTRIBUTION TUBING (MAXIMUM LENGTH 8') TO EXTEND EMITTERS TO EACH ROOTBALL. HOLD IN PLACE WITH STAKES.

TOWN OF ORO VALLEY IRRIGATION NOTES

1.

IRRIGATION AND/OR WATERING PLANS SHALL MEET THE MINIMUM STANDARDS OF THE AMERICAN SOCIETY OF IRRIGATION CONSULTANTS.
2.

IF DESERT LANDSCAPING IS USED WHICH WILL ULTIMATELY RELY ON NATURAL WATER SOURCES, A TEMPORARY DRIP IRRIGATION SYSTEM SHALL BE EMPLOYED UNTIL SUCH TIME AS THE PLANT MATERIALS ARE SUSTAINED BY NATURAL WATER SOURCES
3.

THE PROPERTY OWNER IS RESPONSIBLE FOR MAINTAINING THE TEMPORARY SYSTEM AS LONG AS NECESSARY IN ORDER TO TRANSITION PLANTS OVER TO NATURAL SOURCES. ANY PLANT MATERIALS THAT DIE IN TRANSITION, FOR ANY REASON, SHALL BE REPLACED IN ACCORDANCE WITH SEC. 27.6.E.4., MAINTENANCE.
4.

IRRIGATION SYSTEMS CONNECTED TO POTABLE WATER MAINS (PUBLIC OR PRIVATE) SHALL BE EQUIPPED WITH BACKFLOW PREVENTERS.
5.

THE ANNUAL WATER USE FOR A PROJECT SHALL NOT EXCEED THE ANNUAL LANDSCAPE WATER PLAN.
6.


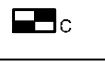
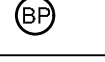





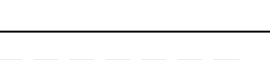
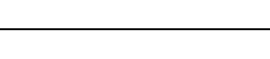
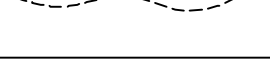



IRRIGATION METER READINGS SHALL BE USED TO DETERMINE COMPLIANCE WITH THE LANDSCAPE WATER PLAN. NON-COMPLIANCE IS SUBJECT TO PENALTIES UNDER ORO VALLEY TOWN CODE.
7.

METER READINGS SHALL BE TAKEN, AT A MINIMUM, ON AN ANNUAL BASIS. MONTHLY READINGS MAY BE REQUIRED, AT THE DISCRETION OF THE PLANNING AND ZONING ADMINISTRATOR, IN ORDER TO ADDRESS NON-COMPLIANCE WITH THE WATER PLAN
8.


AN INITIAL METER READING SHALL BE TAKEN PRIOR TO THE ISSUANCE OF THE CERTIFICATE OF OCCUPANCY AND RECORDED FOR REFERENCE AS PART OF THE WATER PLAN.
9.

IRRIGATION WATER SHALL NOT LEAVE THE LANDSCAPED AREAS AND FLOW ONTO ROADS, PARKING AREAS OR SIDEWALKS.

IRRIGATION EQUIPMENT LEGEND

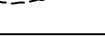SYMBOL	DESCRIPTION	MANUFACTURER / MODEL	REMARKS
	NEW 1" RECLAIMED WATER METER		SEE WATER PLAN
	AUTOMATIC CONTROLLER	HUNTER ICC-800-SS WITH PED-SS AND PWB	
	BACKFLOW PREVENTION ASSEMBLY	2" FEBCO 825Y	
	REMOTE CONTROL VALVE ASSEMBLY	(1) RAINBIRD 2" PESB SERIES VALVE (1) RAINBIRD RBY100MPTX FILTER, OR EQUAL (1) BALL VALVE, NIBCO OR EQUAL	INSTALL IN JUMBO VALVE BOX. COLOR: PURPLE
	IN-LINE PRESSURE REGULATOR	RAINBIRD PSI-L30X-075, OR EQ.	
	QUICK COUPLER	RAINBIRD 33-DNP, OR EQUAL	INSTALL IN 10" ROUND VALVE BOX. COLOR: PURPLE
	BALL VALVE	NIBCO, OR EQUAL	LINE SIZE, INSTALL IN 10" ROUND VALVE BOX. COLOR: PURPLE
	PVC MAINLINE PIPE	AS APPROVED	PVC SCH 40, PURPLE, SIZE PER PLAN
	PVC LATERAL LINE PIPE	AS APPROVED	PVC CLASS 200,PURPLE, SIZE PER PLAN, 1" MINIMUM
	PVC SLEEVE	AS APPROVED	PVC SCH 40; TWO TIMES DIA. OF PIPE OR WIRE BUNDLE. (4" MIN.)
	3/4" POLYETHYLENE LATERAL	AS APPROVED	EXTEND FROM PRESSURE REGULATORS TO WITHIN 8' OF EACH TREE AND SHRUB.
	SINGLE OUTLET EMITTER	RAINBIRD XB-10, OR EQUAL	
	MULTI-OUTLET EMITTER	RAINBIRD XB-10-6, OR EQUAL	INSTALL IN 6" ROUND VALVE BOX. COLOR: PURPLE
	AUTOMATIC FLUSH CAP	API MODEL FCH, OR EQUAL	INSTALL IN 6" ROUND VALVE BOX. COLOR: PURPLE

VALVE KEY

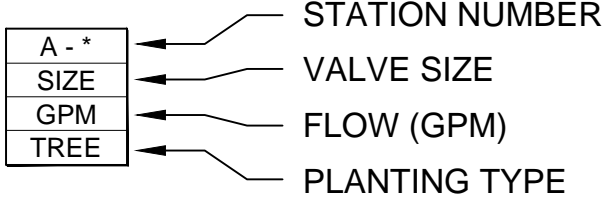

LANDSCAPE WATER PLAN

JAN FEB MAR APR MAY JUN JUL AUG SEP OCT NOV DEC

YEAR 3:
Continue to increase irrigation water use as needed as plants mature up to, but not exceeding, 100% ADWR value by end of year. (average monthly water use = 130,600 gal/month)

59,558	76,799	122,252	163,002	200,618	213,157	183,377	161,435	145,762	115,982	73,664	51,722
TOTAL (100% ADWR)											1,567,328

YEAR 4:
Begin gradually decreasing irrigation to buffer, median, and ROW areas in order to reach zero irrigation in those areas by end of year 5. (to reach 75% ADWR by end of year, average monthly water use = 98,000 gal/month)

44,669	57,599	91,689	122,252	150,463	159,867	137,533	121,076	109,321	86,987	55,248	38,791
TOTAL (75% ADWR)											1,175,496

YEAR 5:
Continue decreasing irrigation to buffer, median, and ROW areas.
By end of year 5, irrigation to buffer, median, and ROW areas must be zero, and total amount of water used at site must meet 50% of ADWR maturity value. (average monthly water use = 65,300 gal/month)

29,779	38,400	61,126	81,501	100,309	106,578	91,689	80,717	72,881	57,991	36,832	25,861
TOTAL (50% ADWR)											783,664

LANDSCAPE WATER PLAN BASE IRRIGATION SCHEDULE

PLANT TYPE	YEAR	AVERAGE # OF IRRIGATION DAYS PER MONTH	RUN TIME PER IRRIGATION DAY	AVERAGE TOTAL WATER USE PER MONTH	AVERAGE TOTAL WATER USE PER YEAR
TREES	3	8	120 MIN.	130,610 GAL.	1,567,328 GAL.
SHRUBS		16	60 MIN.		
TREES	4	4	120 MIN.	97,958 GAL.	1,175,496 GAL.
SHRUBS		12	60 MIN.		
TREES	5	2	120 MIN.	65,305 GAL.	783,664 GAL.
SHRUBS		8	60 MIN.		

EMITTER SCHEDULE

SPECIES	EMITTER FLOW (GPH)	# OF EMITTERS PER PLANT
24" BOX TREE	1.0	12
15 GAL. TREE	1.0	6
5 GAL. SHRUB	1.0	2
1 GAL. SHRUB	1.0	1

LATERAL PIPE SIZING CHART:

SCH 40 PIPE	GPM
3/4"	0-7
1"	8-11
1-1/4"	12-21
1-1/2"	22-29
2"	30-49
2-1/2"	50-75

SLEEVEVING SCHEDULE

PIPE SIZE	SLEEVE SIZE
3/4"	2"
1"	2-1/2"
1-1/4"	3"
1-1/2"	4"
2"	4"
2-1/2"	6"
3"	6"

REGISTERED LANDSCAPE ARCHITECT
36734
MARK E. FELLINGER
7/24/19
ARIZONA, U.S.A.

M. Felling

3668
3945 EAST FORT LOWELL ROAD, SUITE 111
TUCSON, AZ 85712
520.795.0000
(P)520.322.6956
Phoenix • San Diego • Sacramento • Riverside • Orange • San Luis Obispo • Bakersfield
RICK
ENGINEERING COMPANY
Tucson

DESIGNED: MEF
DRAWN: MEF
DATE: 7/19
CHECKED BY: MEF
APPROVED BY: MEF
DATE: 7/19

DATE: DATE:
DATE: DATE:


WASH RESTORATION PLANS PREPARED FOR:
MASTER SUBMITTAL
MILLER RANCH
BEING A PORTION OF THE SOUTHEAST QUARTER OF
SECTION 34, TOWNSHIP 11 SOUTH, RANGE 13 EAST
GILA & SALT RIVER MERIDIAN, PIMA COUNTY, ARIZONA

OV1802195
REFERENCE:
OV914-006, OV1113-003,
OV114-020, OV1208-07,
OV1208-7A, OV904-02,
OV1800713, OV1702695,
(O)18-09, (R)14-10

WI-01

SCALE : N/A

SHEET 6 OF 14



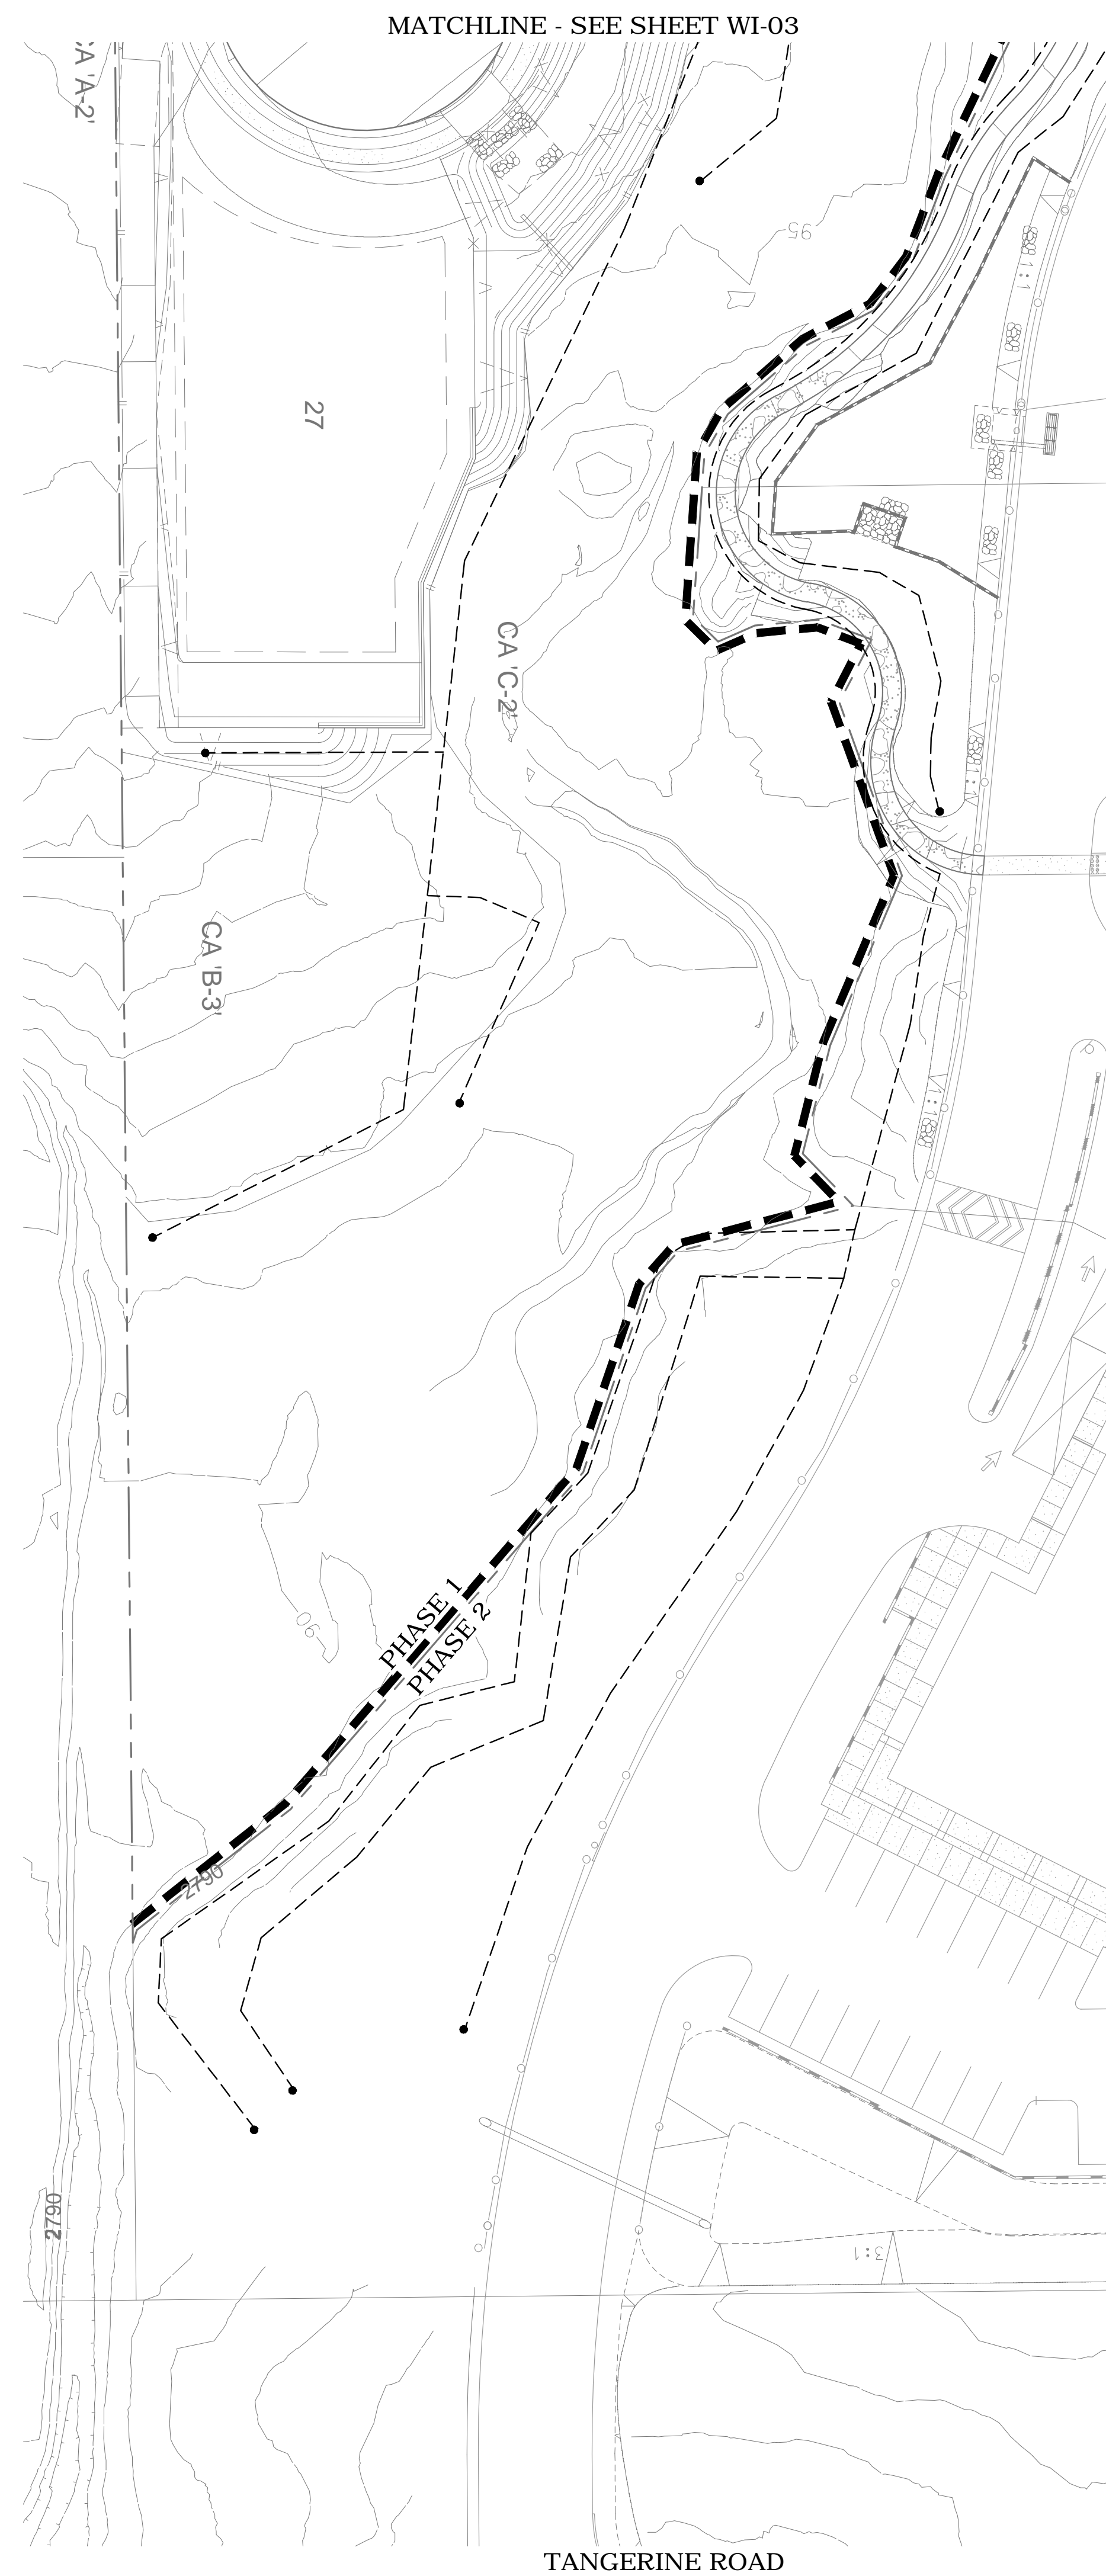


SCALE: 1" = 30'

	WASH RESTORATION PLANS PREPARED FOR: MASTER SUBMITTAL							
	<div style="text-align:center;">MILLER RANCH BEING A PORTION OF THE SOUTHEAST QUARTER OF SECTION 34, TOWNSHIP 11 SOUTH, RANGE 13 EAST, GILA & SALT RIVER MERIDIAN, PIMA COUNTY, ARIZONA</div>							
	OV1802195 REFERENCE: OV914-006, OV1113-003, OV114-020, OV1208-07, OV1208-7A, OV904-02, OV1800713, OV1702695, (O)18-09, (R)14-10							
	<div style="font-size: 4em;">WI-02</div>							
	SCALE : 1" = 30'							
	SHEET 7 OF 14							



WASH RESTORATION PHASING:
PHASE 1 SHALL BE COMPLETED CONCURRENTLY
WITH RESIDENTIAL SUBDIVISION.
PHASE 2 SHALL BE COMPLETED WITH FUTURE
COMMERCIAL AND TECH. PARK DEVELOPMENT.

SHEET INDEX

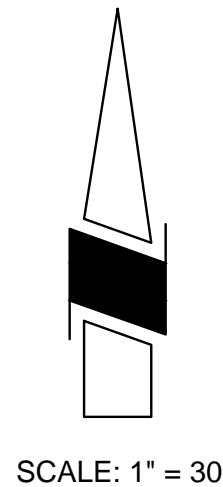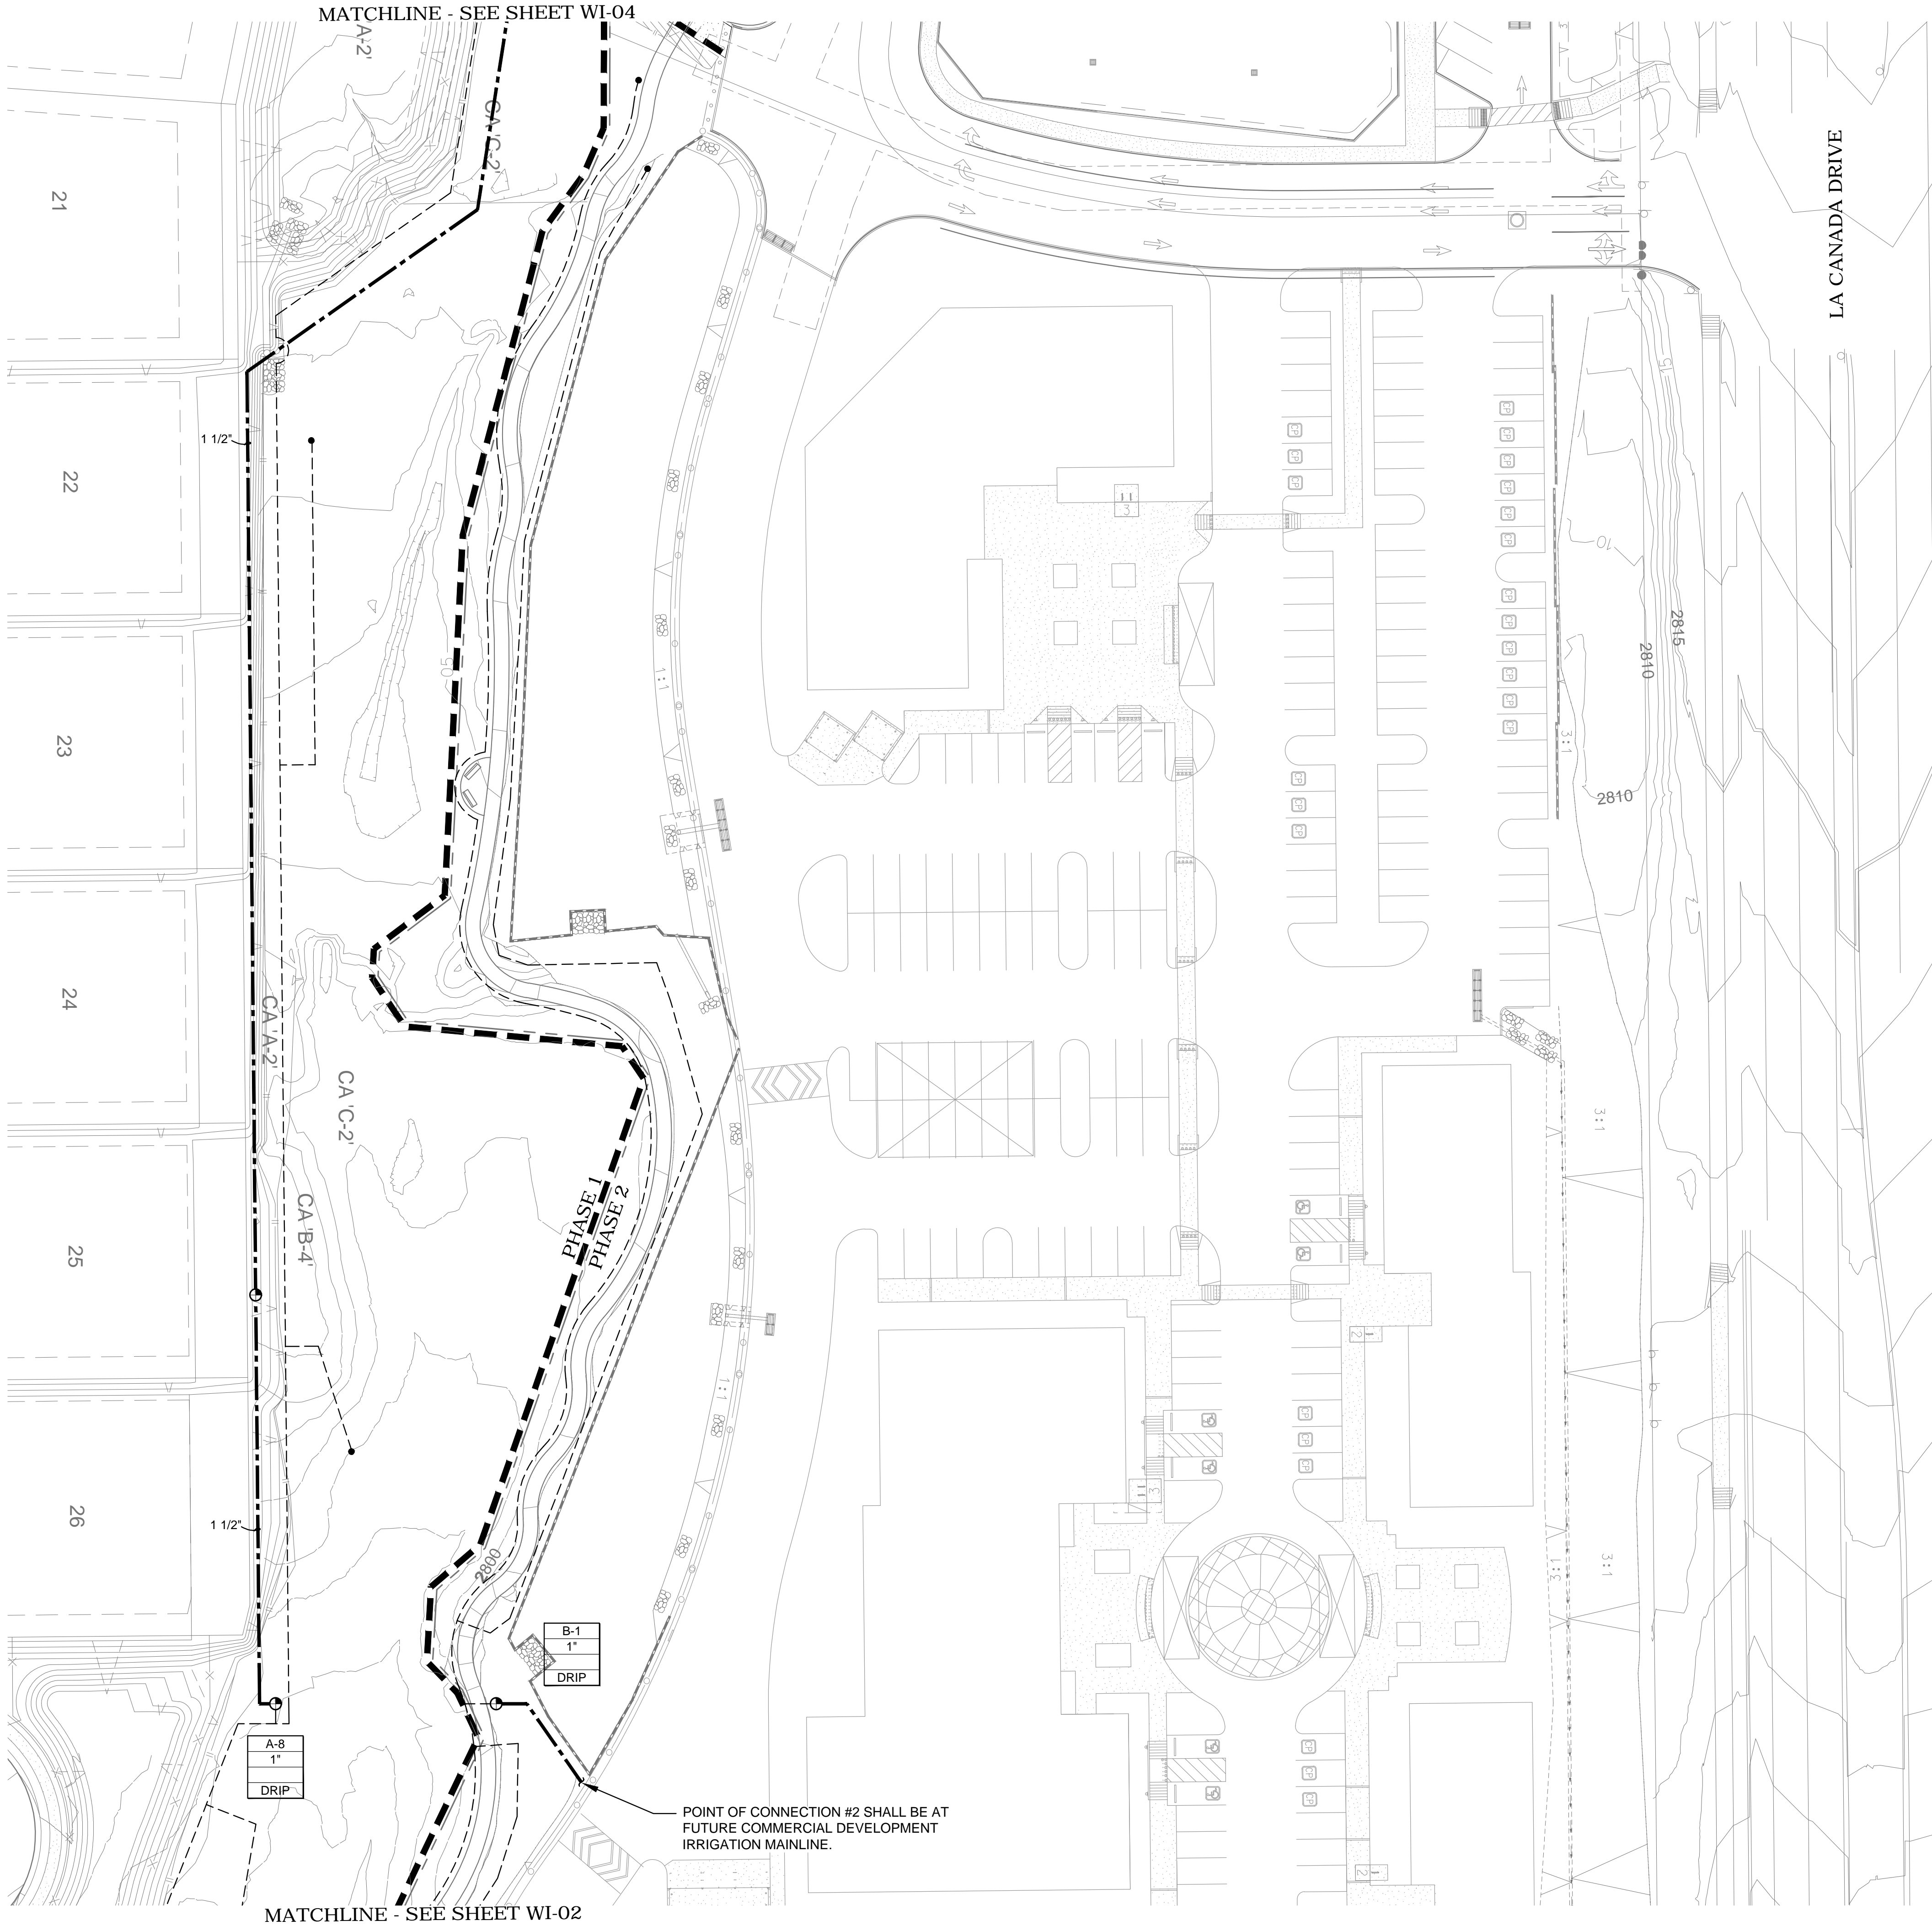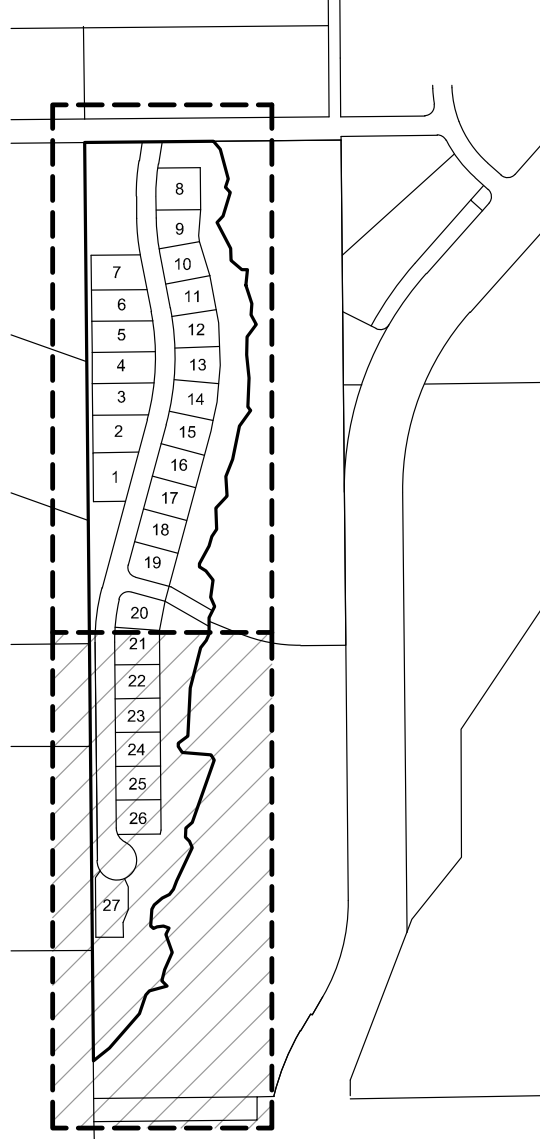


WASH RESTORATION PLANS PREPARED FOR: MILLER RANCH BEING A PORTION OF THE SOUTHEAST QUARTER OF SECTION 34, TOWNSHIP 11 SOUTH, RANGE 13 EAST GILA & SALT RIVER MERIDIAN, PIMA COUNTY, ARIZONA		OV1802195 REFERENCE: OV914-006, OV1113-003, OV114-020, OV1208-07, OV1208-7A, OV904-02, OV1800713, OV1702695, (O)18-09, (R)14-10		WI-03	
DESIGNED: MEF DRAWN: MEF		DATE: 7/19 CHECKED BY: MEF APPROVED BY: MEF		NO. BY DATE 2/ MEF 2-13-18 3/ MEF 7-24-18	
3945 EAST FORT LOWELL ROAD - SUITE 111 TUCSON, AZ 85712 520.795.1000 (FAX) 520.322.6956 rickengineering.com tucson		JUL 36681		REVISIONS TO REFLECT LEMAN AS-BUILT CONDITIONS AND PROPOSED RESIDENTIAL IMPROVEMENTS ADDED PHASE LINE	
RICK ENGINEERING COMPANY tucson		M. Fellingner REGISTERED LANDSCAPE ARCHITECT 36734 MARK E. FELLINGER 7/24/19 ARIZONA, USA		SCALE : 1" = 30' SHEET 8 OF 14	

SHEET INDEX

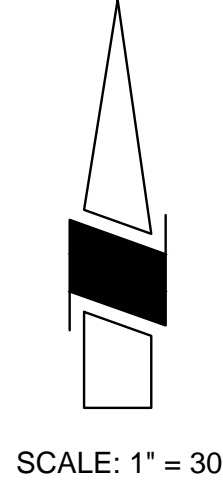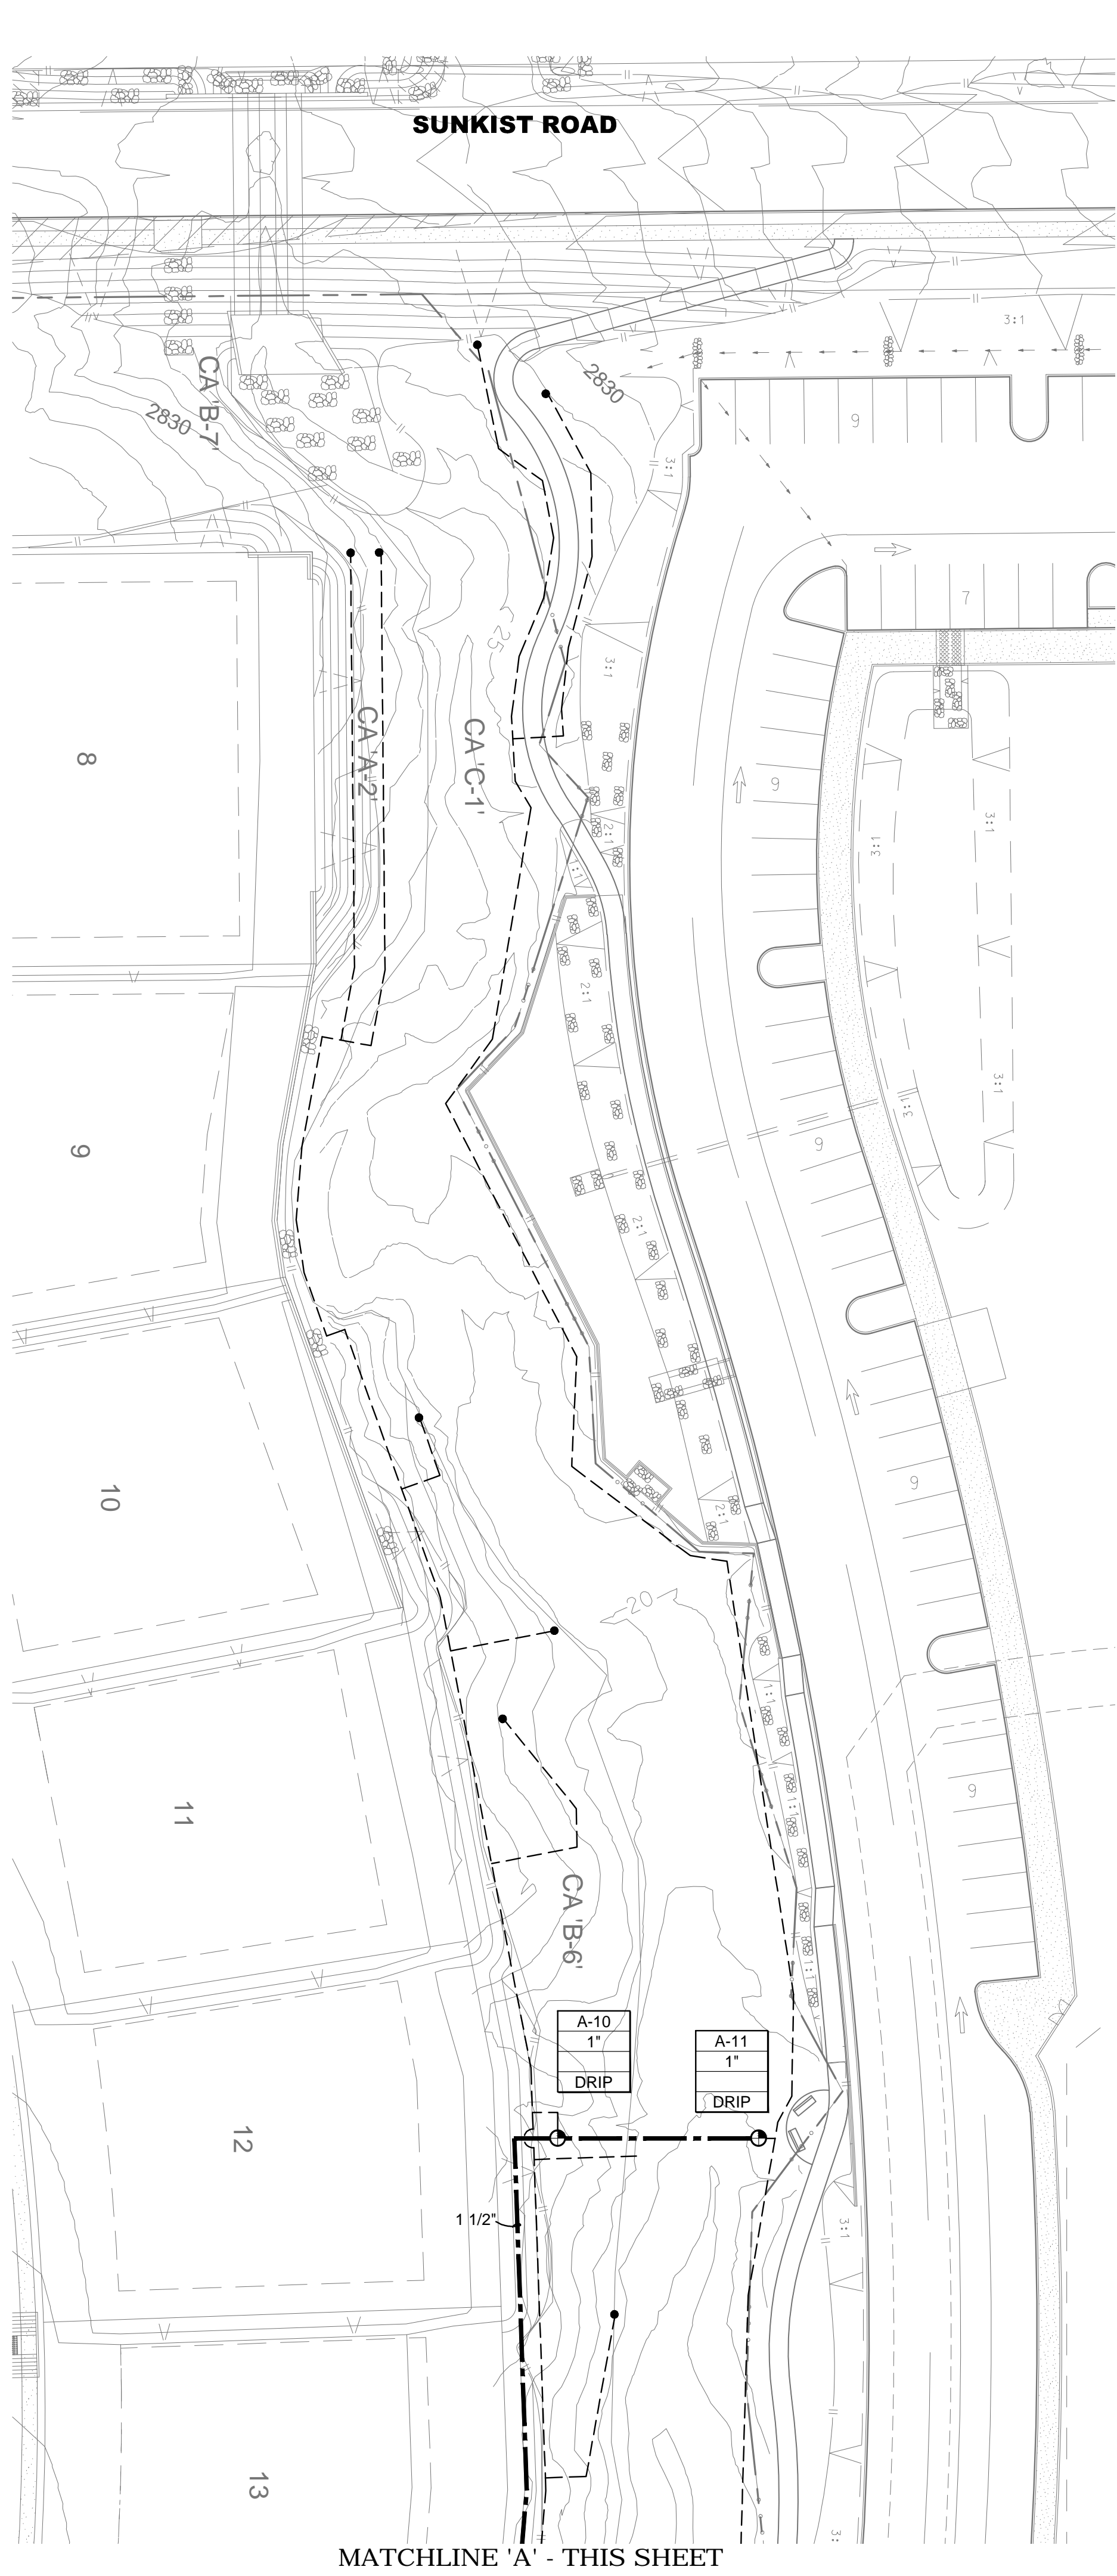


WASH RESTORATION PLANS PREPARED FOR: TOTAL MILLER RANCH BEING A PORTION OF THE SOUTHEAST QUARTER OF SECTION 34, TOWNSHIP 11 SOUTH, RANGE 13 EAST GILA & SALT RIVER MERIDIAN, PIMA COUNTY, ARIZONA		DESIGNED: MEF DRAWN: MEF		DATE: 7/19 DATE: 7/19		CHECKED BY: APPROVED BY:		DATE: DATE:	
REFERENCE: OV914-006, OV1113-003, OV114-020, OV1208-07, OV1208-7A, OV904-02, OV1800713, OV1702695, (O)18-09, (R)14-10		RICK ENGINEERING COMPANY Tucson 3945 EAST FORT LOWELL ROAD - SUITE 111 TUCSON, AZ 85712 520.795.0000 (FAX) 520.322.6956 Project: San Diego, Sacramento, Riverside - Orange, San Luis Obispo, Shattuck		JUN 3668		REGISTERED LANDSCAPE ARCHITECT 36734 MARK E. FELLINGER 7/24/19 ARIZONA, USA		REVISIONS TO REFLECT LEMAN AS-BUILT CONDITIONS AND PROPOSED RESIDENTIAL IMPROVEMENTS	
WI-04		SCALE : 1" = 30'		SHEET 9 OF 14		NO. BY		DATE	
						REVISION			

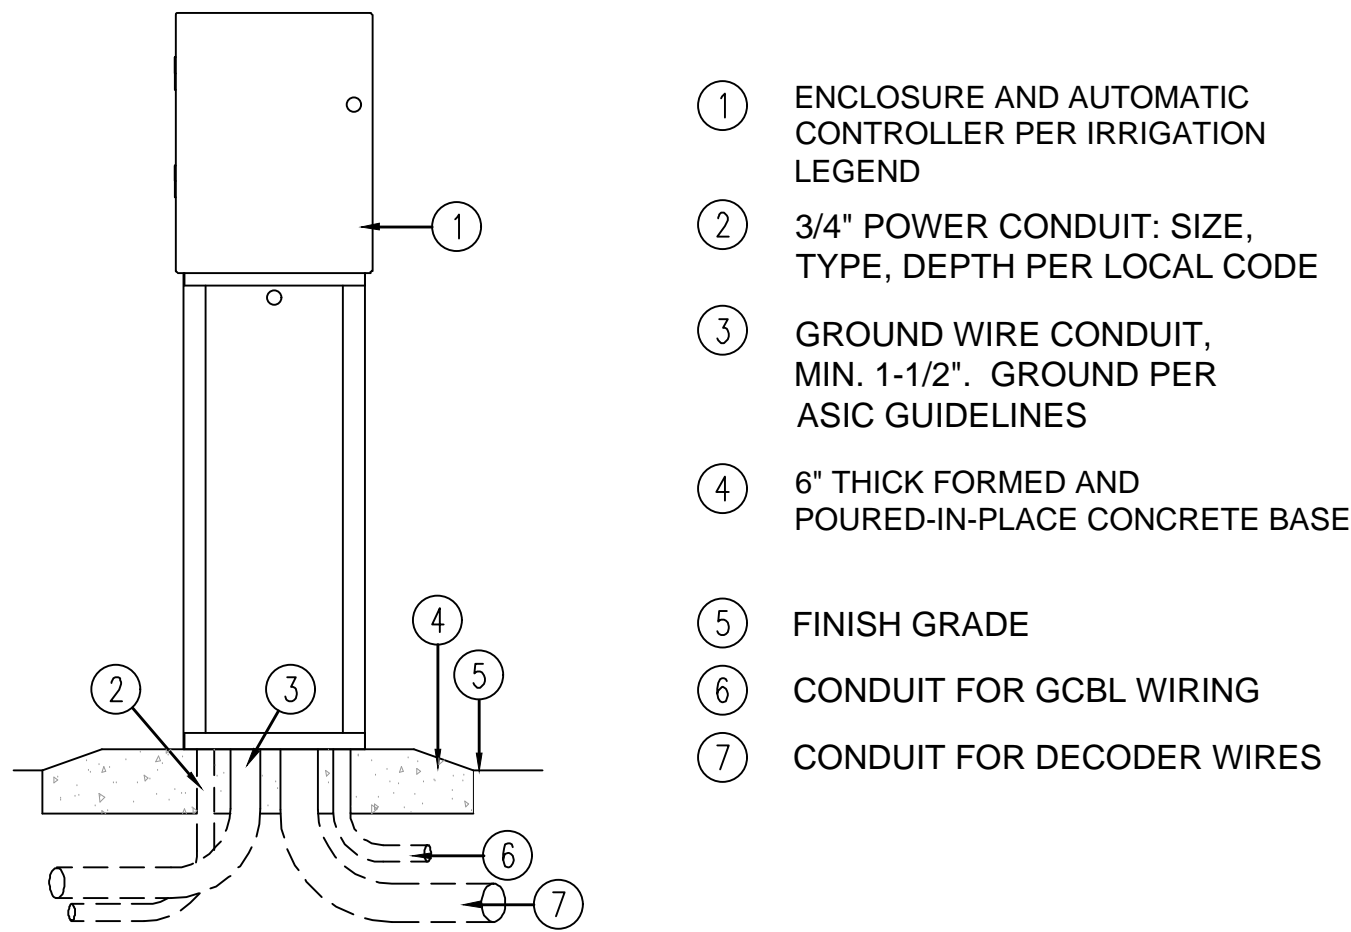


NOTES:
1. SEE INSTRUCTION MANUAL FOR MOUNTING INSTRUCTIONS.
2. ALL WIRING SHALL BE INSTALLED PER LOCAL CODES.
3. 120 VOLT POWER TO BE SUPPLIED BY OWNER.

A IRRIGATION CONTROLLER NOT TO SCALE

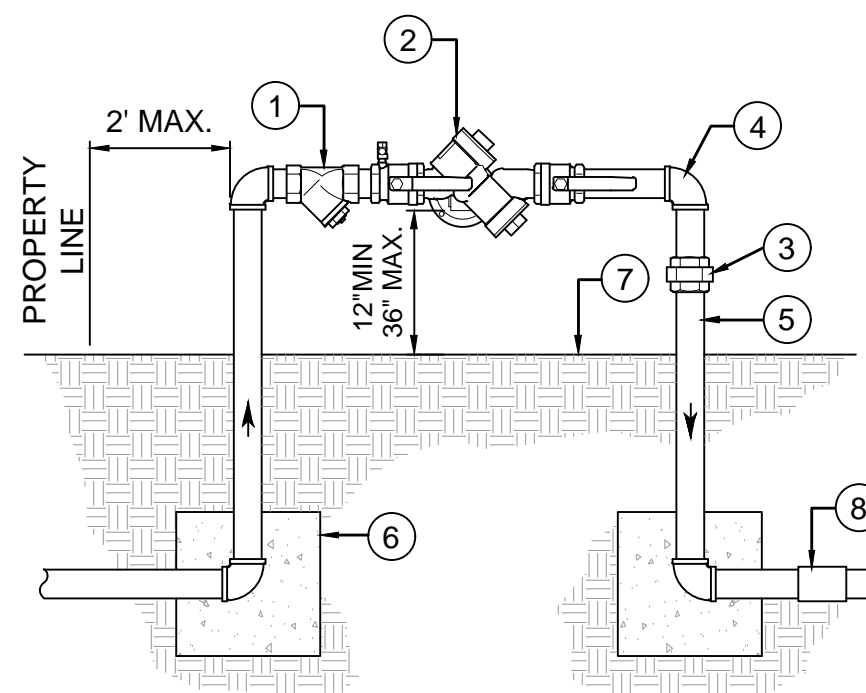


- 1 WYE STRAINER (LINE SIZE), SEE LEGEND
2 REDUCED PRESSURE BACKFLOW DEVICE WITH 2 BALL VALVES, REFER TO PLAN FOR TYPE AND SIZE OF EQUIPMENT
3 BRASS UNION
4 BRASS ELL (TYPICAL)
- 5 BRASS NIPPLE, TYPICAL
6 1 CU. FT. CONCRETE THRUST BLOCKS, TYPICAL. WRAP PIPES W/ 10 MIL. TAPE. SATURATE AND COMPACT SUB-GRADE TO 90% PRIOR TO POUR.
7 FINISH GRADE
8 PVC MALE ADAPTER

B BACKFLOW PREVENTION DEVICE NOT TO SCALE

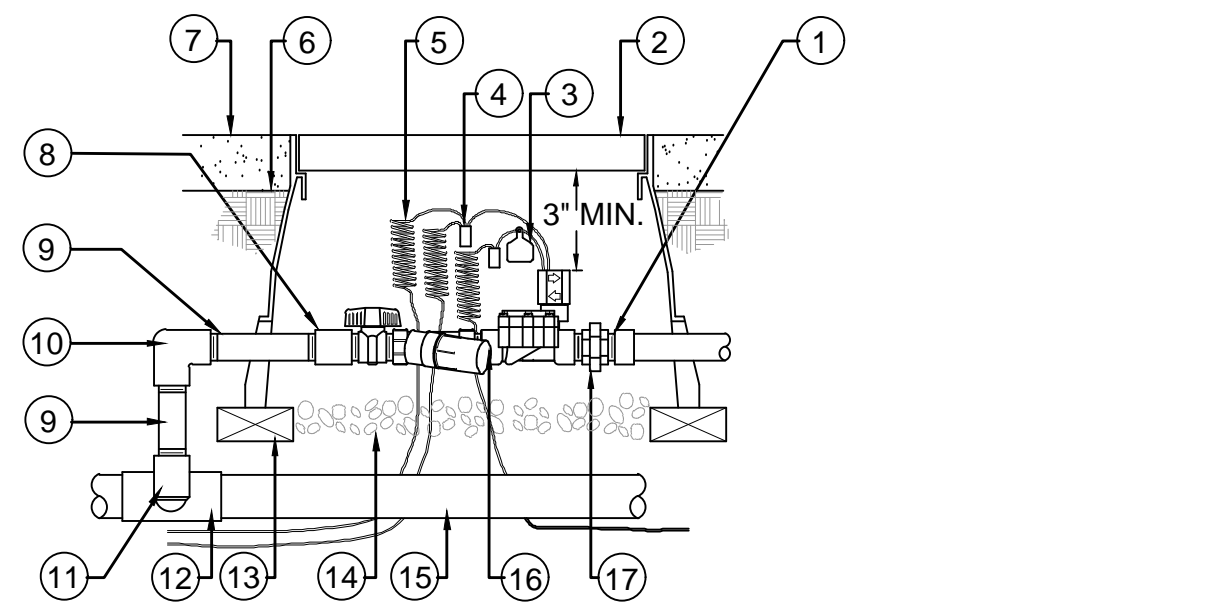


- 1 PVC SCH. 80 NIPPLE (CLOSE)
2 VALVE BOX W/ COVER: 24" SIZE (PURPLE)
3 ID TAG
4 WATER PROOF CONNECTION (1 OF 2)
5 30-INCH LINEAR LENGTH OF WIRE, COILED
6 FINISH GRADE
7 TOP OF MULCH
8 PVC SCH. 40 COUPLING
9 PVC SCH. 80 NIPPLE (LENGTH AS REQ'D)
10 PVC SCH. 40 ELL
11 PVC SCH. 80 NIPPLE (2" LENGTH, HIDDEN) AND PVC SCH. 40 ELL
12 PVC SCH. 40 TEE OR ELL
13 BRICK (1 OF 4)
14 3" MIN. DEPTH OF 3/4" WASHED GRAVEL
15 PVC MAINLINE, SIZE PER PLANS
16 DRIP VALVE ASSEMBLY PER LEGEND
17 PVC SCH. 80 UNION FOR SERVICING ASSEMBLY
20 PVC SCH. 40 MALE ADAPTER

C REMOTE CONTROL VALVE (DRIP) NOT TO SCALE

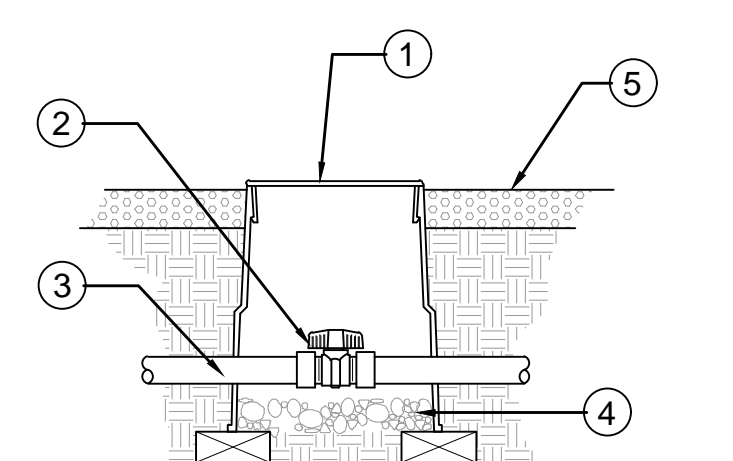


- 1 6" ROUND VALVE BOX (PURPLE)
2 BALL VALVE PER LEGEND
3 LATERAL LINE (PURPLE)
4 3" MIN. DEPTH OF 3/4" WASHED GRAVEL
5 FINISH GRADE OF DG.

D BALL VALVE NOT TO SCALE

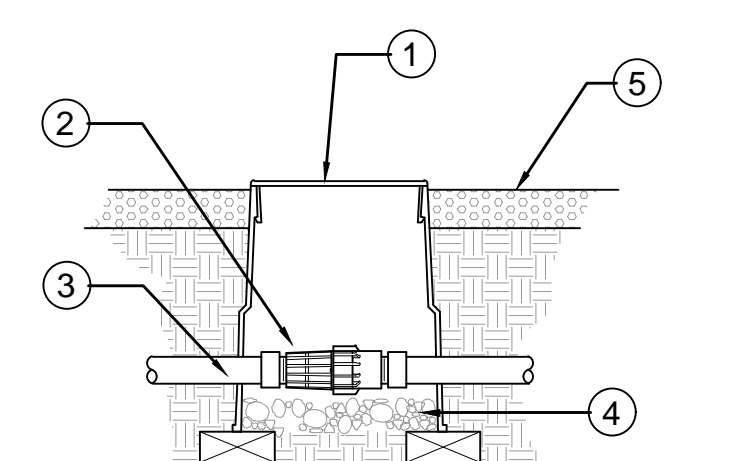


- 1 6" ROUND VALVE BOX (PURPLE)
2 PRESSURE REGULATOR PER LEGEND
3 LATERAL LINE (PURPLE)
4 3" MIN. DEPTH OF 3/4" WASHED GRAVEL
5 FINISH GRADE OF DG.

E PRESSURE REGULATOR NOT TO SCALE

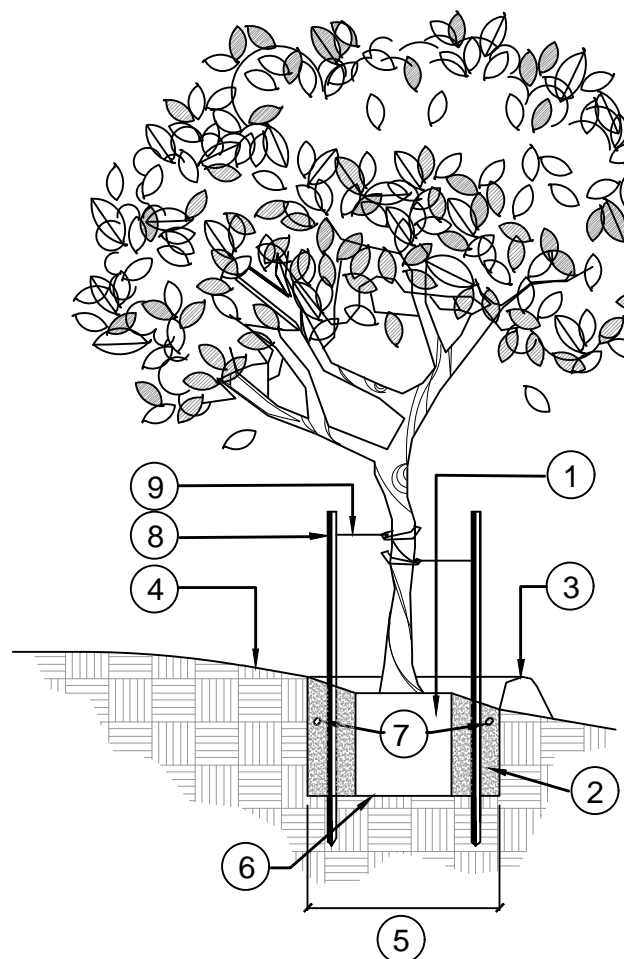

- 1 ROOTBALL
2 AMENDED BACKFILL MIX
3 6" HIGH BERM/MICRO BASIN
4 FINISH GRADE
5 WIDTH TWICE DIAMETER OF ROOTBALL
6 PLACE ROOTBALL ON NATURAL GRADE
7 FERTILIZER TABLETS
8 (2) 2" DIA. X 10' LONG, LODGE POLES, PLACE OUTSIDE ROOTBALL
9 BLACK PLASTIC CINCH-TIE WITH ONE TWIST NAILED TO STAKES


F TREE PLANTING ON SLOPE NOT TO SCALE

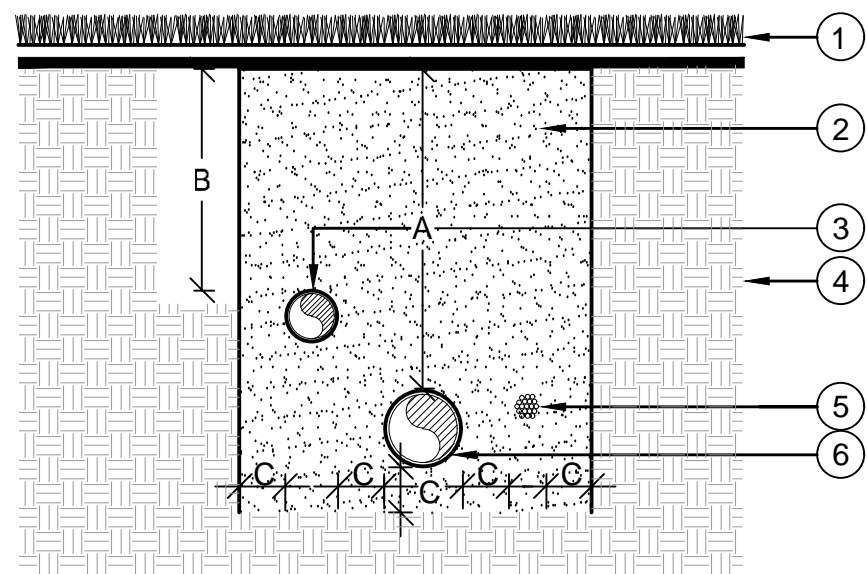

- 1 FINISH GRADE
2 CLEAN COMPACTED BACKFILL
3 LATERAL LINES, SEE SPECS.
4 UNDISTURBED SOIL
5 CONTROL WIRES, SEE SPECS.
6 PRESSURE MAINLINE, SEE SPECIFICATIONS

DIMENSION	A	B	C
1/2" TO 2-1/2" SIZE	18"	12"	4"
3" IN SIZE	24"		4"
4" AND LARGER	36"		4"

G TRENCHING NOT TO SCALE

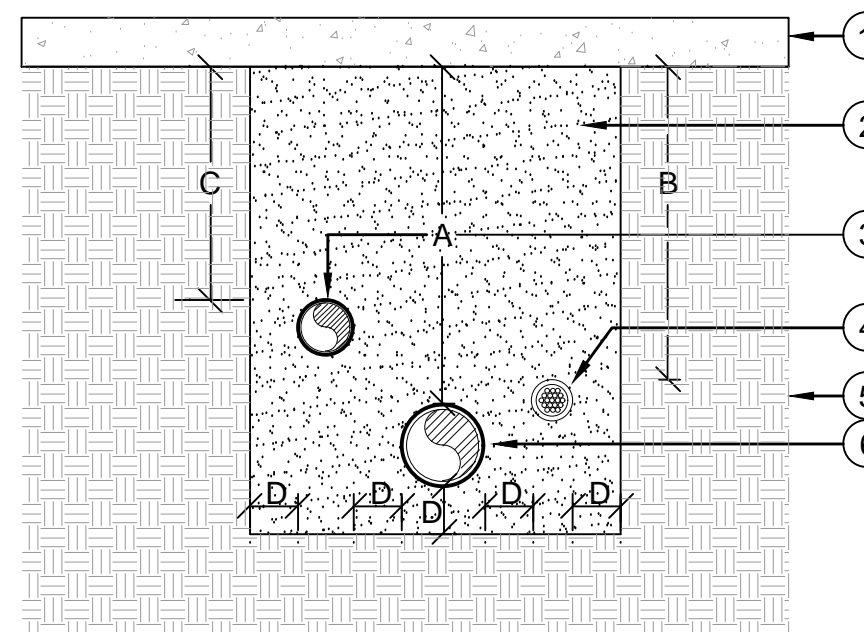


- 1 PAVING
2 SAND BACKFILL COMPACTED TO THE DENSITY OF EXISTING SOIL
3 LATERAL LINE SEE LEGEND FOR SPECS
4 CONTROL WIRE SEE LEGEND FOR SPECS
5 UNDISTURBED SOIL
6 MAINLINE SLEEVE, SEE LEGEND FOR SPECS

DIMENSION- PEDESTRIAN	A	B	C	D
2" TO 12" SIZE	30"	24"	12"	4"
DIMENSION- VEHICLE	A	B	C	D
2" TO 12" SIZE	36"	30"	24"	4"


NOTES:
1. ALL SLEEVES TO BE PVC SCH. 40 PIPE.
2. ALL SLEEVES TO BE SIZED TWICE THE DIA. OF THE WORKING PIPE.
3. ALL SLEEVES TO RUN A MIN. OF 12" BEYOND HARDSCAPE EDGES.
4. WRAP #12 GALVANIZED WIRE AROUND EACH END OF SLEEVE (10 WRAPS MIN.) AND EXTEND TO SURFACE AS A LOCATING DEVICE.

H SLEEVING NOT TO SCALE

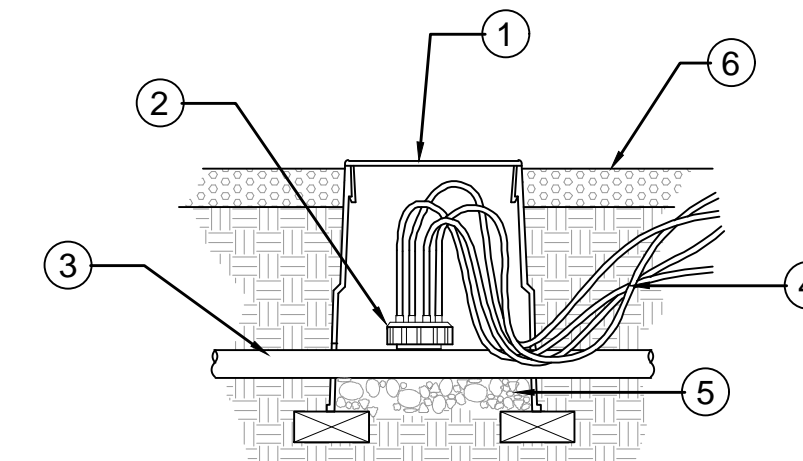


- 1 6" ROUND VALVE BOX (PURPLE)
2 MULTI-OUTLET DRIP EMITTER PER LEGEND
3 3/4" POLYETHYLENE LATERAL
4 1/4" DISTRIBUTION TUBING
5 3" MIN. DEPTH OF 3/4" WASHED GRAVEL
6 FINISH GRADE

I MULTI-OUTLET DRIP EMITTER NOT TO SCALE

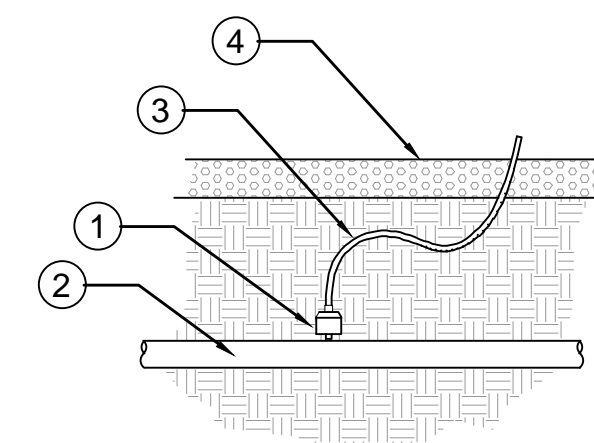


- 1 SINGLE OUTLET DRIP EMITTER PER LEGEND
2 3/4" POLYETHYLENE LATERAL
3 1/4" DISTRIBUTION TUBING
4 FINISH GRADE

J SINGLE OUTLET DRIP EMITTER NOT TO SCALE

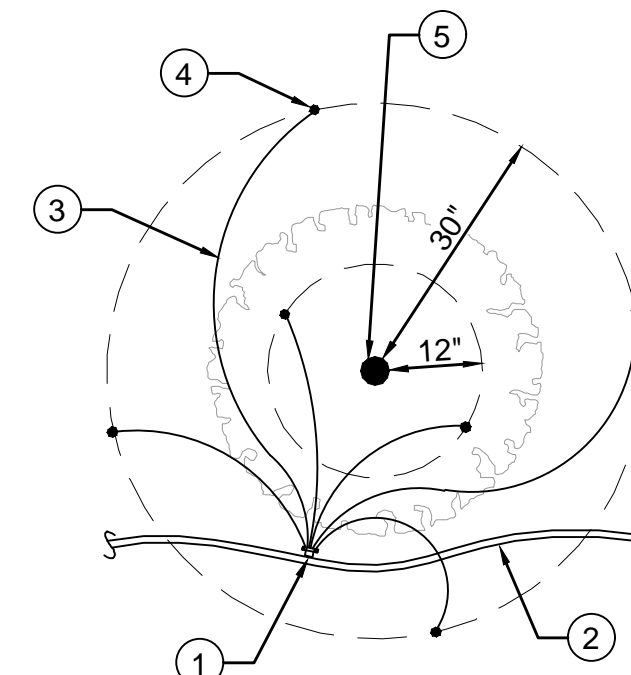


- 1 ROOTBALL
2 CROWN 1" ABOVE FINISH GRADE
3 FINISH GRADE
4 2 X ROOTBALL DIAMETER
5 BACKFILL (SEE SPECS)
6 PLANT TABLETS (SEE SPECS)
7 UNDISTURBED NATIVE SOIL
8 PLANTING BASIN DEPRESSED A MINIMUM OF 4" FROM FINISHED GRADE.

K SHRUB PLANTING NOT TO SCALE

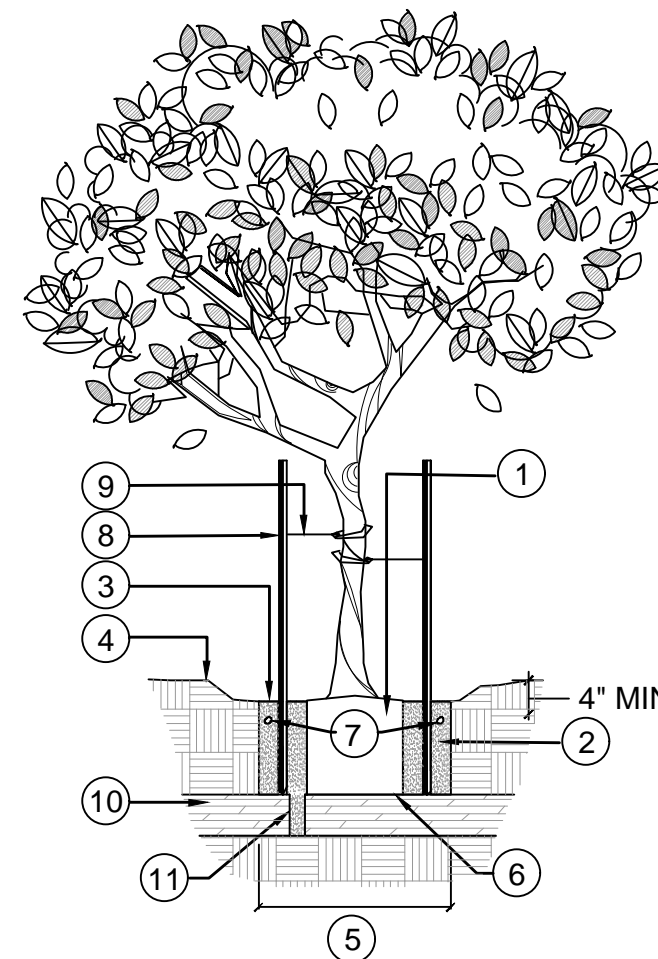

- 1 ROOTBALL
2 AMENDED BACKFILL MIX
3 PLANTING BASIN DEPRESSED A MINIMUM OF 4" FROM FINISHED GRADE
4 FINISH GRADE
5 WIDTH TWICE DIAMETER OF ROOTBALL
6 PLACE ROOTBALL ON NATURAL GRADE
7 FERTILIZER TABLETS
8 (2) 2" DIA. X 10' LONG, LODGE POLES, PLACE OUTSIDE ROOTBALL
9 BLACK PLASTIC CINCH-TIE WITH ONE TWIST NAILED TO STAKES
10 HARDPAN OR CALICHE SOIL LAYER
11 DRILL 8" DIAMETER CHIMNEY DRAINAGE HOLE TO THE SIDE OF ROOTBALL IF HARDPAN OR CALICHE SOIL LAYER IS ENCOUNTERED.

L TREE PLANTING NOT TO SCALE

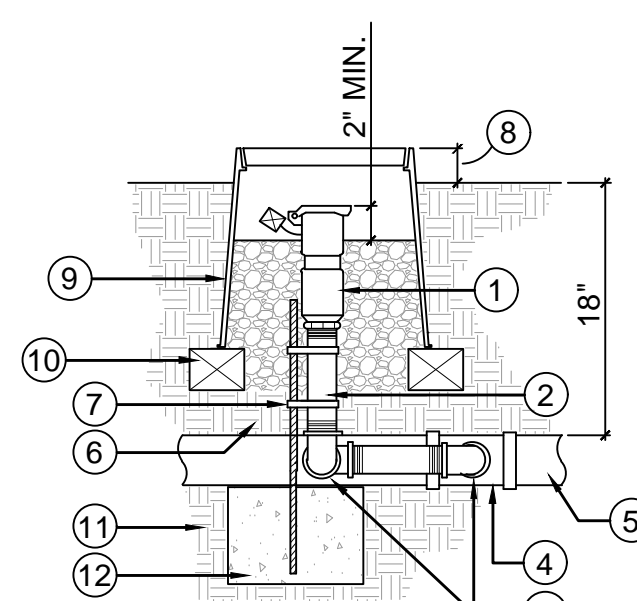

NOTES:
1. USE TEFLON TAPE ON ALL THREADED CONNECTIONS.
2. SWING JOINT AND SIDE OUTLET OF TEE TO BE SIZED EQUAL TO QCV INLET.
3. SUPPLY AND INSTALL R.W. WARNING TAG AS REQ.

M QUICK COUPLER NOT TO SCALE

N EMITTER PLACEMENT @ TREES NOT TO SCALE

REGISTERED LANDSCAPE ARCHITECT
CERTIFICATE NO. 36734
MARK E. FELLINGER
7/24/19
ARIZONA, USA

M. Felling

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WD-01

SCALE : NTS
SHEET 10 OF 14

DESIGNED: MEF
DRAWN: MEF

CHECKED BY: MEF
APPROVED BY: MEF

DATE: 7/19
DATE: 7/19

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G:\3668_Corp\36681_Desco_Residential\Landscape\36681-L-WASH-RESTORATION.dwg Plotted: Jul. 24, 2019

