

- GROSS AREA OF DEVELOPMENT = 16.12± ACREAS
- 3. TOTAL ACRES OF GRADED AREA = 17.11 ± ACRES
- TOTAL ACRES OF UNDISTURBED AREA = 0.00 ± ACRES
- TOTAL AMOUNT OF OPEN SPACE REQUIRED AND PROVIDED = 4.84 ACRES AND 4.90
- BUILDING SETBACKS REQUIRED / PROVIDED: FRONT = 15', SIDE: 0', REAR: 0'
- BUFFERYARDS: PER OVZCR 27.6.C AND AS PAR RANCHO VISTOS PAD. PER PAD THE NORTHERN BOUNDARY REQUIRES 15' BUFFERYARD "B" AND THE WESTERN BUFFERYARD REQUIRES 30' BUFFERYARD "B", INCLUDING EXISTING LANDSCAPE IN RIGHT-OF-WAY.
- 8. LANDSCAPE TO CONFORM TO ORO VALLEY LANDSCAPE CODE.
- 9. ALL SIGNS AND LIGHTING TO BE SUBMITTED UNDER SEPARATE PLAN AND PERMIT.
- 10. MITIGATION OF SURVEYED PLANTS IN THE NATIVE PLAN PRESERVATION PLAN WILL BE INCORPORATED IN THE LANDSCAPE DESIGN.
- ASSURANCES FOR LANDSCAPING AND RE-VEGETATION BONDS MUST BE POSTED PRIOR TO ISSUANCE OF GRADING PERMITS. A LANDSCAPE BOND IN THE AMOUNT OF 10% OF THE ORIGINAL LANDSCAPE BOND SHALL REMAIN IN PLACE FOR A PERIOD OF ONE YEAR FROM THE COMPLETE INSTALLATION OF LANDSCAPE MATERIALS AND ANY REPLACEMENT MATERIALS.
- PROPERTY OWNER SHALL MAINTAIN BUFFER YARD PLANTINGS TO ENSURE UNOBSTRUCTED VISIBILITY TO MOTORISTS. ALL SHRUBS, ACCENTS, AND GROUNDCOVERS SHALL NOT EXCEED THIRTY (30") INCHES IN HEIGHT WITHIN SITE VISIBILITY TRIANGLES. TREES WITHIN SITE VISIBILITY TRIANGLES WILL BE MAINTAINED TO ENSURE THAT BRANCHES/FOLIAGE IS NOT BELOW A HEIGHT OF SIX (6') FEET AND THE TRUNK DIAMETER SHOULD NOT EXCEED 1-FOOT WHEN FULLY
- 13. PROPERTY OWNERS, LESSEES, AND OCCUPANTS SHALL MAINTAIN REQUIRED LANDSCAPE, IRRIGATION, BUFFERING, SCREENING AND RAINWATER HARVESTING SYSTEM IMPROVEMENTS PER THE APPROVED PLANS.
- 14. IN THE EVENT OF ABANDONMENT OF THE SITE AFTER GRADING/DISTURBANCE OF NATURAL AREAS, DISTURBED AREAS SHALL BE RE-VEGETATED WITH A NON-IRRIGATED HYDRO SEED MIX FROM OVZCR ADDENDUM D: APPROVED REVEGETATION SEED MIX.
- ALL PLANT MATERIAL SHALL MEET THE MINIMUM STANDARDS CONTAINED IN THE CURRENT EDITIONS OF THE ARIZONA NURSERY ASSOCIATION'S GROWERS COMMITTEE RECOMMENDED TREE SPECIFICATIONS AND AMERICAN NURSERY ASSOCIATION AS TO SIZE, CONDITION AND APPEARANCE.
- SYSTEM AS LONG AS NECESSARY IN ORDER TO TRANSITION PLANTS OVER TO NATURAL SOURCES. ANY PLANT MATERIALS THAT DIE IN TRANSITION, FOR ANY REASONS, SHALL BE REPLACED IN ACCORDANCE WITH SECTION 27.6.E.4.,
- 17. ANY SPADED OR BOXED TREE TRANSPLANTED ON SITE THAT DIES DUE TO NEGLECT OR LACK OF MAINTENANCE SHALL BE REPLACED WITH THE SAME SIZE AND SPECIES OF THE ORIGINAL SALVAGED TREE, AS REQUIRED BY THE SALVAGE PLAN.
- 18. THE LIMITS OF GRADING SHALL BE STAKED IN THE FIELD, IN ACCORDANCE WITH SECTION 27.6.B.7.C.II OF THE ZONING CODE. DISTURBANCE OUTSIDE THE APPROVED GRADING LIMITS SHALL NOT BE PERMITTED.
- 19. IRRIGATION SHALL BE REDUCED THREE YEARS AFTER ISSUANCE OF THE FIRST CERTIFICATE OF OCCUPANCY. METERED WATER USE FOR LANDSCAPE IRRIGATION SHALL BE REDUCED BY FIFTY PERCENT, FIVE YEARS FROM THE DATE OF THE ISSUANCE OF THE CERTIFICATE OF OCCUPANCY.
- 20. NO SALVAGE OF PLANTS REGULATED BY THE ENDANGERED SPECIES ACT AND/OR THE ARIZONA NATIVE PLANT LAW MAY OCCUR WITHOUT THE ISSUANCE OF THE APPROPRIATE PERMIT BY THE STATE DEPARTMENT OF AGRICULTURE.
- 21. LANDSCAPE MATERIALS SHALL NOT OBSTRUCT SIGHT DISTANCES OR VEHICLE
- LANDSCAPED AREAS THAT ARE SUSCEPTIBLE TO DAMAGE BY PEDESTRIAN OR AUTO TRAFFIC SHALL BE PROTECTED BY APPROPRIATE CURBS, TREE GUARDS OR OTHER
- 23. LANDSCAPE SHALL BE DESIGNED TO MINIMIZE SEDIMENT, SAND AND GRAVEL BEING CARRIED INTO THE STREETS FROM STORM WATER OR OTHER RUNOFF.
- 24. LANDSCAPE PLAN ENABLES ADEQUATE PLANT SPACING TO ENSURE SURVIVABILITY AT PLANT MATURITY.
- 25. DEEP ROOTED VEGETATION AND TREES SHALL NOT BE PLANTED CLOSER THAN 7.5' FROM A PUBLIC WATER LINE. EXCEPTIONS FOR ALTERNATIVE DESIGN SOLUTIONS SUCH AS ROOT BARRIERS SHALL BE CONSIDERED ON A CASE-BY-CASE BASIS.
- 26. CURB-WAY CONSISTING OF INORGANIC GROUNDCOVER OR PLANTS NOT TO EXCEED TYPE 2 WATER USE SHALL BE PROVIDED BETWEEN CURB AND ALL SIDEWALKS.
- 27. ALL LANDSCAPED AREAS TO BE FINISHED WITH A NATURAL TOPPING MATERIAL TO A DEPTH OF AT LEAST TWO (2) INCHES.
- 28. PLANTING & IRRIGATION (SALVAGE AND NURSERY PLANTS) SHALL BE ALLOWED OUTSIDE OF THE GRADING LIMITS.

GRADING PERMIT #2500697 LANDSCAPE PLAN FOR ENCANTADA AT ORO VALLEY MARKETPLACE 2500115

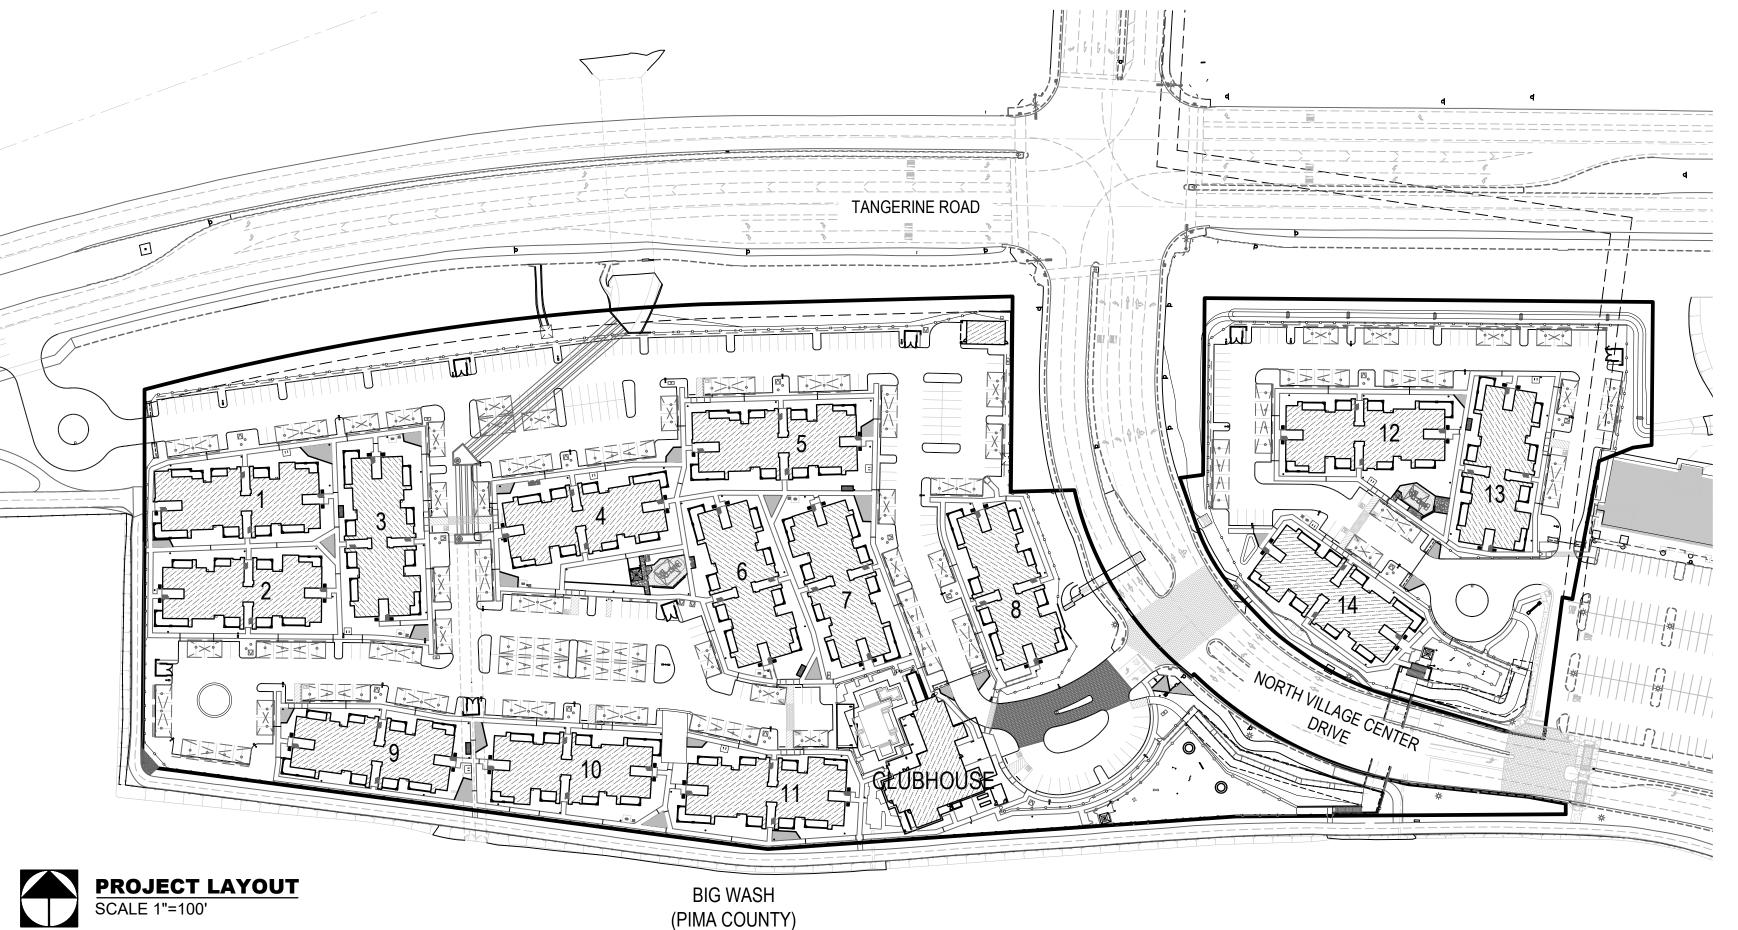

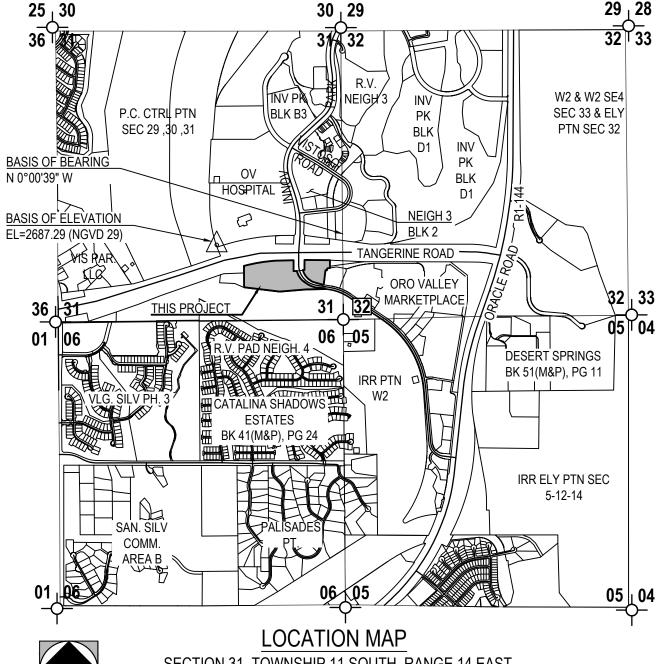

3"=1 MILE

SECTION 31, TOWNSHIP 11 SOUTH, RANGE 14 EAST **GILA & SALT RIVER MERIDIAN** TOWN OF ORO VALLEY, PIMA COUNTY, ARIZONA

OWNER/DEVELOPER

HSL CONSTRUCTION SERVICES, LLC 3901 E. BROADWAY BLVD. **TUCSON, AZ 85711** PHONE: (520) 471-7482 ATTN: MICHAEL CENSKY MIKE@HSLPROPERTIES.COM

ARCHITECT

SWAIM ASSOCIATES, LTD 7350 E. SPEEDWAY BLVD., SUITE 210 **TUCSON, AZ 85710** PHONE: (520) 326-3700 ATTN: TIM SMITH TSMITH@SWAIMAIA.COM

ENGINEER

THE WLB GROUP, INC. 4444 E. BROADWAY BLVD. **TUCSON, AZ 85711** PHONE: (520) 881-7480 ATTN: DAVID LITTLE DLITTLE@WLBGROUP.COM

LANDSCAPE ARCHITECT

THE WLB GROUP, INC. 4444 E. BROADWAY BLVD. **TUCSON, AZ 85711** PHONE: (520) 881-7480 ATTN: GARY GRIZZLE GGRIZZLE@WLBGROUP.COM

SHEET INDEX

SHEET 36 DOG ELEMENTS

PLAN NUMBER: 250015

REFERENCE NUMBER:

OV1204-30

OV1204-30A

OV1204-30U

OVWU 12-04-25

2500115W

2001300

2402389

COVER SHEET EXISTING CONDITIONS OVERALL SITE PLAN PLANT LEGEND / WATER USE SCHEDULE / NOTES SHEET 5 PLANTING PLAN (60 SCALE) SHEET 6-12 PLANTING PLAN SHEET 13 DETAILS SHEET 14 IRRIGATION LEGEND SHEET 15-21 IRRIGATION PLAN SHEET 22-23 IRRIGATION DETAILS SHEET 24 LANDSCAPE SPECIFICATIONS SHEET 25 IRRIGATION SPECIFICATIONS SHEET 26 PLAYGROUND SITE PLAN SHEET 27-28 DOG PARK SITE PLAN SHEET 29 SITE DETAILS SHEET 30 SITE DETAILS DOG PARK DETAILS SITE DETAILS SITE DETAILS POOL AREA ENTRY MONUMENT SIGN

APPROVAL

PLANNING & ZONING ADMINISTRATOR

DATE

LANDSCAPE PLAN ENCANTADA AT ORO VALLEY MARKETPLACE LOTS 1-10 AND A PORTION OF COMMON AREA "A" (OPEN SPACE)

OF ORO VALLEY MARKETPLACE

AS RECORDED IN BOOK 64 OF MAPS & PLATS AT PAGE 42

LOCATED IN A PORTION OF SECTION 31 AND 32, TOWNSHIP 11 SOUTH, RANGE 14 EAST **GILA & SALT RIVER MERIDIAN**

TOWN OF ORO VALLEY, PIMA COUNTY, ARIZONA



TURNING MOVEMENTS.


Engineering Planning Surveying Landscape Architecture Urban Design Offices located in Tucson, Phoenix and Flagstaff, Arizona, and Las Vegas, Nevada. 4444 East Broadway Tucson, Arizona (520) 881-7480

ENCANTADA AT ORO VALLEY MARKETPLACE 1640 E TANGERINE RD ORO VALLEY, ARIZONA 85737

LANDSCAPE PLAN **COVER SHEET**

File:S:\WLB\Tucson\quick\185050\H-003 OVVC Apartments\02 Landscape\06 LP\185050 ovvc encantada L1.dwg

AS SHOWN 185050-H-003 SEPTEMBER 2025 DH/CB/PR GLG/PR Checked By

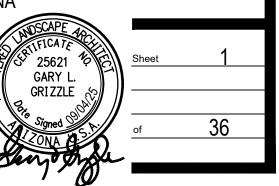

Sheet Title


Contact Arizona 811 at least two full

AR ZONASII

Call 811 or click Arizona811.com

No. Date

working days before you begin excavation

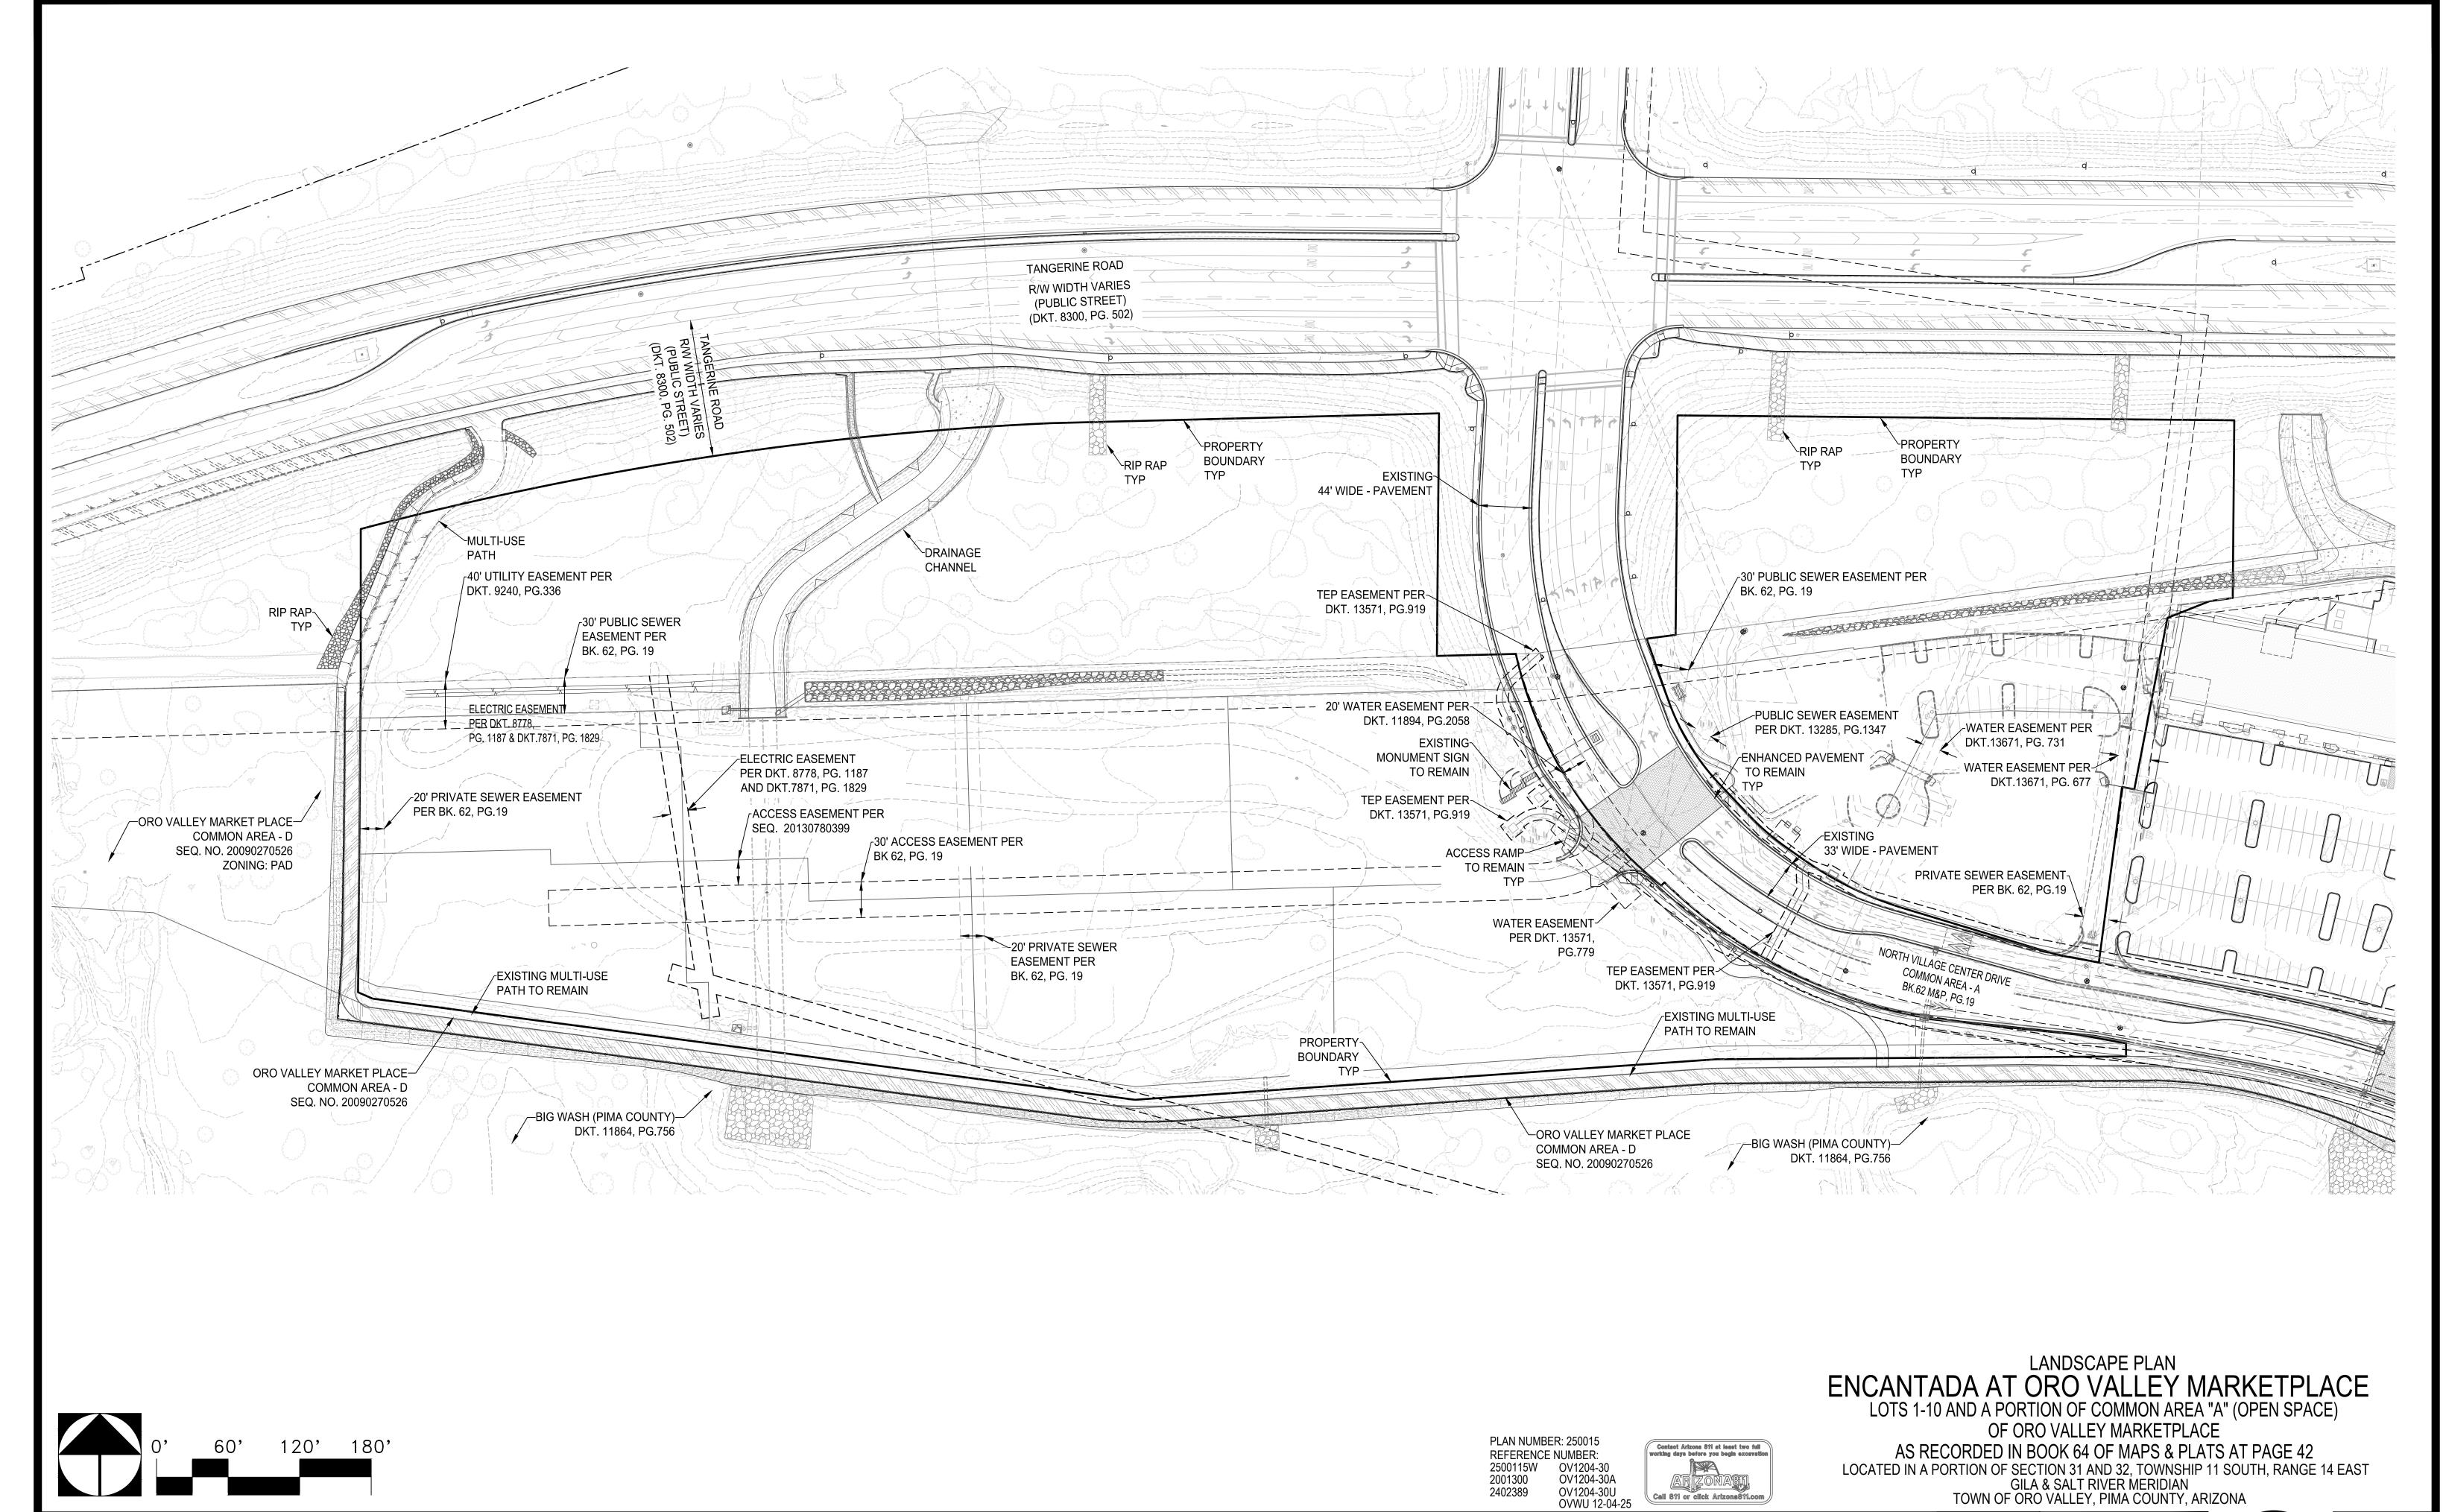



Engineering Planning Surveying Landscape Architecture Urban Design Offices located in Tucson, Phoenix and Flagstaff, Arizona, and Las Vegas, Nevada.

4444 East Broadway
Tucson, Arizona (520) 881-7480

ENCANTADA AT ORO VALLEY MARKETPLACE 1640 E TANGERINE RD ORO VALLEY, ARIZONA 85737 LANDSCAPE PLAN
EXISTING CONDITIONS

File:Q:\185050\H-003 OVVC Apartments\02 Landscape\06 LP\185050 ovvc encantada L2 extg.dwg

 Date
 Item
 Scale
 1"=60'


 Job No.
 185050-H-003

 Date
 JUNLY 2025

 Designed By
 DH/CB/PR

 Checked By
 GLG/PR



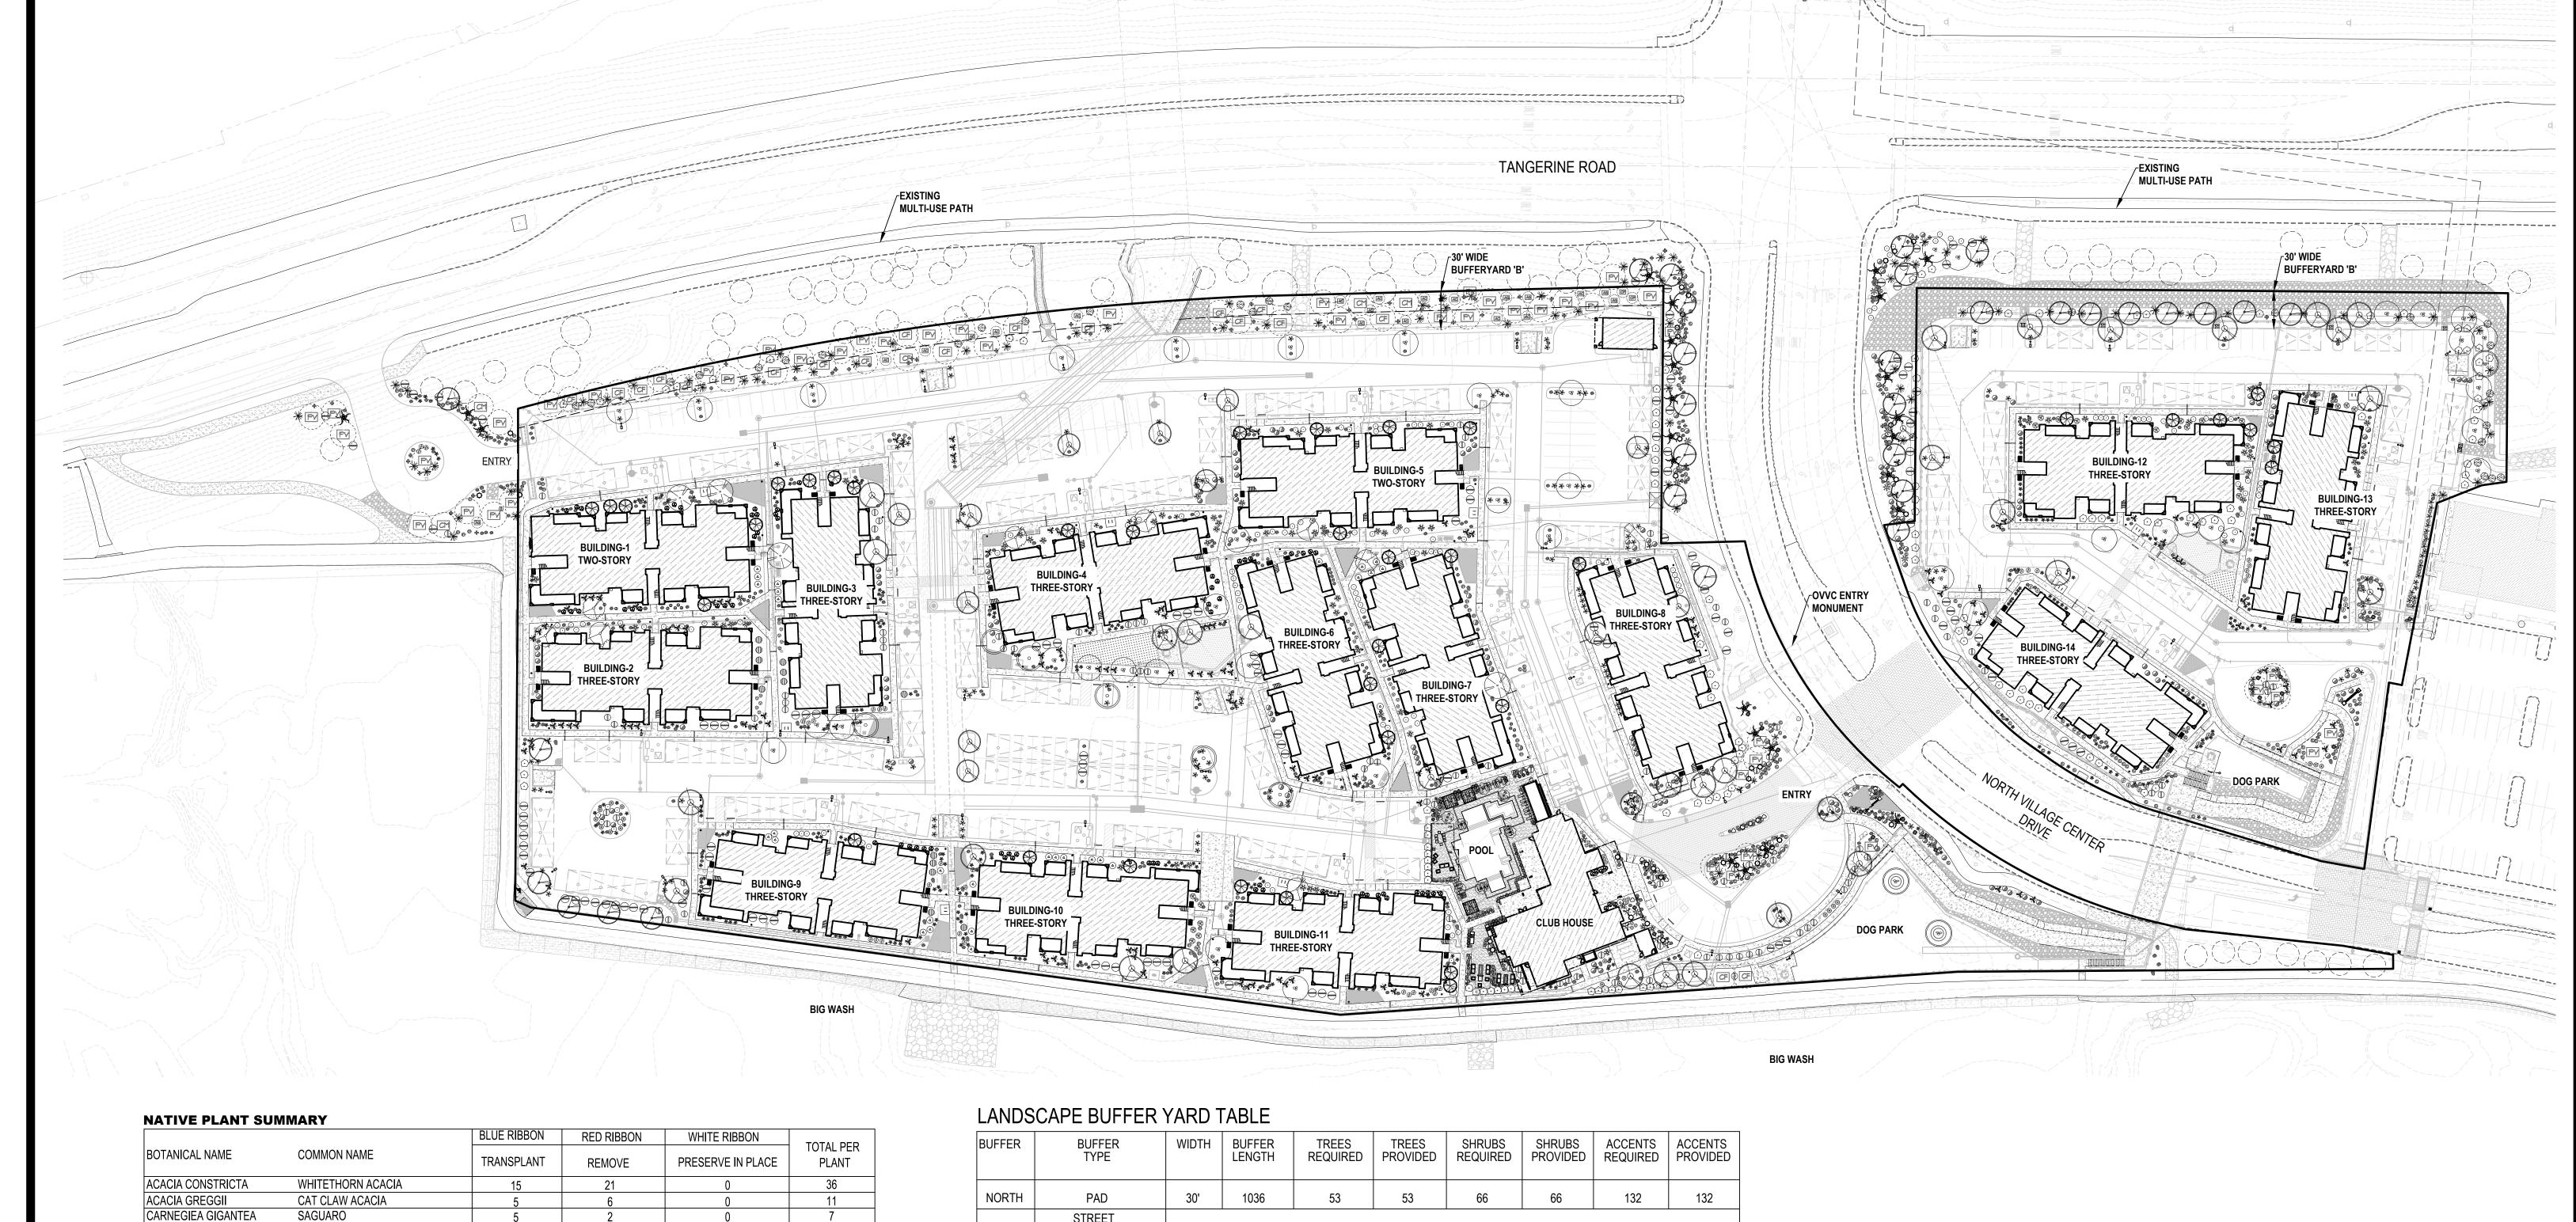





CERCIDIUM MICROPHYLLUM FOOTHILL PALO VERDE

DESERT HACKBERRY BLUE PALO VERDE

FISH-HOOK BARREL

VELVET MESQUITE

OCOTILLO

GREYTHORN

| BUFFER TYPE | WIDTH | BUFFER LENGTH | TREES REQUIRED | TREES PROVIDED | SHRUBS REQUIRED | SHRUBS PROVIDED | ACCENTS REQUIRED | ACCENTS PROVIDED |
|-----------------------------|----------------------------------|--------------------------------------|---|--|---|--|---|--|
| PAD | 30' | 1036 | 53 | 53 | 66 | 66 | 132 | 132 |
| STREET WATER HARVEST WAY | NONE REQUIRED | | | | | | | |
| PAD | NONE REQUIRED | | | | | | | |
| PAD | NONE REQUIRED | | | | | | | |
| V | PAD STREET VATER HARVEST WAY PAD | PAD 30' STREET VATER HARVEST WAY PAD | PAD 30' 1036 STREET VATER HARVEST WAY PAD | PAD 30' 1036 53 STREET VATER HARVEST WAY PAD | PAD 30' 1036 53 53 STREET VATER HARVEST WAY PAD N | PAD 30' 1036 53 53 66 STREET VATER HARVEST WAY PAD NONE REQUIRED NONE REQUIRED NONE REQUIRED | TYPE LENGTH REQUIRED PROVIDED REQUIRED PROVIDED PAD 30' 1036 53 53 66 66 STREET VATER HARVEST WAY PAD NONE REQUIRED NONE REQUIRED | PAD 30' 1036 53 53 66 66 132 STREET VATER HARVEST WAY PAD NONE REQUIRED NONE REQUIRED NONE REQUIRED |

PLAN NUMBER: 250015 REFERENCE NUMBER: OV1204-30 OV1204-30A OV1204-30U OVWU 12-04-25 2500115W 2001300 2402389

Contact Arizona 811 at least two full working days before you begin excavation AR ZONASII.

Call 811 or click Arizona811.com

LANDSCAPE PLAN ENCANTADA AT ORO VALLEY MARKETPLACE LOTS 1-10 AND A PORTION OF COMMON AREA "A" (OPEN SPACE) OF ORO VALLEY MARKETPLACE AS RECORDED IN BOOK 64 OF MAPS & PLATS AT PAGE 42

LOCATED IN A PORTION OF SECTION 31 AND 32, TOWNSHIP 11 SOUTH, RANGE 14 EAST GILA & SALT RIVER MERIDIAN TOWN OF ORO VALLEY, PIMA COUNTY, ARIZONA

| The | KTA | |
|-------|-----|-----|
| WLB \ | | IJK |

CELTIS PALLIDA

CERCIDIUM FLORIDIUM

FEROCACTUS WISLIZNEII

FOUQUIERIA SPLENDENS

PROSOPIS VELUTINA

ZIZYPHUS OBTUSIFOLIA

Engineering Planning Surveying Landscape Architecture Urban Design Offices located in Tucson, Phoenix and Flagstaff, Arizona, and Las Vegas, Nevada. 4444 East Broadway Tucson, Arizona (520) 881-7480

ENCANTADA AT ORO VALLEY MARKETPLACE 1640 E TANGERINE RD ORO VALLEY, ARIZONA 85737

123

195

Sheet Title LANDSCAPE PLAN LANDSCAPE OVERVIEW File:S:\WLB\Tucson\quick\185050\H-003 OVVC Apartments\02 Landscape\06 LP\185050 ovvc encantada L3 overview.dwg

185050-H-003 SEPTEMBER 2025 DH/CB/PR GLG/PR Checked By



| SYMBOL | PLANT NAME | QUANTITY | SIZE | WATER USE TYPE (NEEDS) | ADWR ANNUAL USE AT MATURITY (GALLONS) | ANNUAL WATER USE QUANTITY TIMES ADWR ANNUAL USE (GALLONS) | MONTHLY WATER USE ADWR ANNUAL USE DIVIDED BY 12 MONTHS |
|------------------------------------|--|----------|------------|------------------------|--|---|--|
| | TREES | | | | | | |
| ` (| CERCIDIUM MICROPHYLLUM | 30 | 24" Box | 1 | 1,754 | 52,620 | 4,385 |
| $\mathbb{M} \setminus \mathcal{N}$ | FOOTHILL PALO VERDE | 4 | Transplant | 1 | 1,754 | 7,016 | 585 |
| | CERCIDIUM PRAECOX PALO BREA | 6 | 24" Box | 2 | 3,960 | 23,760 | 1,980 |
| | CERCIDIUM FLORIDUM BLUE PALO VERDE | 20 | Transplant | 2 | 5,702 | 114,040 | 9,503 |
| | CHILOPSIS LINEARIS 'BUBBA JONES' BUBBA JONES DESERT WILLOW | 46 | 24" Box | 2 | 5,702 | 262,292 | 21,858 |
| | PROSOPIS GLANDULOSA MAVERICK MAVERICK HYBRID MESQUITE | 3 | 24" Box | 2 | 5,702 | 17,106 | 1,426 |
| | PROSOPIS VELUTINA | 28 | 24" Box | 2 | 5,702 | 159,656 | 13,305 |
| (% | VELVET MESQUITE | 7 | 36" Box | 2 | 5,702 | 39,914 | 3,326 |
| $_{\square}$ $\setminus\setminus$ | The state of the s | 7 | 48" Box | 2 | 5,702 | 39,914 | 3,326 |
| \bigvee | | 47 | Transplant | 2 | 5,702 | 267,994 | 22,333 |
| ' | TOTAL WATER AT MATURITY (TREES) | | | | | | 53,041 |

| NOTE: BOXED TREE SIZES AND LOCATIONS ARE NOTED ON PLAN | S |
|--|---|

EXISTING TREES / VEGETATION TO REMAIN

| SYMBOL | PLANT NAME | QUANTITY | SIZE | WATER USE TYPE (NEEDS) | ADWR ANNUAL USE AT MATURITY (GALLONS) | ANNUAL WATER USE QUANTITY TIMES ADWR ANNUAL USE (GALLONS) | MONTHLY WATER USE ADWR ANNUAL USE DIVIDED BY 12 MONTHS |
|------------|---|----------|------------|------------------------|--|---|--|
| | SHRUBS | | | | | | |
| (AC) | ACACIA CONSTRICTA WHITETHORN ACACIA | 15 | Transplant | 1 | 1,754 | 26,310 | 2,193 |
| (AG) | ACACIA GREGGII CAT CLAW ACACIA | 5 | Transplant | 1 | 1,754 | 8,770 | 731 |
| | CALLIANDRA ERIOPHYLLA PINK FAIRY DUSTER | 186 | 5 Gallon | 1 | 439 | 81,654 | 6,805 |
| | CELTIS PALLIDA DESERT HACKBERRY | 2 | Transplant | 1 | 634 | 1,268 | 106 |
| | CORDIA PARVIFOLIA LITTLE LEAF CORDIA | 27 | 5 Gallon | 1 | 439 | 11,853 | 988 |
| + | DODONEA VISCOSA GREEN HOPSEED BUSH | 120 | 5 Gallon | 1 | 632 | 75,840 | 6,320 |
| | ENCELIA FARINOSA BRITTLEBUSH | 19 | 5 Gallon | 1 | 39 | 741 | 62 |
| | HAPLOPAPPUS LARICIFOLIUS 'BUTTERBLOOM' TURPENTINE (ERICAMERIA) | 124 | 5 Gallon | 1 | 70 | 8,680 | 723 |
| * | JUSTICIA CALIFORNCA CHUPAROSA | 99 | 5 Gallon | 2 | 101 | 9,999 | 833 |
| \bigcirc | SIMMONDSIA CHINENSIS JOJOBA | 115 | 5 Gallon | 1 | 281 | 32,315 | 2,693 |
| 0 | VIGUIERA DELTOIDEA GOLDEN EYE | 224 | 5 Gallon | 2 | 57 | 12,768 | 1,064 |
| | TOTAL WATER AT MATURITY (SHRUBS) | | | | | | 22,517 |

| WINTER | | SPRING | | | SUMMER | MONSOON | | | W | VINTER | |
|--|--|--|--------------------|---|---------------------------------|---------------------------------|------------------------|--------------------------|------------------------|--------------------|-----------------------------------|
| MONTH | | | | | | | | 1,590,837 | | | |
| 1 | 2 | 3 | 4 | 5 | 6 | 7 | 8 | 9 | 10 | 11 | 12 |
| YEAR 3: | | | **** | *************************************** | | | | | | | |
| CONTINUE TO | INCREASE I | RRIGATION W. | ATER USE | AS NEEDED | AS PLANTS | MATURE UP T | O, BUT NOT E | EXCEEDING, | 100% ADWR \ | VALUE BY EN | ND OF |
| YEAR. | | | | | | | | | | | |
| 139,368 | 149,638 | 156,973 | 168,709 | 173,110 | 173,110 | 118,830 | 118,830 | 136,434 | 146,704 | 140,835 | 137,90 |
| • | • | TOTAL (100% | ADWR) | | GAL/YEAR | | | • | • | • | 17604 |
| | | 1017 | <i>.</i> — , | | | | | | | | |
| YEAR 4: | | 10172 (100% | | | | | | | | | |
| YEAR 4: BEGIN GRADUA | | | | UFFER MEDI | AN AND ROV | W AREAS IN O | RDER TO RE | ACH ZERO IR | RIGATION IN | THOSE ARE | AS BY EN |
| | | | | UFFER MEDI | AN AND ROV | W AREAS IN O | RDER TO RE | ACH ZERO IR | RIGATION IN | THOSE ARE | AS BY EN |
| BEGIN GRADUA | | | | UFFER MEDI 129,833 | AN AND ROV | | RDER TO RE. | ACH ZERO IR 102,326 | RIGATION IN | THOSE ARE | AS BY EN 103,42 |
| BEGIN GRADUA OF YEAR 5. | 112,228 | EASING IRRIGA | ATION TO BI | | | 89,122 | | | | | |
| BEGIN GRADUA OF YEAR 5. | 112,228 | EASING IRRIGA | ATION TO BI | | 129,833 | 89,122 | | | | | 103,42 |
| BEGIN GRADUA OF YEAR 5. 104,526 | 112,228 | EASING IRRIGA 117,730 TOTAL (75% A | 126,532 ADWR) | 129,833 | 129,833 GAL/YEAR | 89,122 | 89,122 | 102,326 | 110,028 | 105,627 | 103,42 13203 |
| BEGIN GRADUA OF YEAR 5. 104,526 YEAR 5: | ALLY DECRE 112,228 CREASING IF | EASING IRRIGA 117,730 TOTAL (75% A | 126,532 ADWR) | 129,833 MEDIAN, AND | 129,833 GAL/YEAR ROW AREA | 89,122 4S. BY END OF | 89,122 FYEAR 5 IRRK | 102,326 GATION TO B | 110,028 UFFER, MEDI | 105,627 AN AND ROV | 103,42 13203 V AREAS |
| BEGIN GRADUA OF YEAR 5. 104,526 YEAR 5: CONTINUE DEC | ALLY DECRE 112,228 CREASING IF | EASING IRRIGA 117,730 TOTAL (75% A | 126,532 ADWR) | 129,833 MEDIAN, AND | 129,833 GAL/YEAR ROW AREA | 89,122 4S. BY END OF | 89,122 FYEAR 5 IRRK | 102,326 GATION TO B | 110,028 UFFER, MEDI | 105,627 AN AND ROV | 103,42 13203 V AREAS |
| BEGIN GRADUA OF YEAR 5. 104,526 YEAR 5: CONTINUE DEC | ALLY DECRE 112,228 CREASING IF | EASING IRRIGA 117,730 TOTAL (75% A | 126,532 ADWR) | 129,833 MEDIAN, AND | 129,833 GAL/YEAR ROW AREA | 89,122 AS. BY END OF 50% OF ADW | 89,122 FYEAR 5 IRRK | 102,326 GATION TO B | 110,028 UFFER, MEDI | 105,627 AN AND ROV | 103,42 13203 V AREAS |

| SYMBOL | PLANT NAME | QUANTITY | SIZE | WATER USE TYPE (NEEDS) | ADWR ANNUAL USE AT MATURITY (GALLONS) | ANNUAL WATER USE QUANTITY TIMES ADWR ANNUAL USE (GALLONS) | MONTHLY WATER USE ADWR ANNUAL USE DIVIDED BY 12 MONTHS |
|--------------|--|----------|-------------------------------|------------------------|--|---|--|
| | ACCENTS | | | 0 | | | |
| X | AGAVE MURPHEYI MURPHY AGAVE | 11 | 5 Gallon | | 70 | 770 | 64 |
| =3 | AGAVE VICTORIA REGINAE VICTORIA REGINA AGAVE | 3 | 5 Gallon | | 70 | 210 | 18 |
| \bigcirc | ASCLEPIAS LINEARIS 'MONARCH MAGNET' PINELEAF MILKWEED 'MONARCH MAGNET' | 48 | 3 / 5 Gallon | 2 | 57 | 2,736 | 228 |
| \ | CARNEGIA GIGANTEA SAGUARO | 5 34 | Transplant 4' - 6' Spear | 2 | 2,741 2,741 | 13,705 93,194 | 1,142 7,766 |
| * | DASYLIRION WHEELERI DESERT SPOON | 89 | 5 Gallon | 1 | 70 | 6,230 | 519 |
| 0 | ECHINOCACTUS GRUSONII GOLDEN BARREL | 12 | 6"- 8" Diameter | 1 | 70 | 840 | 70 |
| ₽ | FEROCACTUS WISLIZENII FISHHOOK BARREL CACTUS | 5 87 | Transplant 6"- 8" Diameter | 2 | 101 101 | 505 8,787 | 42 732 |
| | FOUQUIERIA SPLENDENS OCOTILLO | 4 21 | Transplant 6' - 8' Canes | 2 | 281 281 | 1,124 5,901 | 94 492 |
| * | HESPERALOE FUNIFERA GIANT HESPERALOE | 4 | 5 Gallon | 1 | 70 | 280 | 23 |
| X | HESPERALOE PARVIFLORA RED YUCCA | 153 | 5 Gallon | 1 | 70 | 10,710 | 893 |
| * | HESPERALOE PARVIFLORA 'BRAKELIGHTS' BRAKELIGHTS RED YUCCA | 339 | 3 / 5 Gallon | 1 | 70 | 23,730 | 1,978 |
| and Such | MASCAGNIA MACROPTERA YELLOW ORCHID VINE | 6 | 5 Gallon (2) per Trellis | 1 | 3,960 | 23,760 | 1,980 |
| * | NOLINA MICROCARPA BEAR GRASS | 141 | 5 Gallon | 1 | 158 | 22,278 | 1,857 |
| © | PEDILANTHUS MACROCARPUS LADY SLIPPER | 53 | 3 / 5 Gallon | 1 | 158 | 8,374 | 698 |
| 業 | YUCCA RIGIDA BLUE YUCCA | 9 | 15 Gallon | 1 | 281 | 2,529 | 211 |
| | TOTAL WATER AT MATURITY (ACCENTS) | | | | | | 13,979 |
| | TOTAL WATER AT MATURITY (TREES, SHRUBS | | | | | 1,423,232 | 89,536 |

HYDROSEED

HYDROSEED MIX SHALL BE ORO VALLEY APPROVED SEED MIX "D". HYDROSEED SHALL BE APPLIED AS INDICATED TO ALL DISTURBED AREAS NOT OTHERWISE IMPROVED.

AREA TO BE HYDROSEEDED SHALL INCORPORATE THE USE OF IMPRINTING OR PITTING OF THE SOIL. REVEGETATION IS REQUIRED TO RESTORE NATURAL VEGETATION ON DISTURBED LAND. TIMING OF REVEGETATION SHALL BE PLANTED TO MAXIMIZE AVAILABILTY OF RAINFALL. SEED MIX SHALL BE PER OVZCR ADDENDUM "D", SPECIES AS FOLLOWS:

ORO VALLEY APPROVED REVEGETATION SEED MIX 'D'

Key: A = Annual; P = Perennial; C = Germinates and thrives in the cool season;

W = Germinates and thrives in warm season; C/W = Germinates and thrives in cool/warm seasons.

SHRUBS: minimum of 5 PLS/acre Acacia constricta, Whitethorn Acacia (P,W) Celtis pallida, Desert Hackberry (P,C/W) Encelia farinosa, Brittlebush (P,C/W) Haplopappus Iaricifolius [=Ericameria Iaricifolia], Turpentine Bush (P,C,W)

SMALL PERENNIALS: minimum of 5 PLS/acre Bahia absinthifolia, Desert Bahia (P,C) Baileya multiradiata, Desert Marigold (P,C/W) Cassia [= Senna] covesii, Desert Senna (P,W) Isocoma tenuisecta, Burrowwed (P,C/W) Psilostrophe cooperi, Paper Flower (P,C/W) Sphaeralcea ambigua, Desert Globemallow (P,C,W) Zinnia pumila, Desert Zinnia (P, C)

PERENNIAL GRASSES: minimum of 5 PLS/acre Aristida purpurea, Purple Three-Awn (P,W) Bouteloua curtipendula, Side-Oats Grama (P,W) Digitaria californica, Arizona Cottontop (P,W) Erioneuron pulchellum, Fluffgrass (P,C) Heteropogon contortus, Tanglehead (P,W) Muhlenbergia porteri, Bush Muhly (P,W) Pappophorum mucronulatum, Pappus Grass (P,W) Sporobolus cryptandrus, Sand Dropseed (P,W)

ANNUAL HERBS AND GRASSES: minimum of 5 PLS/acre Erigeron divergens, Spreading Fleabane (A,W) schscholtzia mexicana, Mexican Poppy (A,C) Evolvulus arizonicus, Arizona Blue Eyes (A,C) Lupinus arizonicus, Arizona Lupine (A,W) Lupinus concinnus, Bajada Lupine (A,W) Lupinus sparsiflorus, Desert Lupine (A,W) Orthocarpus purpurascens, Owlclover (A,C) Penstemon parryi, Parry's Penstemon (P,A,C/W) Penstemon subulatus, Scarlet Buglar (P,A,C/W) Salvia columbariae, Chia (A,C) Sphaeralcea coulteri, Globemallow (A,C)

PLAN NUMBER: 250015

REFERENCE NUMBER:

2500115W 2001300

2402389

OV1204-30 OV1204-30A

OV1204-30U

OVWU 12-04-25



SYNTHETIC TURF

MASTER TURF DAYTONA 60

WITH CRUMB RUBBER (30% CRUMB RUBBER AND 70% SILICA SAND)

RIP RAP

RIP RAP COLOR: "APACHE BROWN" OR EQUAL

| BOULDERS - | APACHE RED | | (OWNER TO APPROVE) | |
|------------|------------|------------|--------------------|--|
| SYMBOL | QTY | SIZE (FT.) | COMMENTS | |
| ③ | 423 | 1 X 2 X 2 | | |
| | 62 | 2 X 2 X 3 | | |
| 3 | 37 | 3 X 3 X 3 | | |

DECORATIVE ROCK

2" MIN. DEPTH 3/4" SCREENED ON FLAT AREAS AND 1-1/4" SCREENED ON SLOPES AND IN FLOW CHANNELS. COLOR: "APACHE BROWN"

1/4" MINUS

APPLY TO ALL PLANTED AREAS AND AREAS NOT COVERED BY BUILDINGS, PAVEMENT, OR HYDROSEED

DECOMPOSED GRANITE WITHIN DOG PARK AREA

Contact Arizona 811 at least two full

Call 811 or click Arizona811.com

2" MINUMUM DEPTH COLOR: DESERT GOLD DECORATIVE ROCK

LANDSCAPE PLAN ENCANTADA AT ORO VALLEY MARKETPLACE LOTS 1-10 AND A PORTION OF COMMON AREA "A" (OPEN SPACE)

OF ORO VALLEY MARKETPLACE

AS RECORDED IN BOOK 64 OF MAPS & PLATS AT PAGE 42 LOCATED IN A PORTION OF SECTION 31 AND 32, TOWNSHIP 11 SOUTH, RANGE 14 EAST GILA & SALT RIVER MERIDIAN TOWN OF ORO VALLEY, PIMA COUNTY, ARIZONA



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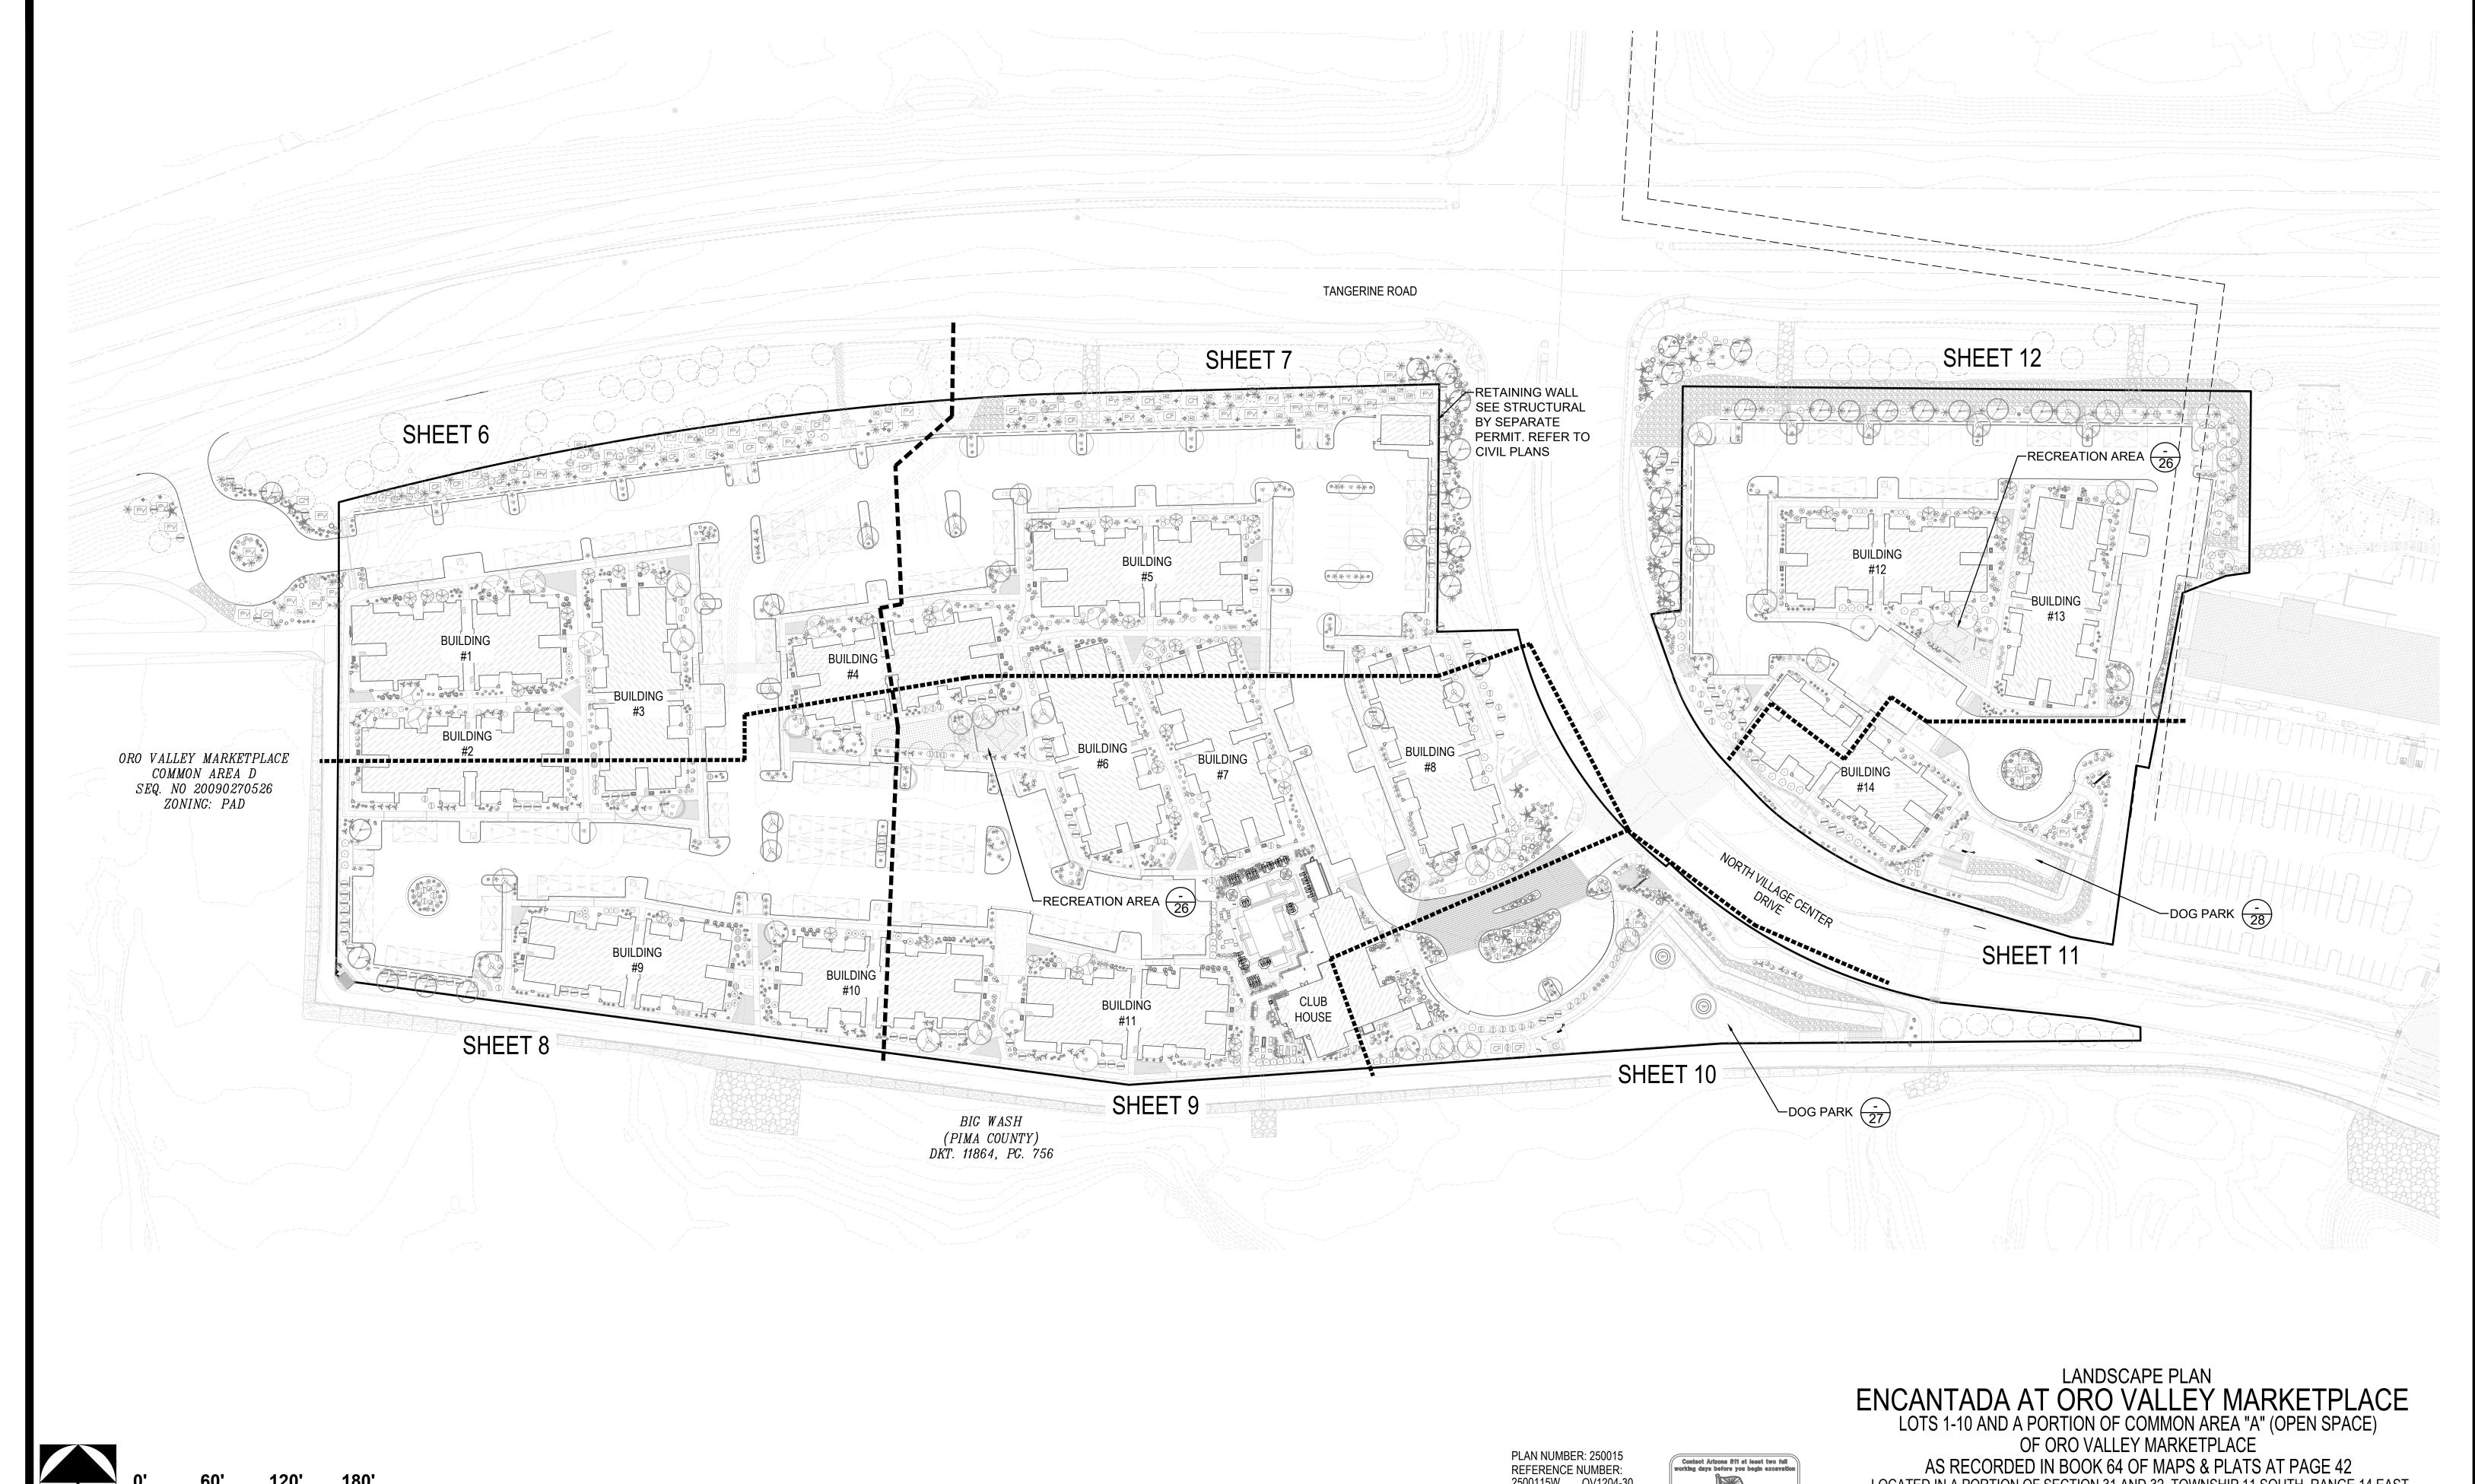
ENCANTADA AT ORO VALLEY MARKETPLACE 1640 E TANGERINE RD ORO VALLEY, ARIZONA 85737


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No. Date 185050-H-003 Job No. **JUNLY 2025** DH/CB/PR Designed By GLG/PR Checked By







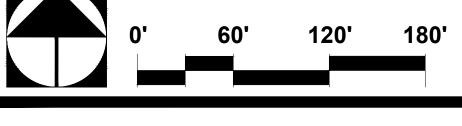

PLAN NUMBER: 250015 REFERENCE NUMBER: 2500115W OV1204-30 2001300 OV1204-30A 402389 OV1204-30U OVWU 12-04-25

Contact Arizona 811 at least two full working days before you begin excavation AR ZONASII.

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LOCATED IN A PORTION OF SECTION 31 AND 32, TOWNSHIP 11 SOUTH, RANGE 14 EAST GILA & SALT RIVER MERIDIAN TOWN OF ORO VALLEY, PIMA COUNTY, ARIZONA

SEPTEMBER 2025

DH/CB/PR

GLG/PR



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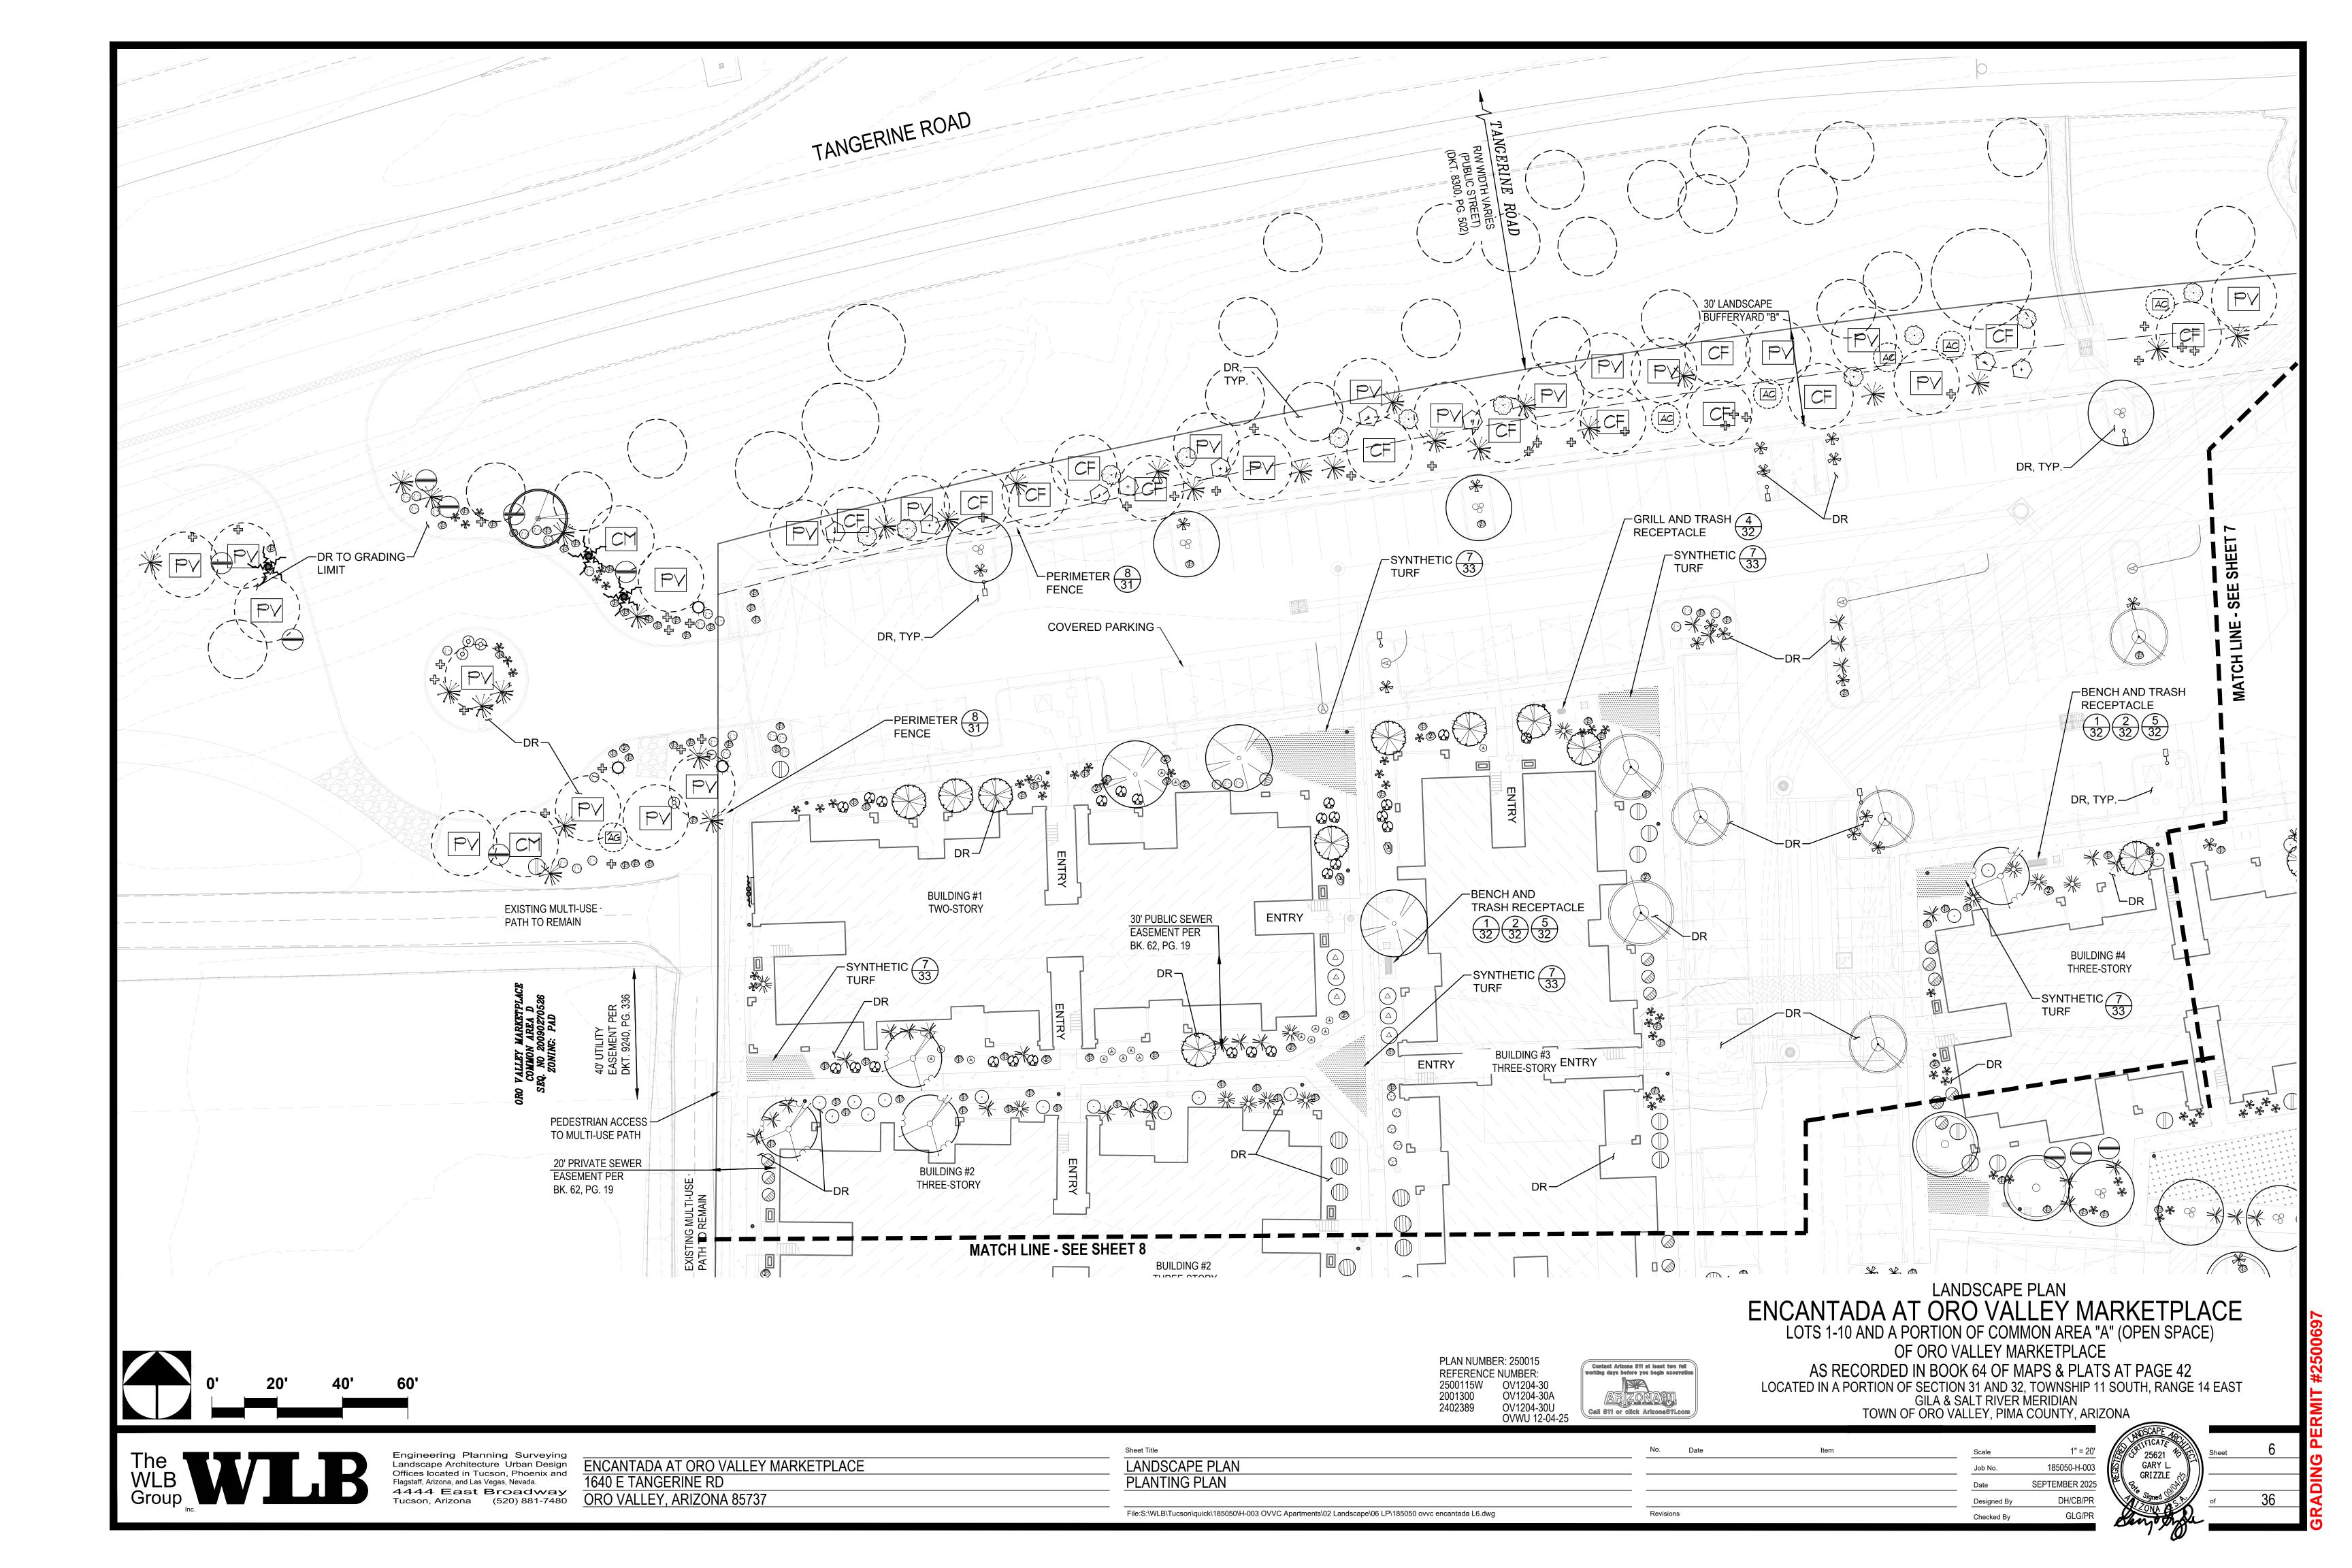
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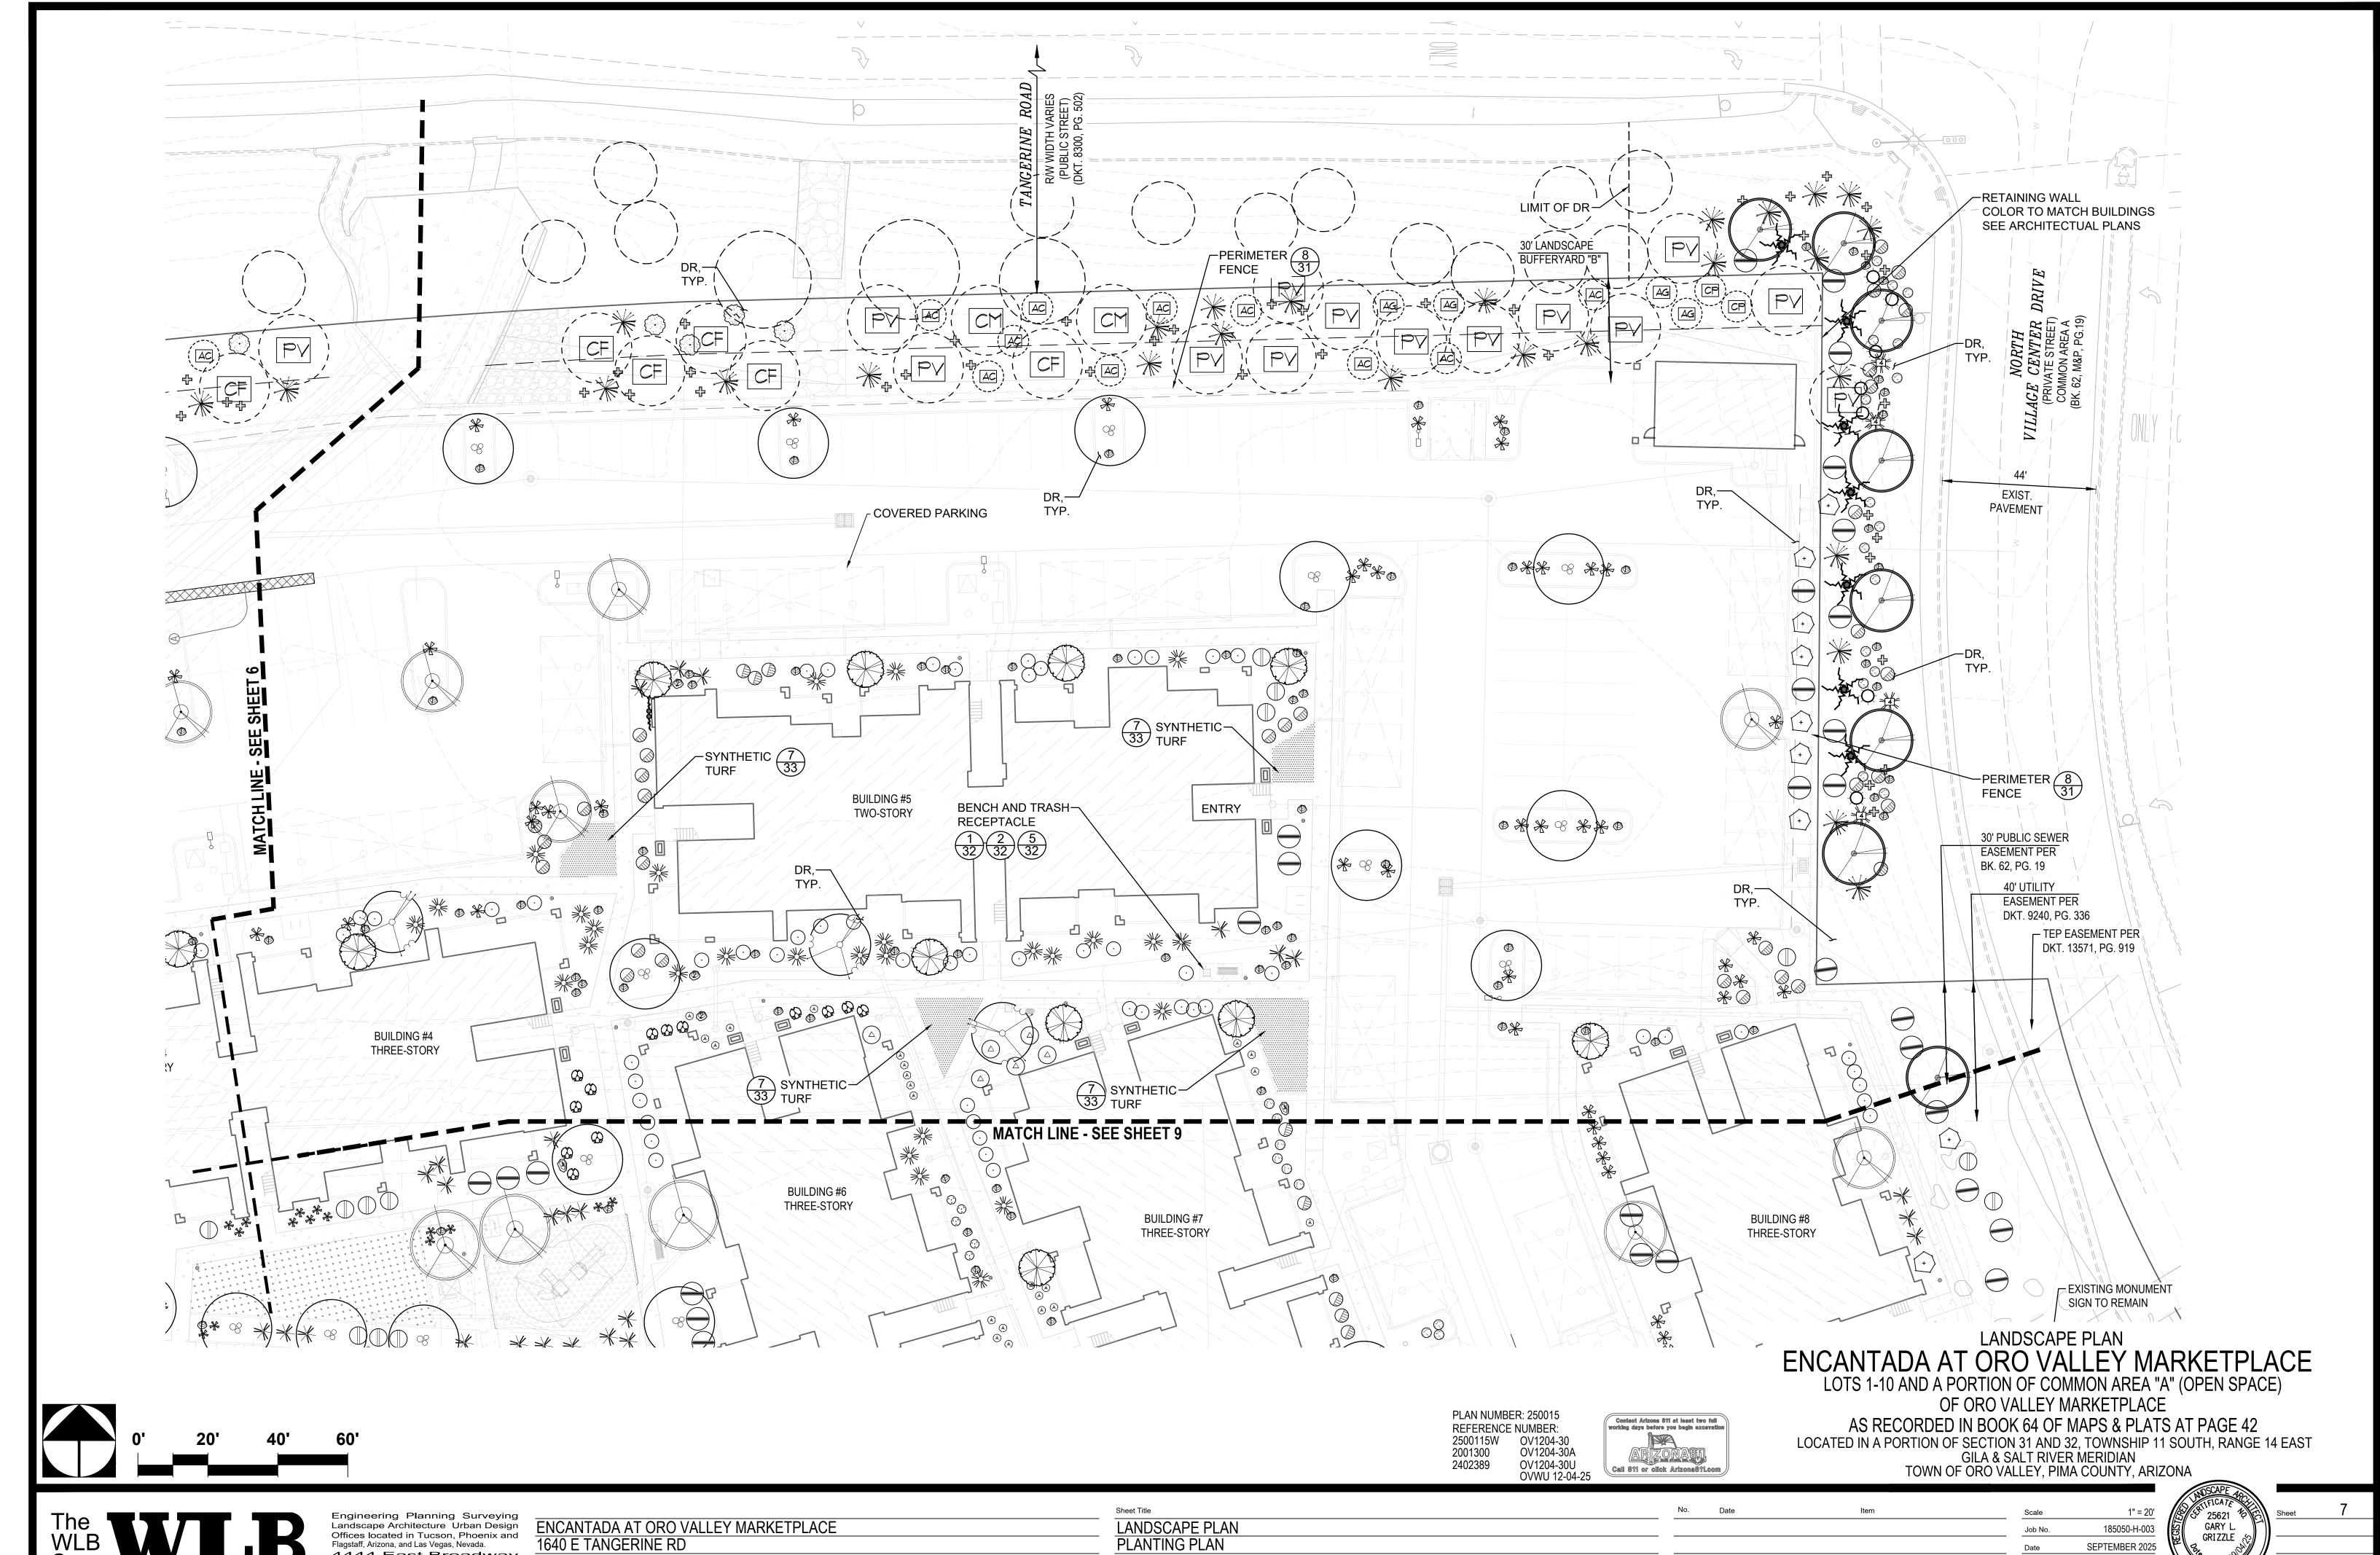
ENCANTADA AT ORO VALLEY MARKETPLACE 1640 E TANGERINE RD ORO VALLEY, ARIZONA 85737

| | Sheet Title |
|---|--|
| _ | LANDSCAPE PLAN |
| | PLANTING PLAN |
| _ | |
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Job No. Checked By








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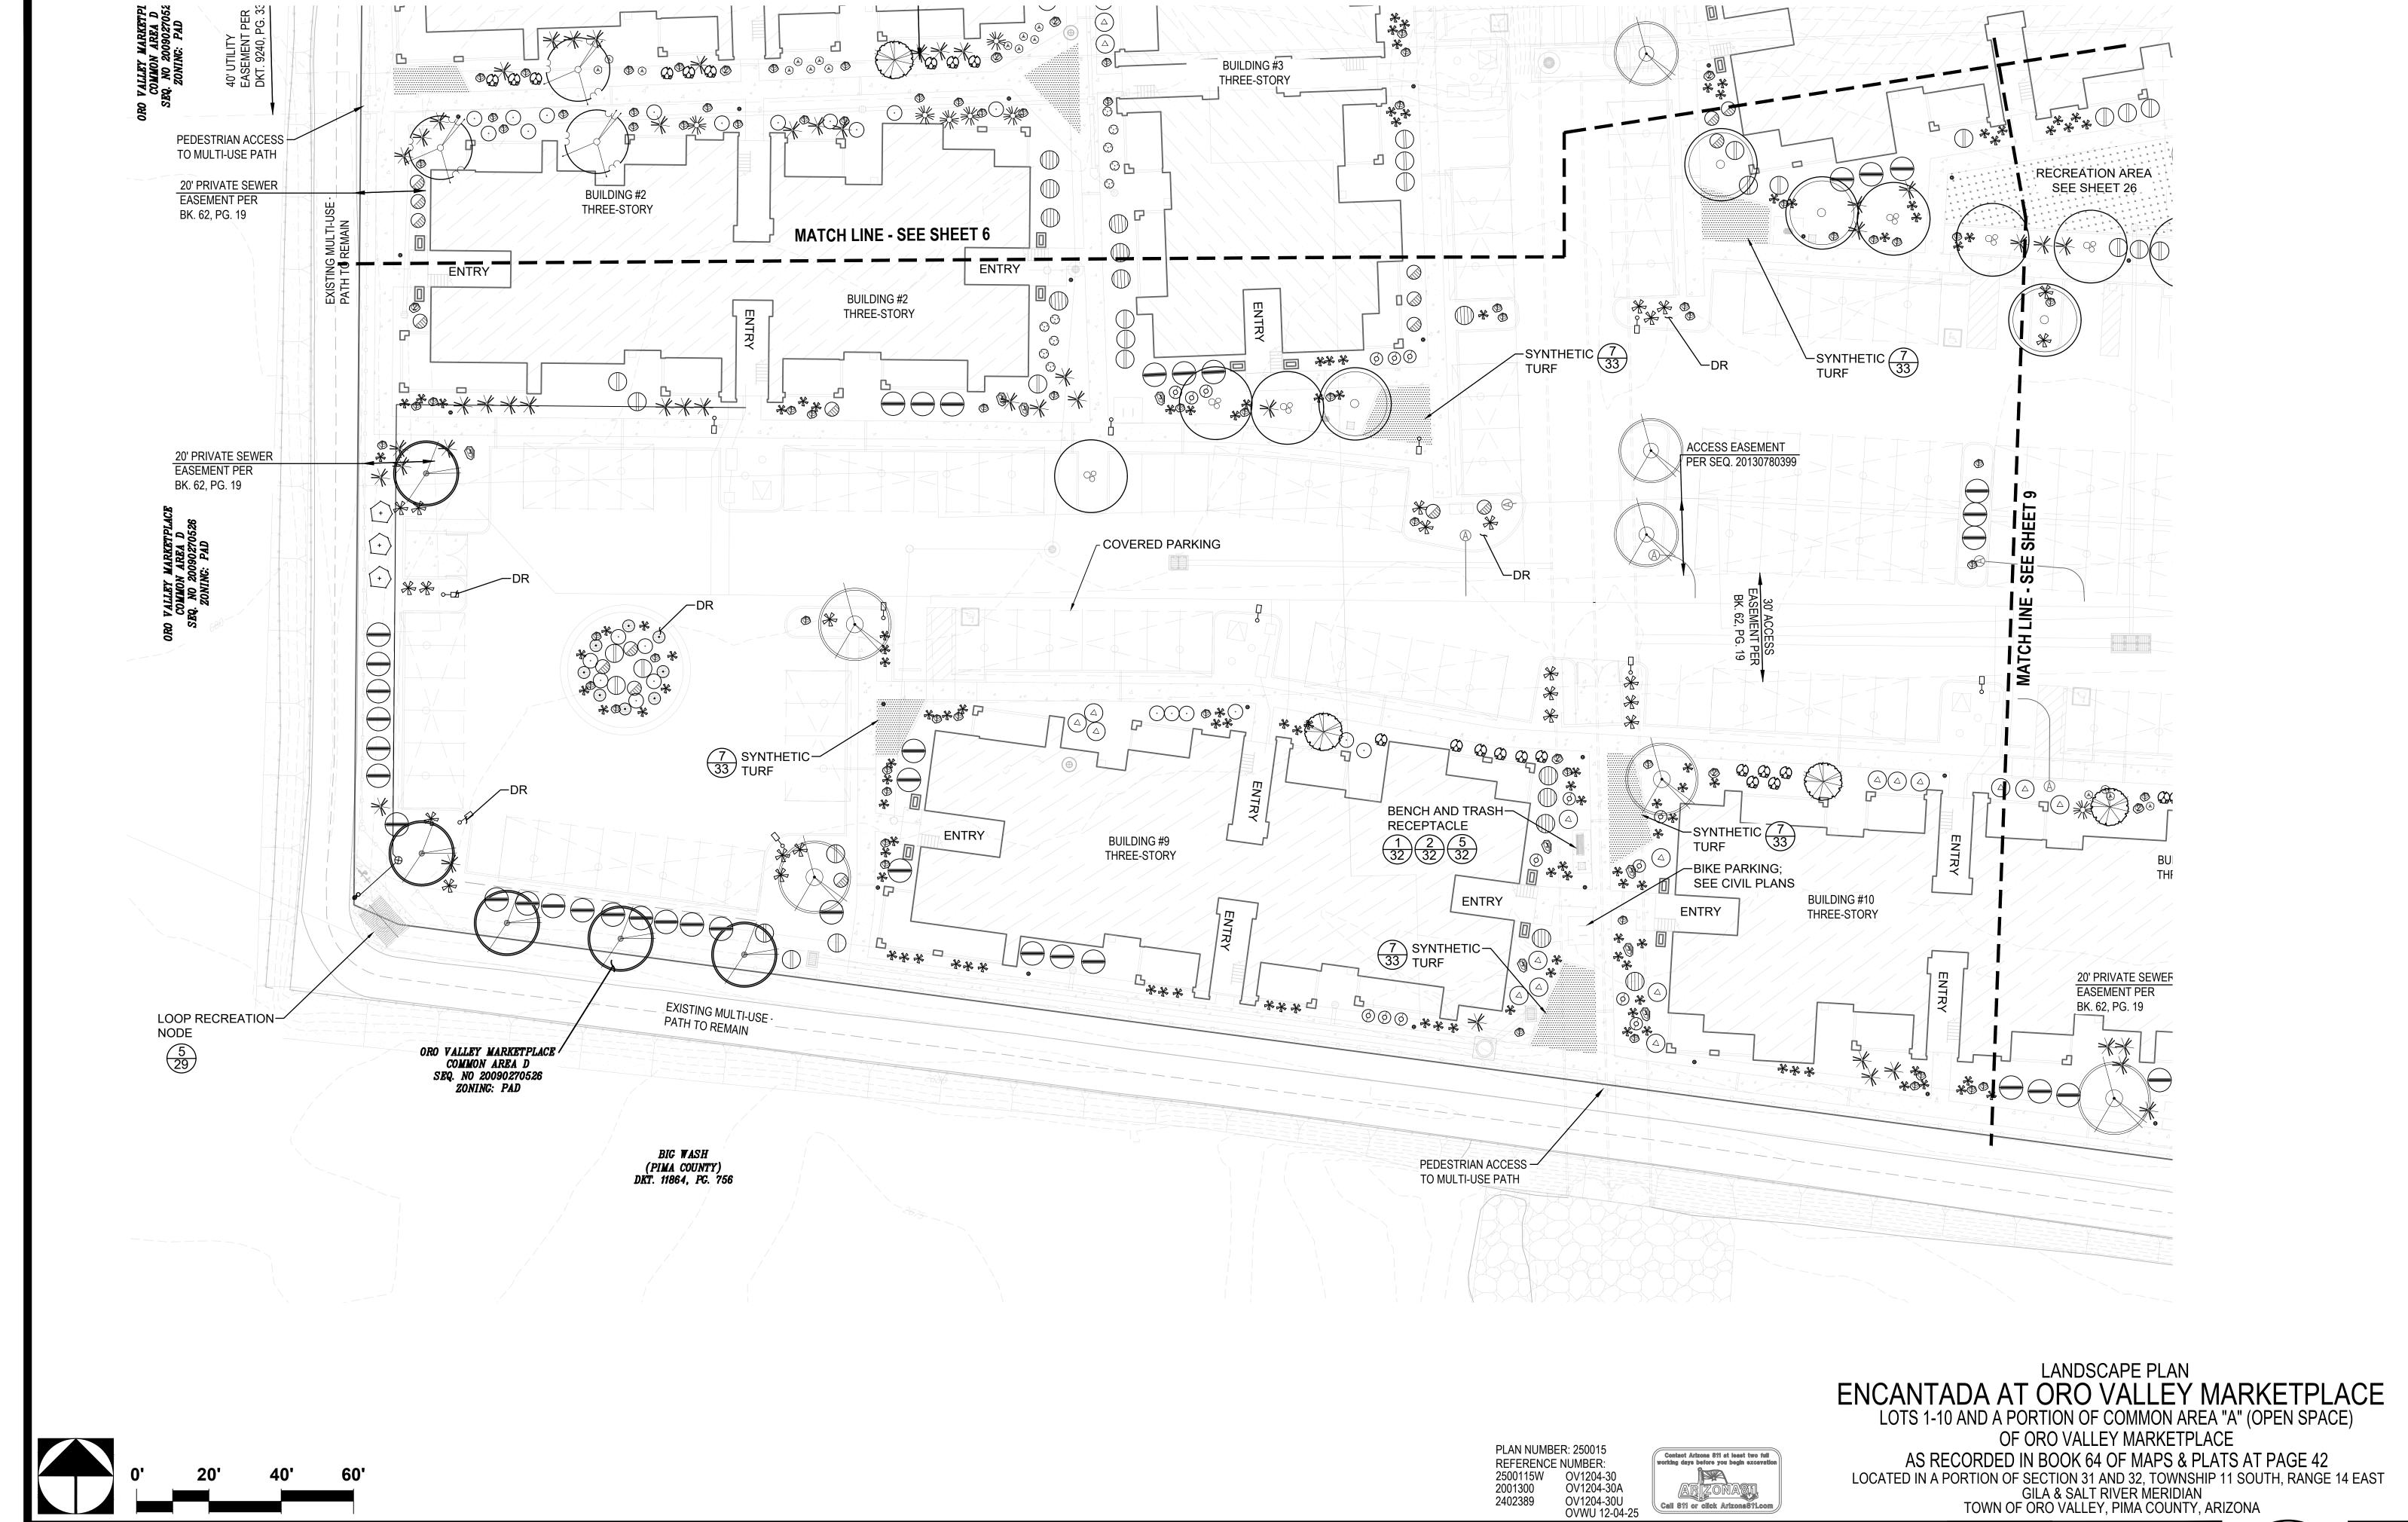
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ORO VALLEY, ARIZONA 85737

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SEPTEMBER 2025 DH/CB/PR GLG/PR Checked By





Sheet Title

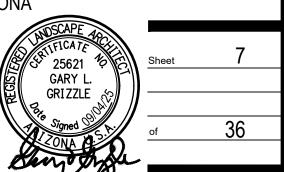LANDSCAPE PLAN

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PLANTING PLAN

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Flagstaff, Arizona, and Las Vegas, Nevada.

ENCANTADA AT ORO VALLEY MARKETPLACE 1640 E TANGERINE RD

ORO VALLEY, ARIZONA 85737

Sheet 8

Sheet 8

Sheet 8

Sheet 8

Sheet 36

GRIZZLE


Of 36

185050-H-003


JUNLY 2025

DH/CB/PR GLG/PR

Job No.

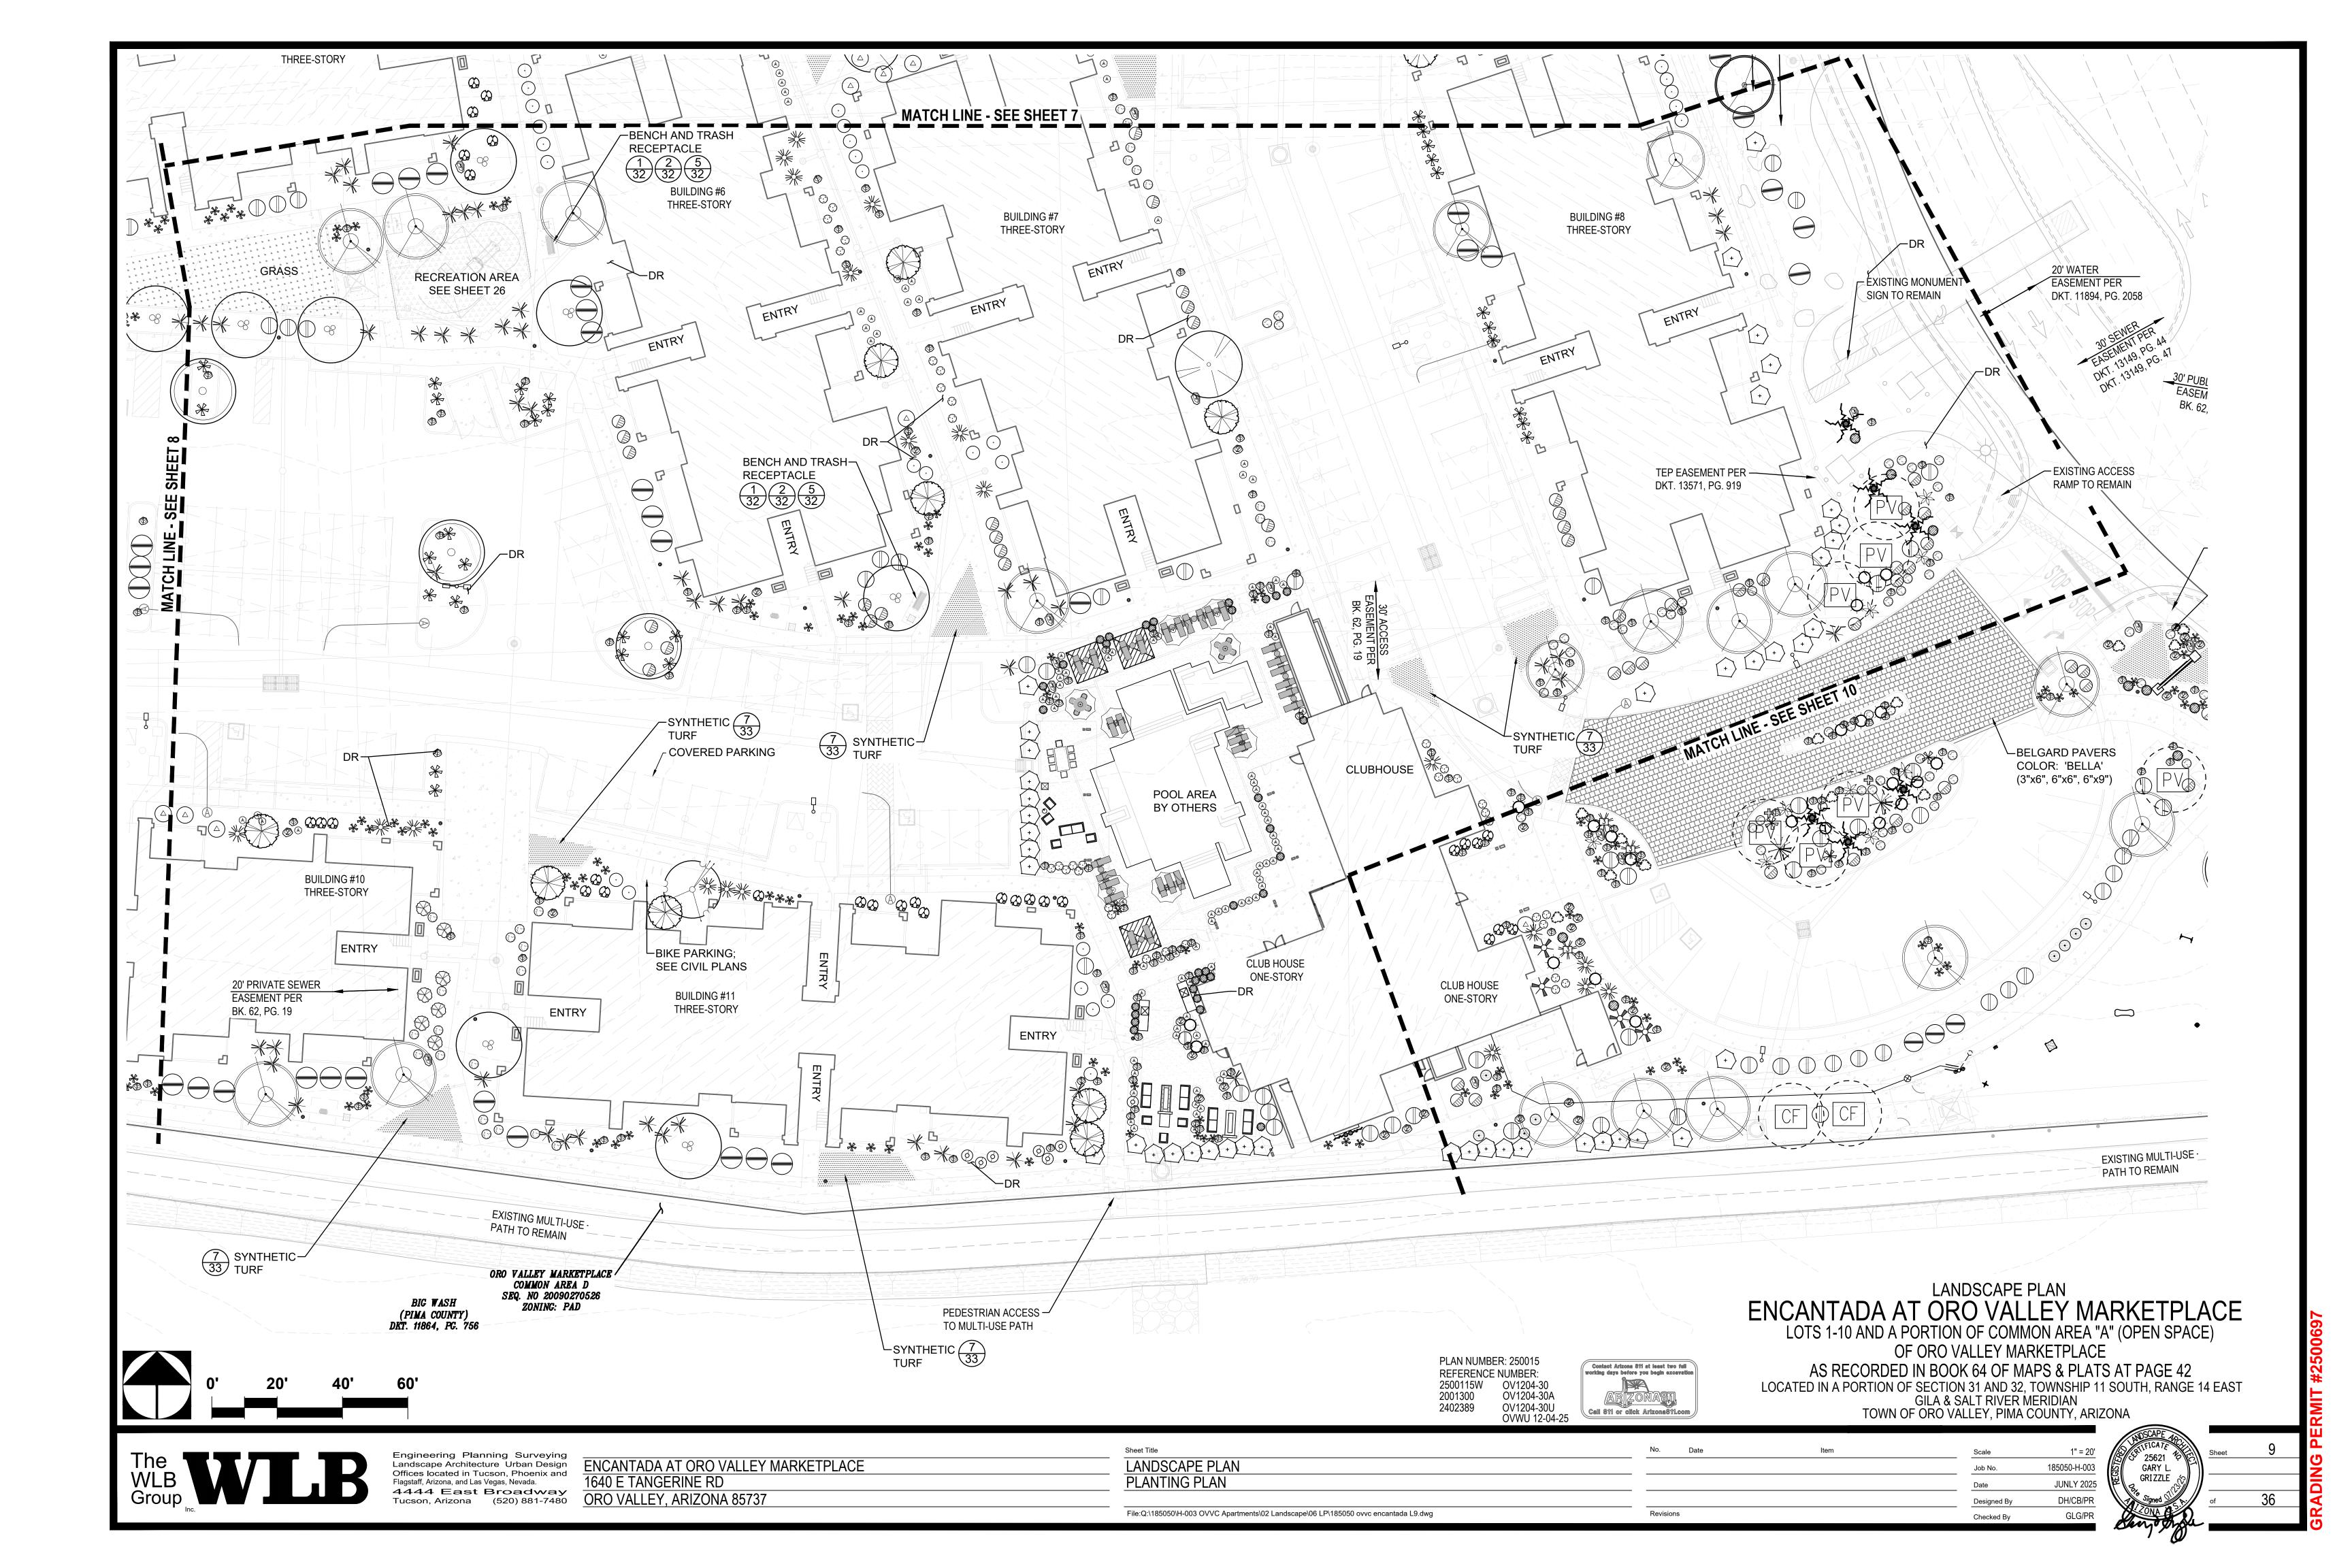

LOCATED IN A PORTION OF SECTION 31 AND 32, TOWNSHIP 11 SOUTH, RANGE 14 EAST GILA & SALT RIVER MERIDIAN TOWN OF ORO VALLEY, PIMA COUNTY, ARIZONA

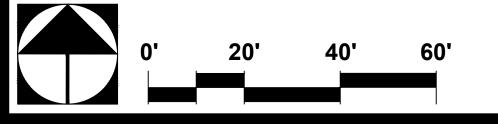

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ENCANTADA AT ORO VALLEY MARKETPLACE 1640 E TANGERINE RD ORO VALLEY, ARIZONA 85737

Sheet Title LANDSCAPE PLAN PLANTING PLAN File:Q:\185050\H-003 OVVC Apartments\02 Landscape\06 LP\185050 ovvc encantada L10.dwg

PLAN NUMBER: 250015

REFERENCE NUMBER:

2500115W 2001300 2402389


OV1204-30 OV1204-30A OV1204-30U OVWU 12-04-25





Contact Arizona 811 at least two full working days before you begin excavation

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1" = 20' 185050-H-003 JUNLY 2025 DH/CB/PR GLG/PR

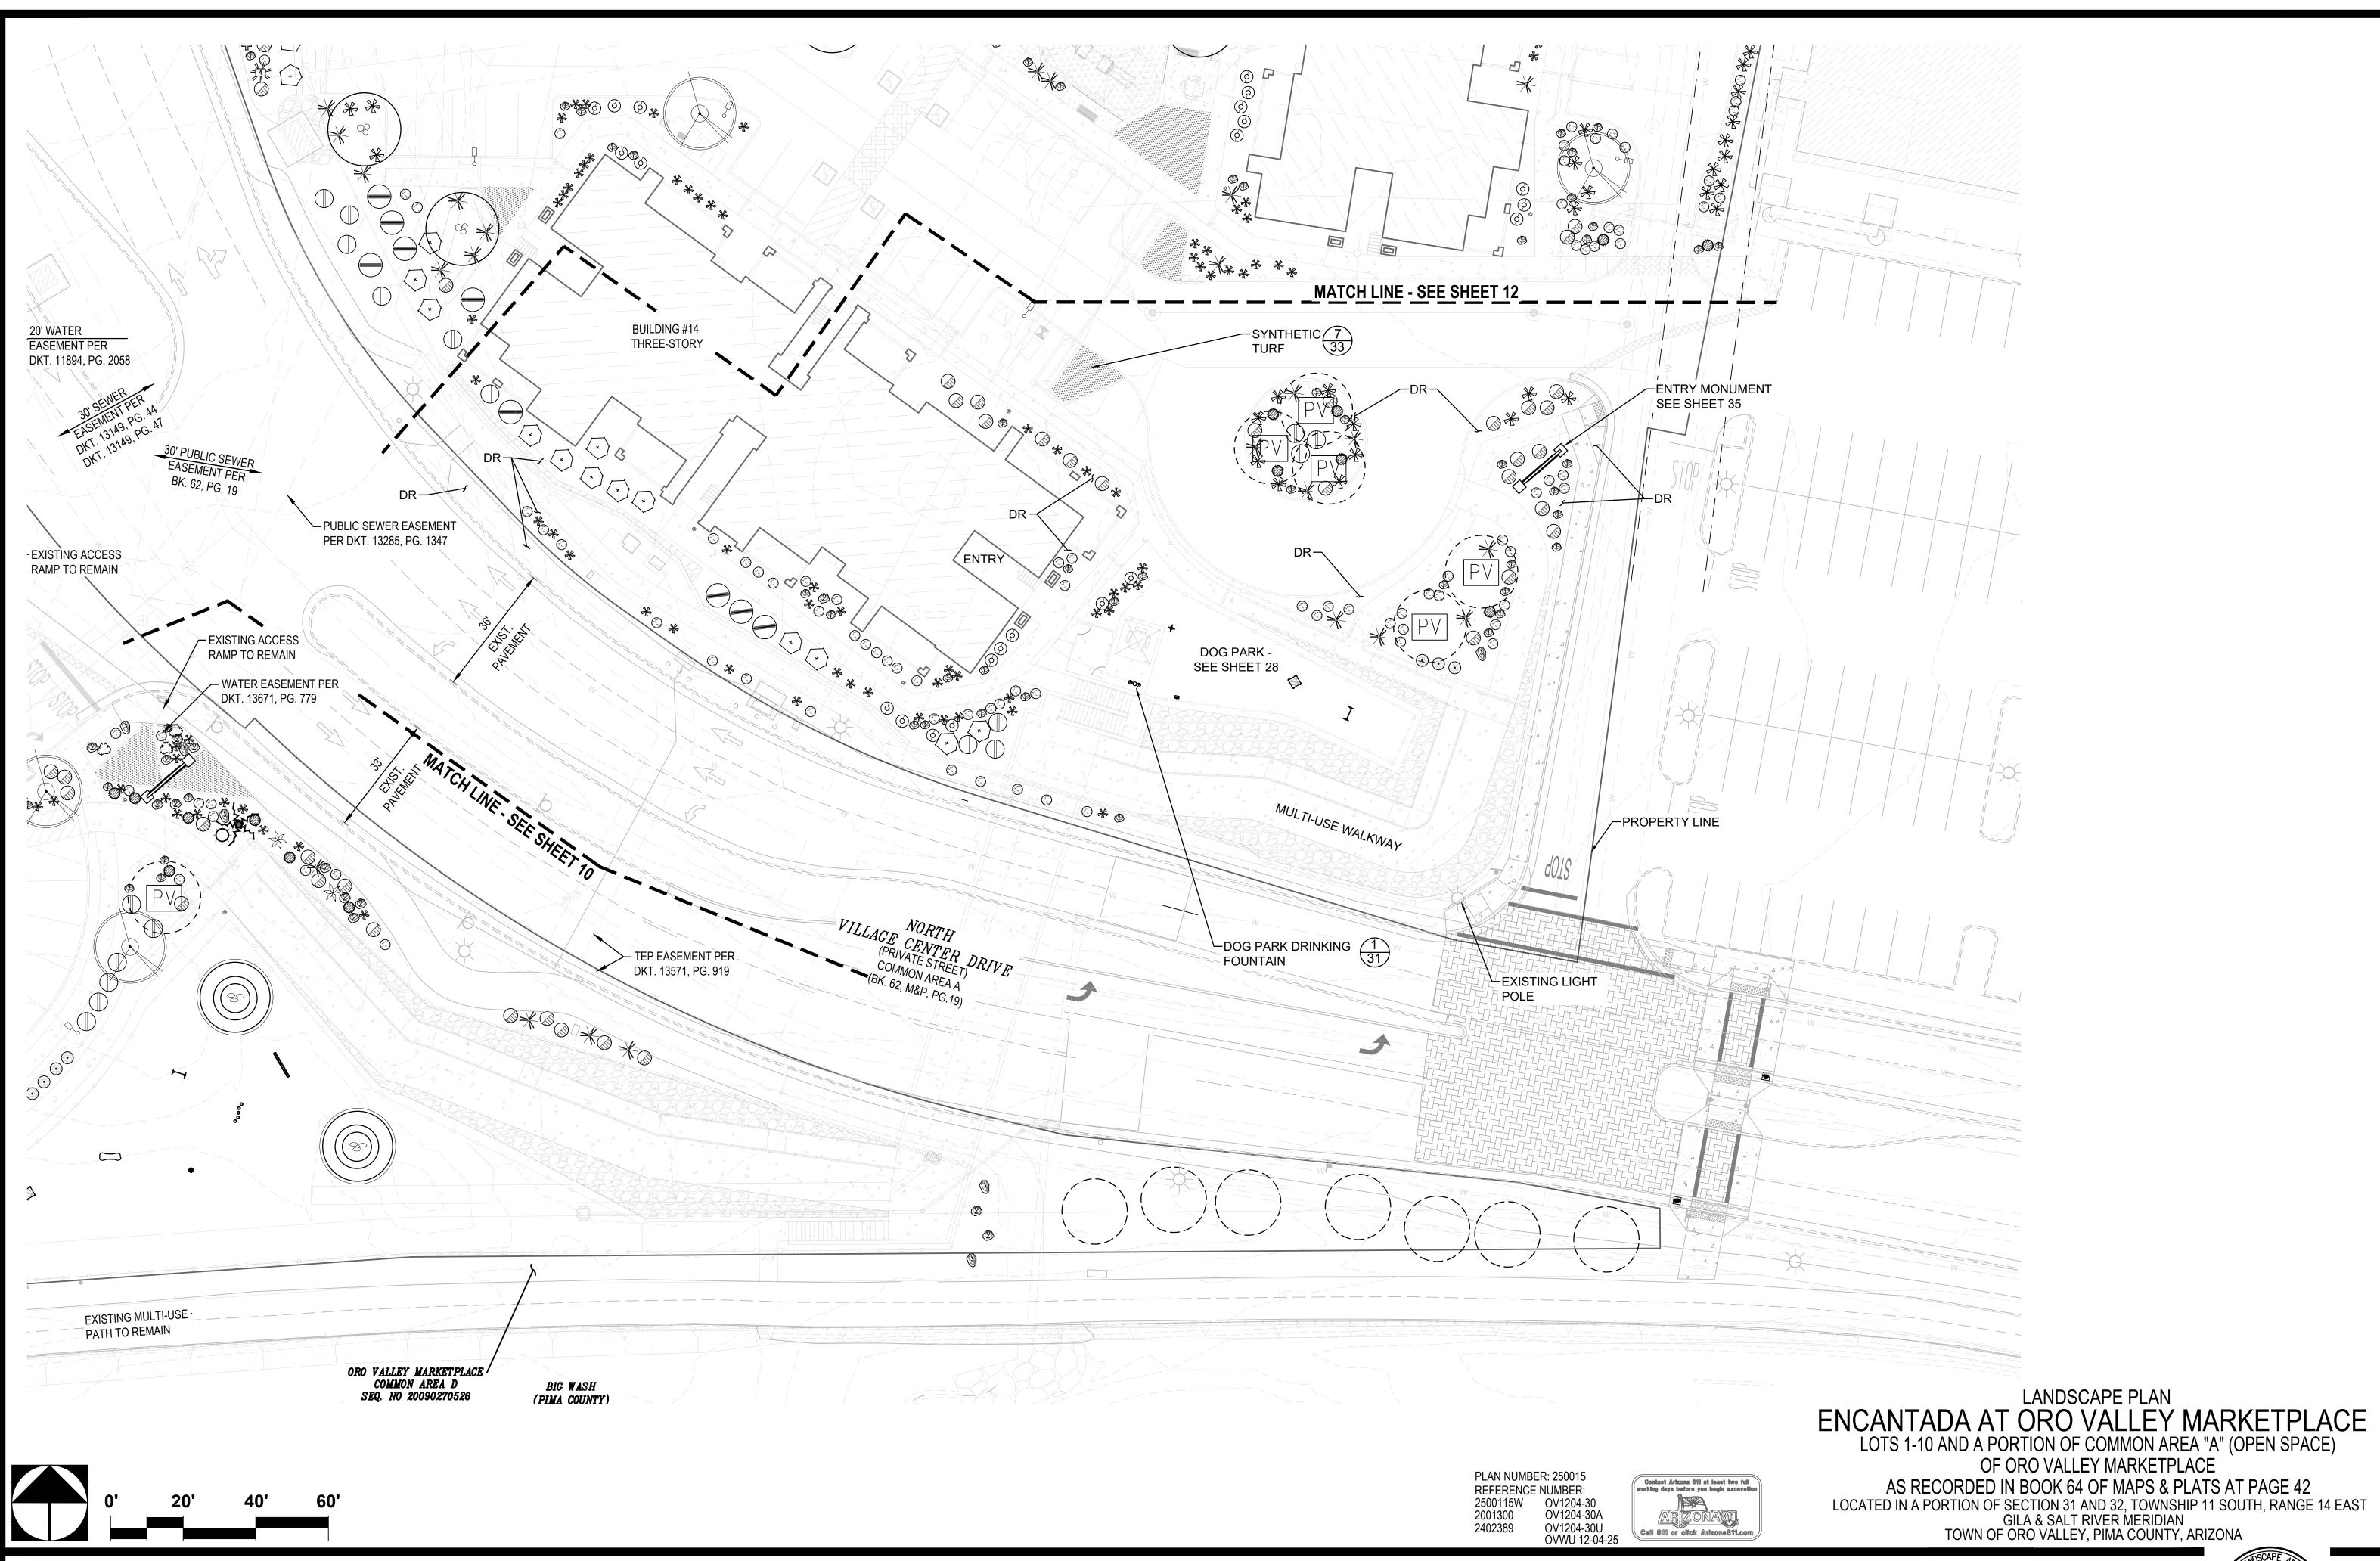Sheet 11

Sheet 11

Sheet 36

Sheet 36

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Ona 95

WIB


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ENCANTADA AT ORO VALLEY MARKETPLACE 1640 E TANGERINE RD ORO VALLEY, ARIZONA 85737 LANDSCAPE PLAN
PLANTING PLAN

File:Q:\185050\H-003 OVVC Apartments\02 Landscape\06 LP\185050 ovvc encantada L11.dwg

| Scale 1 | Job No. 185050-h
| Date JUNLY |
| Designed By DH/C



ORO VALLEY, ARIZONA 85737

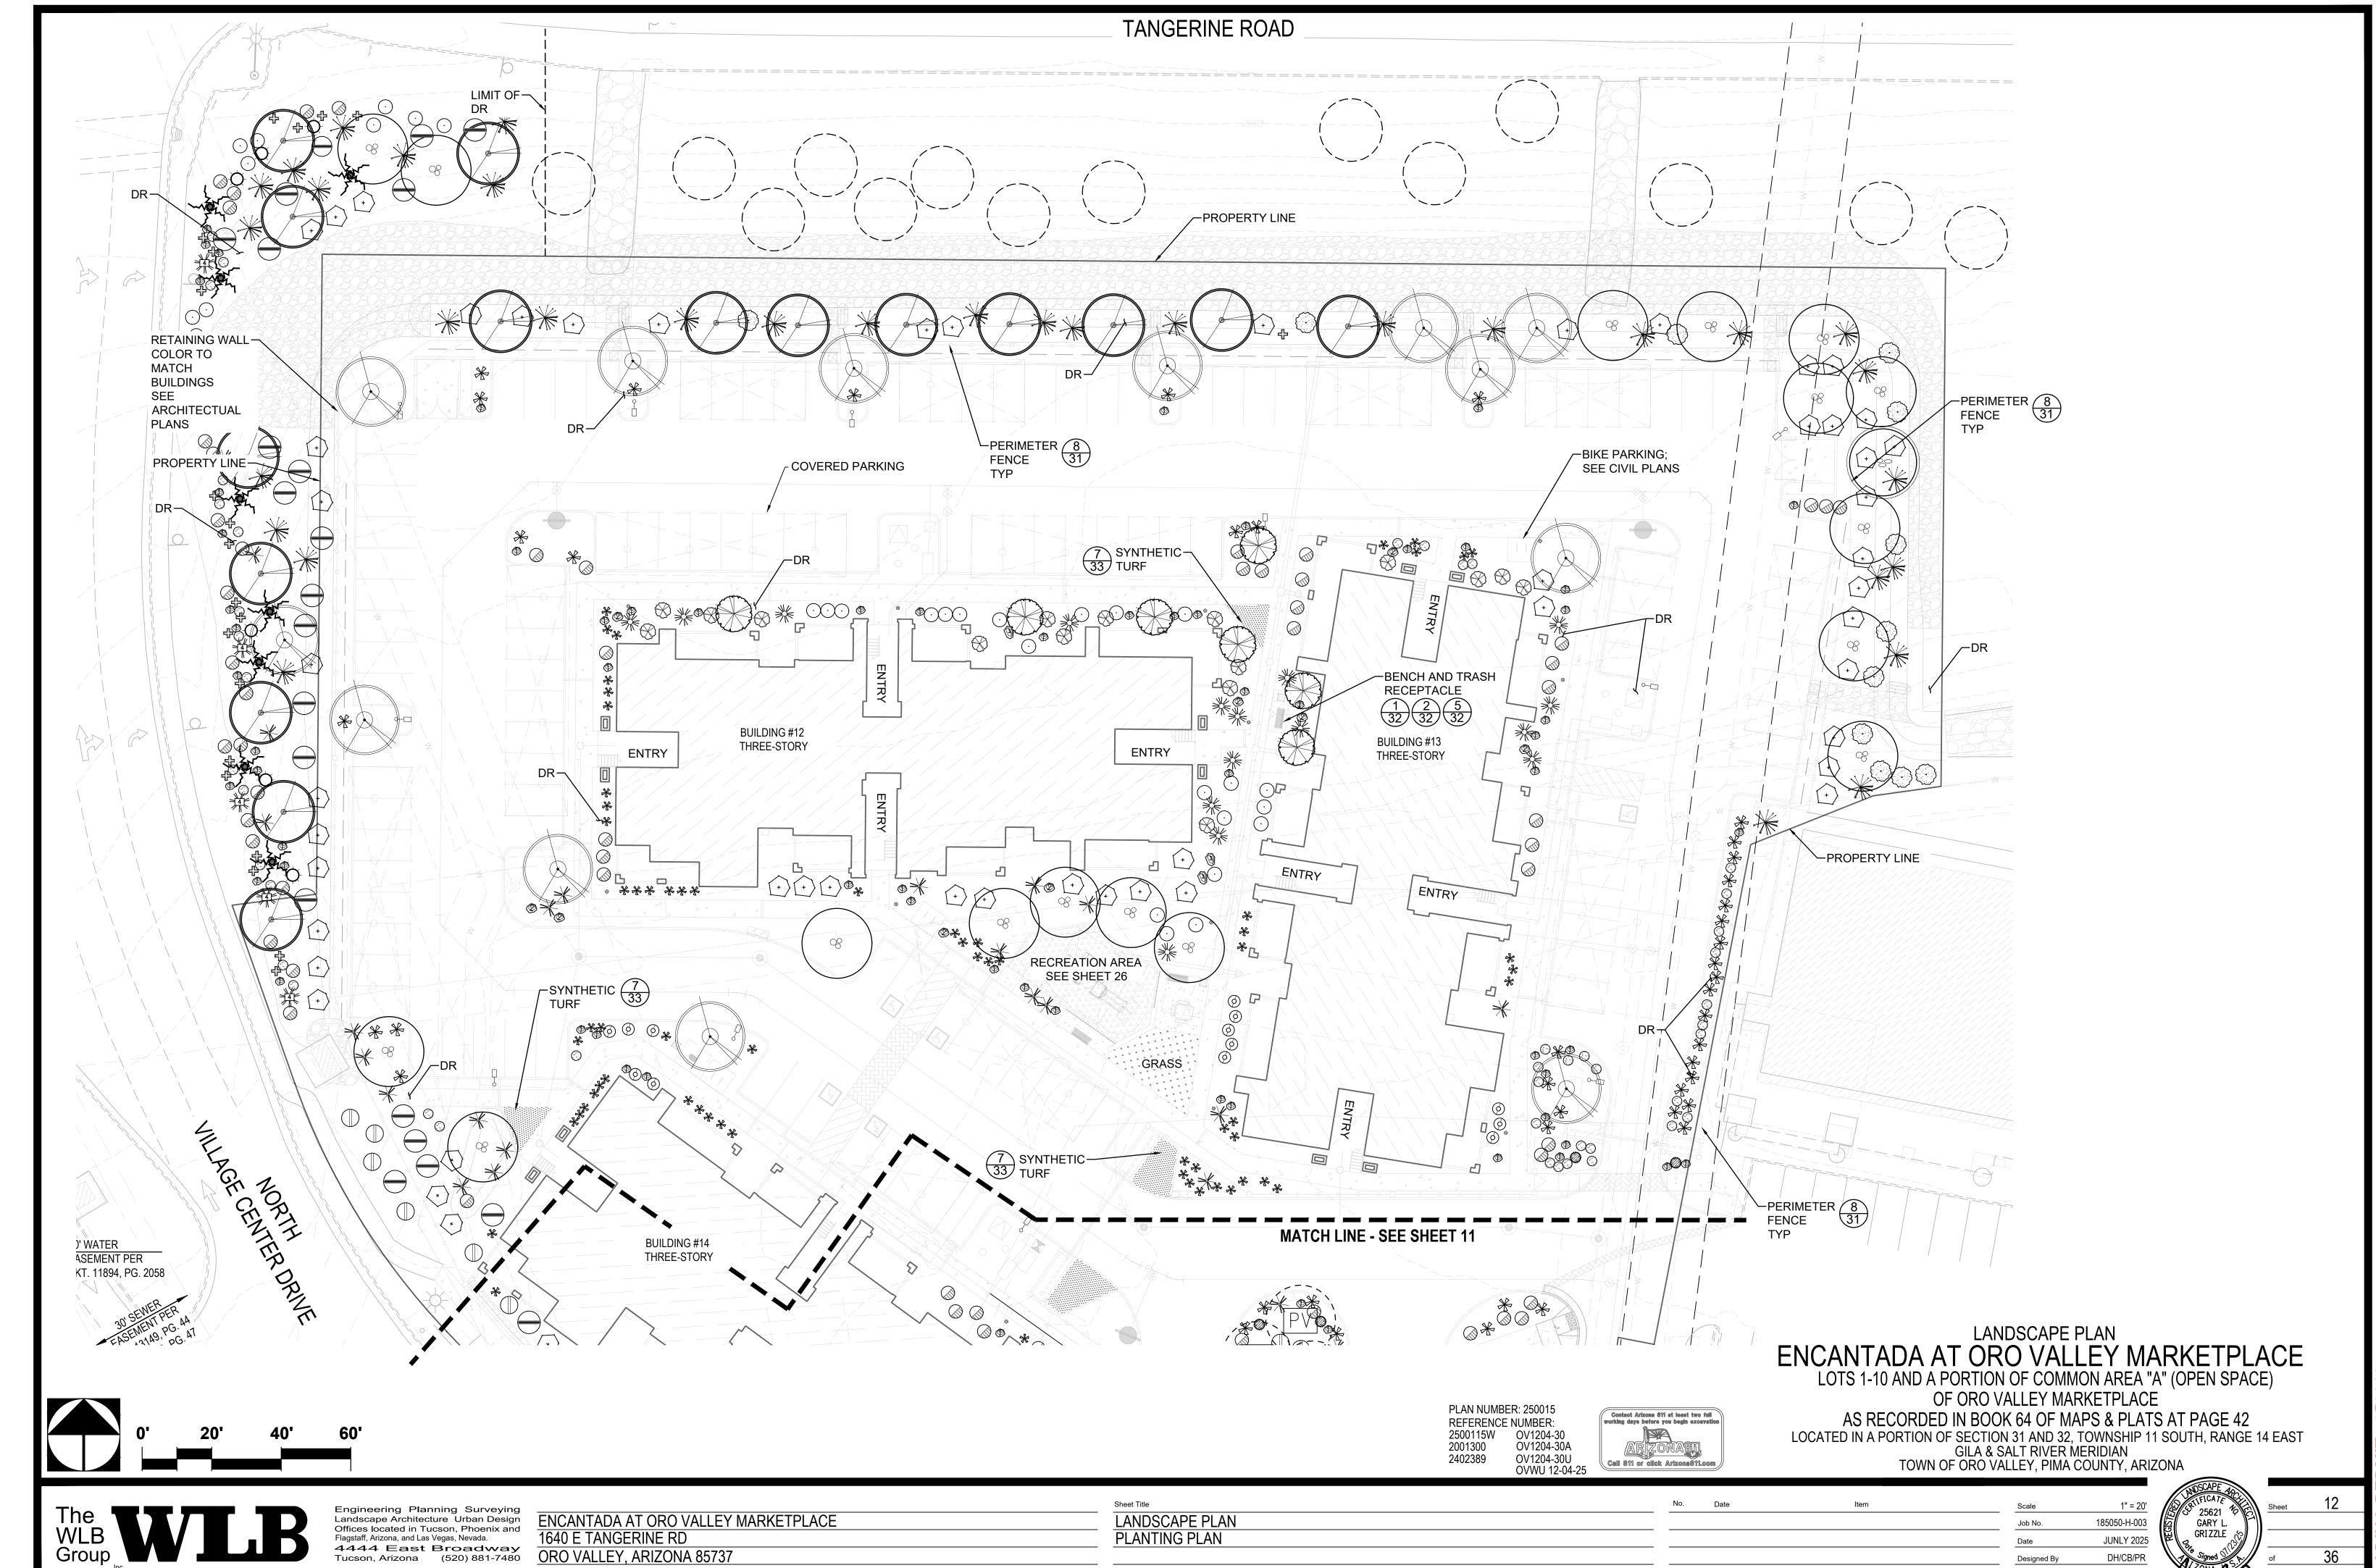
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Revisions









NOTE: 1. REMOVE ALL NURSERY STAKES AND CONTAINERS 2. WATER SETTLE BACKFILL IN 6" LIFTS

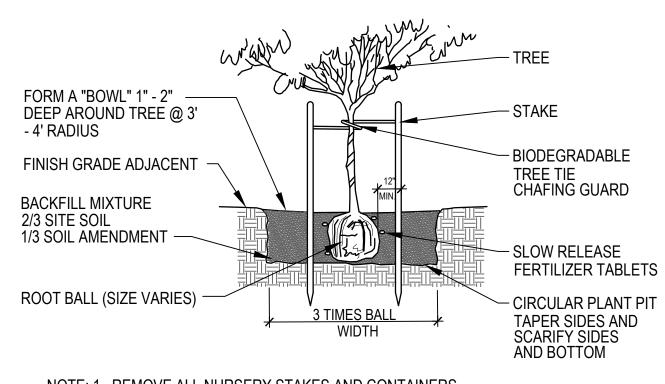

- FINISHED DEPTH: 2" MIN.
- BEFORE SPREADING, REMOVE ROCK & DEBRIS
- DURING INSTALLATION RAKE TO SETTLE FINES.
- LIGHTLY BROOM SURFACE AFTER INSTALLATION.
 APPLY PRE-EMERGENT TO ALL DECORATIVE ROCK AREAS.
- APPLY A LIGHT MIST OF WATER OVER THE ENTIRE DECORATIVE ROCK SURFACE.

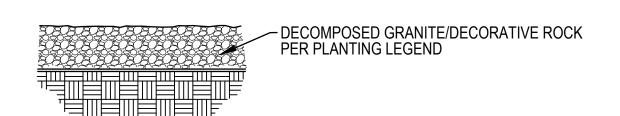




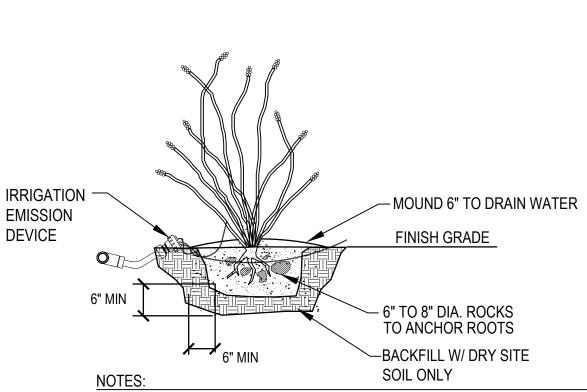


- ROOT PRUNE ALL SHREDDED OR DAMAGED ROOTS.
- ENSURE ALL WOUNDS TO THE ROOT SYSTEM ARE CLEAN CUT
- BEFORE PLANTING.
- APPLY DUSTING SULFUR TO ALL AREAS BELOW GRADE
- 4. BARE ROOTS SHALL NOT BE OUT OF THE GROUND FOR MORE THAN FIVE DAYS.
- 5. MIST WITH WATER FROM TOP DOWN EVERY OTHER WEEK IF PLANTED
- DURING HOT SEASON.
- 6. ADD IRRIGATION AS INDICATED (2 GPH EMITTER) TO ENSURE PROPER ROOT GROWTH AND HYDRATION.



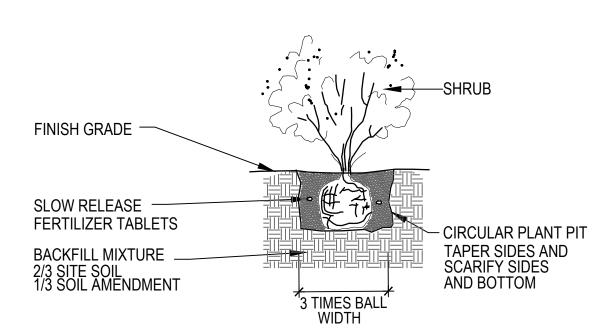


NOTE: 1. WATER SETTLE BACKFILL 6" LIFTS




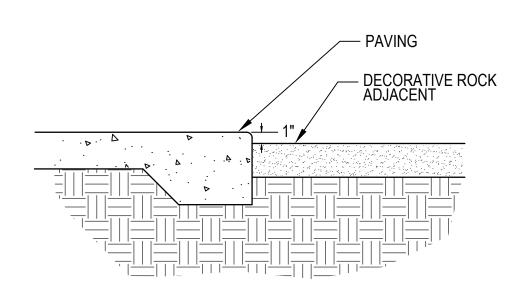




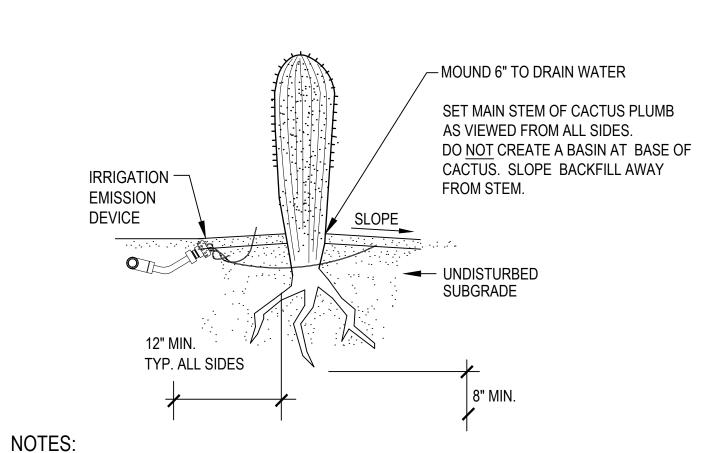


- 1. ROOT PRUNE ALL SHREDDED OR DAMAGED ROOTS. ENSURE ALL WOUNDS TO THE ROOT SYSTEM ARE CLEAN CUT PRIOR TO PLANTING. DUST ALL ROOTS WITH SULFUR.
- PLANT SAGUAROS AT LEAST 4' FROM SHRUBS OR TREE CANOPIES.
- PLANTING WELL SHALL BE 6" MIN. WIDER THAN THE EXTENT OF THE SEVERED LATERAL
- 4. PLANTING DEPTH SHALL BE THE SAME DEPTH AT WHICH THE PLANT WAS GROWN. THE TAPERING OF ROOT COLLAR MUST BE VISIBLE ABOVE THE FINISHED GRADE.
- BACKFILL WITH DRY SITE SOIL / 50% MORTAR SAND (NO STONES) TREATED WITH SOIL SULFUR. COMPACT SOIL IN 6" LIFTS TO ENSURE THE STABILITY OF THE PLANT.
- 6. ALL SAGUARO / BARREL CACTI PLACEMENTS SHALL MATCH ORIGINAL NORTH SIDE FACING NORTH. ANY SUNBURNED SAGUAROS / BARREL CACTI SHALL BE REPLACED BY THE LANDSCAPE CONTRACTOR.
- 7. SAGUAROS ARE SPECIFIED BY HEIGHT. A VARIETY OF HEIGHTS MAY BE ACCEPTABLE PROVIDED THE AVERAGE IS NOT LESS THAN SPECIFIED. OWNER OR OWNER'S REPRSENTATIVE MUST APPROVE SAGUARO SIZES PRIOR TO PLANTING.
- MIST WITH WATER FROM TOP DOWN TWICE A MONTH IF PLANTED DURING HOT SEASON.

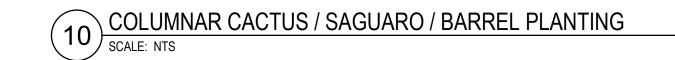

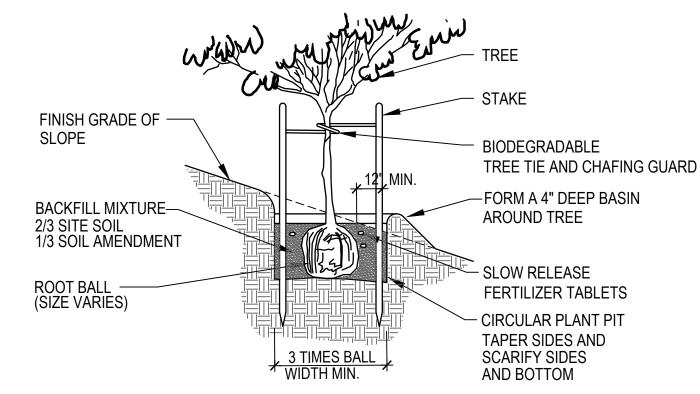


NOTE: 1. REMOVE ALL NURSERY STAKES AND CONTAINERS 2. WATER SETTLE BACKFILL 6" LIFTS



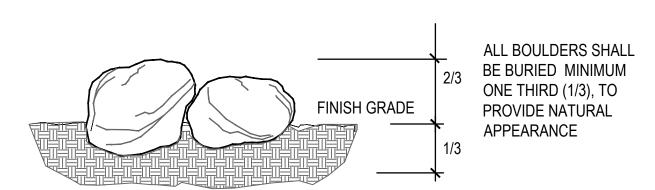


NOTE: BOULDERS ARE DIMENSIONED ON PLANS. SIZES CALLED OUT ARE MINIMUM DIMENSIONS.



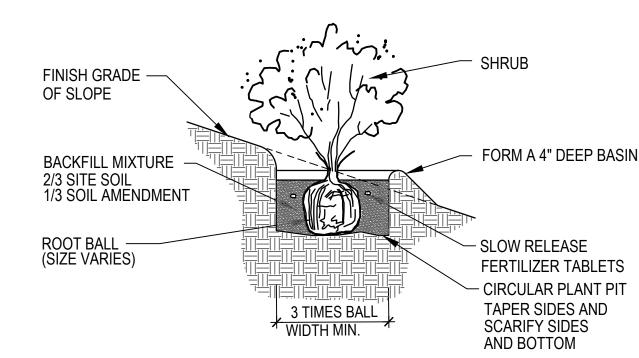

NOTE: 1. WATER SETTLE BACKFILL IN 6" LIFTS



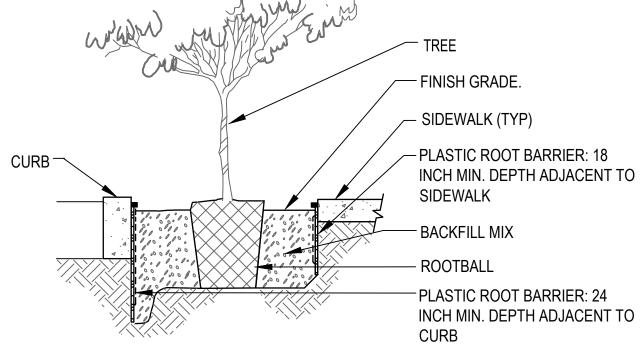

- 1. ROOT BARRIER SHALL BE INSTALLED IN A LINEAR RUN PARALLELTO EDGE OF HARDSCAPE (NOT ENCIRCLING ROOTBALL)-20' MIN. LENGTH EACH TREE
- 2. TOP OF ROOT CONTROL BARRIER SHALL BE ONE INCH ABOVE FINISH GRADE(MIN).
- BUT BELOW SIDEWALK GRADE. 3. ROOT BARRIER SHALL BE INSTALLED WITH RAISED ROOT DIVERTERS FACING TOWARD THE TREE ROOTBALL.



LANDSCAPE PLAN ENCANTADA AT ORO VALLEY MARKETPLACE LOTS 1-10 AND A PORTION OF COMMON AREA "A" (OPEN SPACE)

OF ORO VALLEY MARKETPLACE AS RECORDED IN BOOK 64 OF MAPS & PLATS AT PAGE 42 LOCATED IN A PORTION OF SECTION 31 AND 32, TOWNSHIP 11 SOUTH, RANGE 14 EAST

GILA & SALT RIVER MERIDIAN TOWN OF ORO VALLEY, PIMA COUNTY, ARIZONA



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ORO VALLEY, ARIZONA 85737

Sheet Title LANDSCAPE PLAN LANDSCAPE DETAILS

PLAN NUMBER: 250015

REFERENCE NUMBER:

2500115W

2001300

2402389

OV1204-30 OV1204-30A

OV1204-30U

OVWU 12-04-25

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No. Date

Revisions

185050-H-003 Job No. **JUNLY 2025** DH/CB/PR Designed By GLG/PR Checked By

25621 GRIZZLE

ENCANTADA AT ORO VALLEY MARKETPLACE 1640 E TANGERINE RD

File:Q:\185050\H-003 OVVC Apartments\02 Landscape\06 LP\185050 ovvc encantada L13 Dets.dwg

GENERAL NOTES

- 1. IRRIGATION AND/OR WATERING PLANS SHALL MEET THE MINIMUM STANDARDS OF THE AMERICAN SOCIETY OF IRRIGATION CONSULTANTS.
- 2. IF DESERT LANDSCAPING IS USED WHICH WILL ULTIMATELY RELY ON NATURAL WATER SOURCES, A TEMPORARY DRIP IRRIGATION SYSTEM SHALL BE EMPLOYED UNTIL SUCH TIME AS THE PLANT MATERIALS ARE SUSTAINED BY NATURAL WATER SOURCES.
- 3. THE PROPERTY OWNER IS RESPONSIBLE FOR MAINTAINING THE TEMPORARY SYSTEM AS LONG AS NECESSARY IN ORDER TO TRANSITION PLANTS OVER TO NATURAL SOURCES. ANY PLANT MATERIALS THAT DIE IN TRANSITION, FOR ANY REASON, SHALL BE REPLACED (SECTION 27.6.E.4).
- 4. IRRIGATION SYSTEMS CONNECTED TO POTABLE WATER MAINS (PUBLIC OR PRIVATE) SHALL BE EQUIPPED WITH BACKFLOW PREVENTERS.
- 5. THE ANNUAL WATER USE FOR A PROJECT SHALL NOT EXCEED THE ANNUAL LANDSCAPE WATER PLAN
- 6. IRRIGATION METER READINGS SHALL BE USED TO DETERMINE COMPLIANCE WITH THE LANDSCAPE WATER PLAN. NON-COMPLIANCE IS SUBJECT TO PENALTIES UNDER THE ZONING CODE.
- 7. METER READINGS SHALL BE TAKEN, AT A MINIMUM, ON AN ANNUAL BASIS. MONTHLY READINGS MAY BE REQUIRED, AT THE DISCRETION OF THE PLANNING AND ZONING ADMINISTRATOR, IN ORDER TO ADDRESS NON-COMPLIANCE WITH THE WATER PLAN.
- 8. AN INITIAL METER READING SHALL BE TAKEN PRIOR TO THE ISSUANCE OF THE CERTIFICATE OF OCCUPANCY AND RECORDED FOR REFERENCE AS PART OF THE WATER PLAN.
- 9. IRRIGATION WATER SHALL NOT LEAVE THE LANDSCAPED AREAS AND FLOW ONTO ROADS, PARKING AREAS OR SIDEWALKS.

IRRIGATION NOTES

- 1. ALL WATER USE FOR IRRIGATION AND ENHANCEMENT SHALL CONFORM TO THE ARIZONA GROUNDWATER CODE, ARIZONA REVISED STATUTES 45, CHAPTER 2.
- 2. IRRIGATION PLAN IS SCHEMATIC AND DRAWN FOR GRAPHIC CLARITY. INSTALL EQUIPMENT WITHIN PLANTING AREAS AND ADJACENT TO WALKWAYS WHEREVER POSSIBLE.
- 3. IRRIGATION SYSTEM IS DESIGNED FOR A MINIMUM PRESSURE OF 50 PSI. PRIOR TO START OF IRRIGATION WORK, CONTRACTOR SHALL VERIFY EXISTING WATER PRESSURE AT THE METER (ASSUMED TO BE 50 PSI) AND NOTIFY OWNER'S REPRESENTATIVE OF ANY DISCREPANCY BETWEEN EXISTING PRESSURE AND DESIGN PRESSURE BEFORE PROCEEDING WITH WORK. NOTIFY LANDSCAPE ARCHITECT IF PRESSURE EXCEEDS 120 PSI
- 4. COORDINATE WITH OTHER WORK AS REQUIRED TO PROVIDE POWER TO IRRIGATION CONTROLLERS.
- MAKE IRRIGATION POINTS OF CONNECTION TO WATER LINES AS INDICATED ON PLANS AND COORDINATE WITH OTHER WORK AS REQUIRED.
 EXACT LOCATION OF CONTROLLERS TO BE APPROVED PRIOR TO INSTALLATION.
- 6. CONTRACTOR RESPONSIBLE FOR ALL SLEEVES. WHETHER INDICATED ON THESE PLANS OR NOT INSTALL ALL PIPE AND WIRE UNDER PAVING OR WALLS IN SLEEVE, SIZE AS REQUIRED. COORDINATE WITH OTHER WORK AS REQUIRED.
- 7. INSTALL 3/4" EMITTER TUBING WITH DRIP EMITTERS AS REQUIRED, TO PROVIDE IRRIGATION TO ALL NEW SHRUBS AND TREES PER PLANTING PLAN
- 8. LAY OUT EMITTER TUBING PARALLEL TO TOPOGRAPHY WHEREVER POSSIBLE. INSTALL AUTOMATIC FLUSH TYPE END CAP AT ENDS OF ALL 3/4" LINES AND FLUSH THOROUGHLY BEFORE INSTALLING EMITTERS. BURY TUBING AT AN 8" DEPTH.
- FOR SHRUBS AND VINES: INSTALL SINGLE OUTLET EMITTERS AS FOLLOWS:
 (2) 1-GPH EMITTERS AT EACH 5 GALLON PLANT
 (1) 1-GPH EMITTERS AT EACH 1 GALLON PLANT
 (1) 0.5-GPH EMITTERS AT EACH SUCCULENT. MULTI-OUTLET EMITTERS MAY BE SUBSTITUTED FOR INDIVIDUAL EMITTERS.
- 10. FOR TREES: INSTALL MULTI-OUTLET EMITTER AS FOLLOWS:
 (8) 2-GPH EMITTERS AT EACH 48" BOX /TRANSPLANTED TREE
 (6) 2-GPH EMITTERS AT EACH 24" BOX /36" BOX
 (4) 2-GPH EMITTERS AT EACH 15 GALLON
- 11. SINGLE OUTLET EMITTER RAIN BIRD XB-10PC, OR EQUAL MULTI-OUTLET EMITTER RAIN BIRD XBT-10-6, OR EQUAL. MULTI-OUTLET EMITTERS MAY BE SUBSTITUTED FOR INDIVIDUAL EMITTERS.
- 12. USE SHORT PIECES OF 1/4" DISTRIBUTION TUBING (MAXIMUM LENGTH 6') TO EXTEND EMITTERS TO EACH ROOTBALL. HOLD IN PLACE WITH STAKES.
- 13. REVIEW EMITTER LAYOUT WITH LANDSCAPE ARCHITECT AND ADJUST NUMBER OF EMITTERS FOR SPECIFIC PLANTS THAT REQUIRE GREATER OR LESSER VOLUME OF WATER THAN INDICATED.
- 14. IRRIGATION CONTRACTOR SHALL SUBMIT AN IRRIGATION SCHEDULE FOR REVIEW.
- 15. ALL BURIED IRRIGATION PIPE GREATER THAN TWO INCHES IN DIAMETER SHALL HAVE A #18 UF TYPE TRACER WIRE ATTACHED SECURELY TO IT AT 8 FT. INTERVALS. AT THE TERMINATION POINT ATTACH WIRE SECURELY TO PIPE AND PROVIDE TWELVE INCHES OF TRACER WIRE ACCESSIBLE ABOVE GRADE.

IRRIGATION LEGEND

| SYMBOL | DESCRIPTION | MANUFACTURER/MODEL | COMMENTS |
|-----------|--|--|--|
| M | WATER METER | PER LOCAL CODE | SERVICE LINE SIZE - SEE WATER PLANS |
| С | IRRIGATION CONTROLLER | RAIN BIRD ESP-2-WIRE CONTROLLER 50-STATION WITH LNK WIFI MODULE & FLOW SENSING | WALL-MOUNT IN RAIN BIRD LXMM STEEL CABINET PER MANUFACTURER'S RECOMMENDATIONS. COORDINATE ELECTRICAL SUPPLY |
| NOT SHOWN | DECODER | RAIN BIRD TW-1 | INSTALL PER MANUFACTURER'S RECOMMENDATIONS |
| | BACKFLOW PREVENTER IN ENCLOSURE | FEBCO 825Y-A, SIZE AS INDICATED | GUARDSHACK ENCLOSURE, COLOR: WOODLAND TAN. INSTALL ON 4" THICK CONCRETE SLAB PER MANUFACTURERS RECOMMENDATIONS. PROVIDE R30 INSULATION BLANKET |
| | MASTER VALVE | RAIN BIRD BPE-NP-HAN | LINE SIZE BOX SIZE: AMETEK "STANDARD", OR EQUAL. |
| 0 | FLOW SENSOR | RAIN BIRD ULTRASONIC | BOX SIZE: AMETEK "STANDARD", OR EQUAL. |
| H | GATE VALVE | NIBCO T-113K BRASS GATE VALVE | LINE SIZE, IN VALVE BOX* BOX SIZE: AMETEK 10" ROUND, OR EQUAL. |
| • | QUICK COUPLER | RAIN BIRD 33DRC | IN VALVE BOX. BOX SIZE: AMETEK 10" ROUND, OR EQUAL. PROVIDE (3) KEYS. |
| • | REMOTE CONTROL VALVE ASSY. (TREE/SHRUB) | CONTROL ZONE KIT: RAIN BIRD XCZ-100-PRB-COM | SIZE PER PLAN IN VALVE BOX * BOX SIZE: AMETEK "JUMBO", OR EQUAL. ONE VALVE PER BOX |
| Θ | REMOTE CONTROL VALVE ASSY. (TURF) | CONTROL VALVE: RAIN BIRD PESB SERIES BALL VALVE: KBI PVC BALL VALVE | SIZE PER PLAN IN VALVE BOX * AMETEK "STANDARD". |
| • • • | POP-UP SPRAY HEAD (ADJUSTABLE RADIUS) | HUNTER, I-20-06-SS | ADJUST/CHANGE NOZZLES AS NEEDED TO ACHIEVE COMPLETE COVERAGE AND MINIMIZE OVERSPRAY ONTO WALKS, WALLS, AND ROADWAYS. |
| NOT SHOWN | MULTI-OUTLET EMITTER (TREES) | RAIN BIRD XB-10-6 MULTI-OUTLET XERI-BUG | NOT SHOWN ON PLAN. PROVIDE (1) TO EACH TREE. BOX SIZE: AMETEK 6" ROUND, OR EQUAL. |
| NOT SHOWN | SINGLE EMITTER (SHRUBS) | RAIN BIRD XB-10PC (1 GPH) | NOT SHOWN ON PLAN. PROVIDE (2) TO EACH SHRUB. |
| | MAIN LINE | SCH. 40 PVC PIPE | SIZE 2-1/2" UNLESS NOTED OTHERWISE. SCH. 40 FITTINGS SOLVENT WELD. |
| Т | LATERAL LINE (PVC) (TREES) | CLASS 200 PVC PIPE | REFER TO PIPE SIZE CHART-THIS SHEET-FOR LATERAL LINE SIZE. SOLVENT WELD. SCH. 40 FITTINGS |
| Т | LATERAL LINE (PVC) (TRANSPLANTS) | CLASS 200 PVC PIPE | REFER TO PIPE SIZE CHART-THIS SHEET-FOR LATERAL LINE SIZE. SOLVENT WELD. SCH. 40 FITTINGS |
| S | LATERAL LINE (PVC) (SHRUBS) | CLASS 200 PVC PIPE | REFER TO PIPE SIZE CHART-THIS SHEET-FOR LATERAL LINE SIZE. SOLVENT WELD. SCH. 40 FITTINGS |
| | LATERAL LINE (PVC) (TURF-SEE SHEET 18) | CLASS 200 PVC PIPE | REFER TO PIPE SIZE CHART-THIS SHEET-FOR LATERAL LINE SIZE. SOLVENT WELD. SCH. 40 FITTINGS |
| | SLEEVE | SCH. 40 PVC PIPE | SIZE TO BE 2X DIAMETER OF PIPE BEING SLEEVED (MIN. 4") |
| п | FLUSH END CAP | SEE DETAIL | LOCATE AT END OF EVERY LATERAL RUN IN VALVE BOX, 6" ROUND SIZE * |

* VALVE BOXES TO BE COLOR TAN. DO NOT PLACE VALVE BOXES IN SYNTHETIC TURF OR GRASS AREAS

TREES

IRRIGATION CONTROLLER SCHEDULE

| YEAR | DAYS | FREQUENCY | TIME (HRS.) | TOTAL WATER |
|------|----------------|---|-----------------------------------|---|
| 3 | MON. WED. FRI. | 1 | 2.75 | 1,760, 442 |
| 4 | MON. THUR. | 1 | 3 | 1,320,332 |
| 5 | WED. | 1 | 4 | 880,221 |
| | 3 4 | 3 MON. WED. FRI.4 MON. THUR. | 3 MON. WED. FRI. 1 4 MON. THUR. 1 | 3 MON. WED. FRI. 1 2.75 4 MON. THUR. 1 3 |

IRRIGATION CONTROLLER NOTES

PLANT WATERING REQUIREMENTS VARY ACCORDING TO SIZE OF PLANT, AGE, EXPOSURE, SOIL, LOCATION, WEATHER, AND OTHER FACTORS. ADJUST CONTROLLER AS NEEDED.

ADJUST CONTROLLER AND INSPECT THE TIME CLOCK AT LEAST ONCE A MONTH TO MAKE SURE IT IS OPERATING PROPERLY. LESS IRRIGATION IS GENERALLY REQUIRED IN DECEMBER, JANUARY, AND FEBRUARY.

PLAN NUMBER: 250015

REFERENCE NUMBER:
2500115W OV1204-30
2001300 OV1204-30A
2402389 OV1204-30U
OVWU 12-04-25



WATERING DEPTH OF 24 - 36 INCHES

SHRUBS / GROUNDCOVER

WATERING DEPTH OF 18 - 24 INCHES

VALVE KEY

STATION NUMBER

VALVE SIZE

1"

2.0

FLOW (GPM)

LANDSCAPE PLAN
ENCANTADA AT ORO VALLEY MARKETPLACE

OF ORO VALLEY MARKETPLACE
AS RECORDED IN BOOK 64 OF MAPS & PLATS AT PAGE 42
LOCATED IN A PORTION OF SECTION 31 AND 32, TOWNSHIP 11 SOUTH, RANGE 14 EAST

LOTS 1-10 AND A PORTION OF COMMON AREA "A" (OPEN SPACE)

IN A PORTION OF SECTION 31 AND 32, TOWNSHIP 11 SOUTH, RANGE 14 EAST GILA & SALT RIVER MERIDIAN TOWN OF ORO VALLEY, PIMA COUNTY, ARIZONA

PLANTING TYPE



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444 East Broadway
Tucson, Arizona (520) 881-7480

ENCANTADA AT ORO VALLEY MARKETPLACE
1640 E TANGERINE RD
ORO VALLEY, ARIZONA 85737


Sheet Title

LANDSCAPE PLAN


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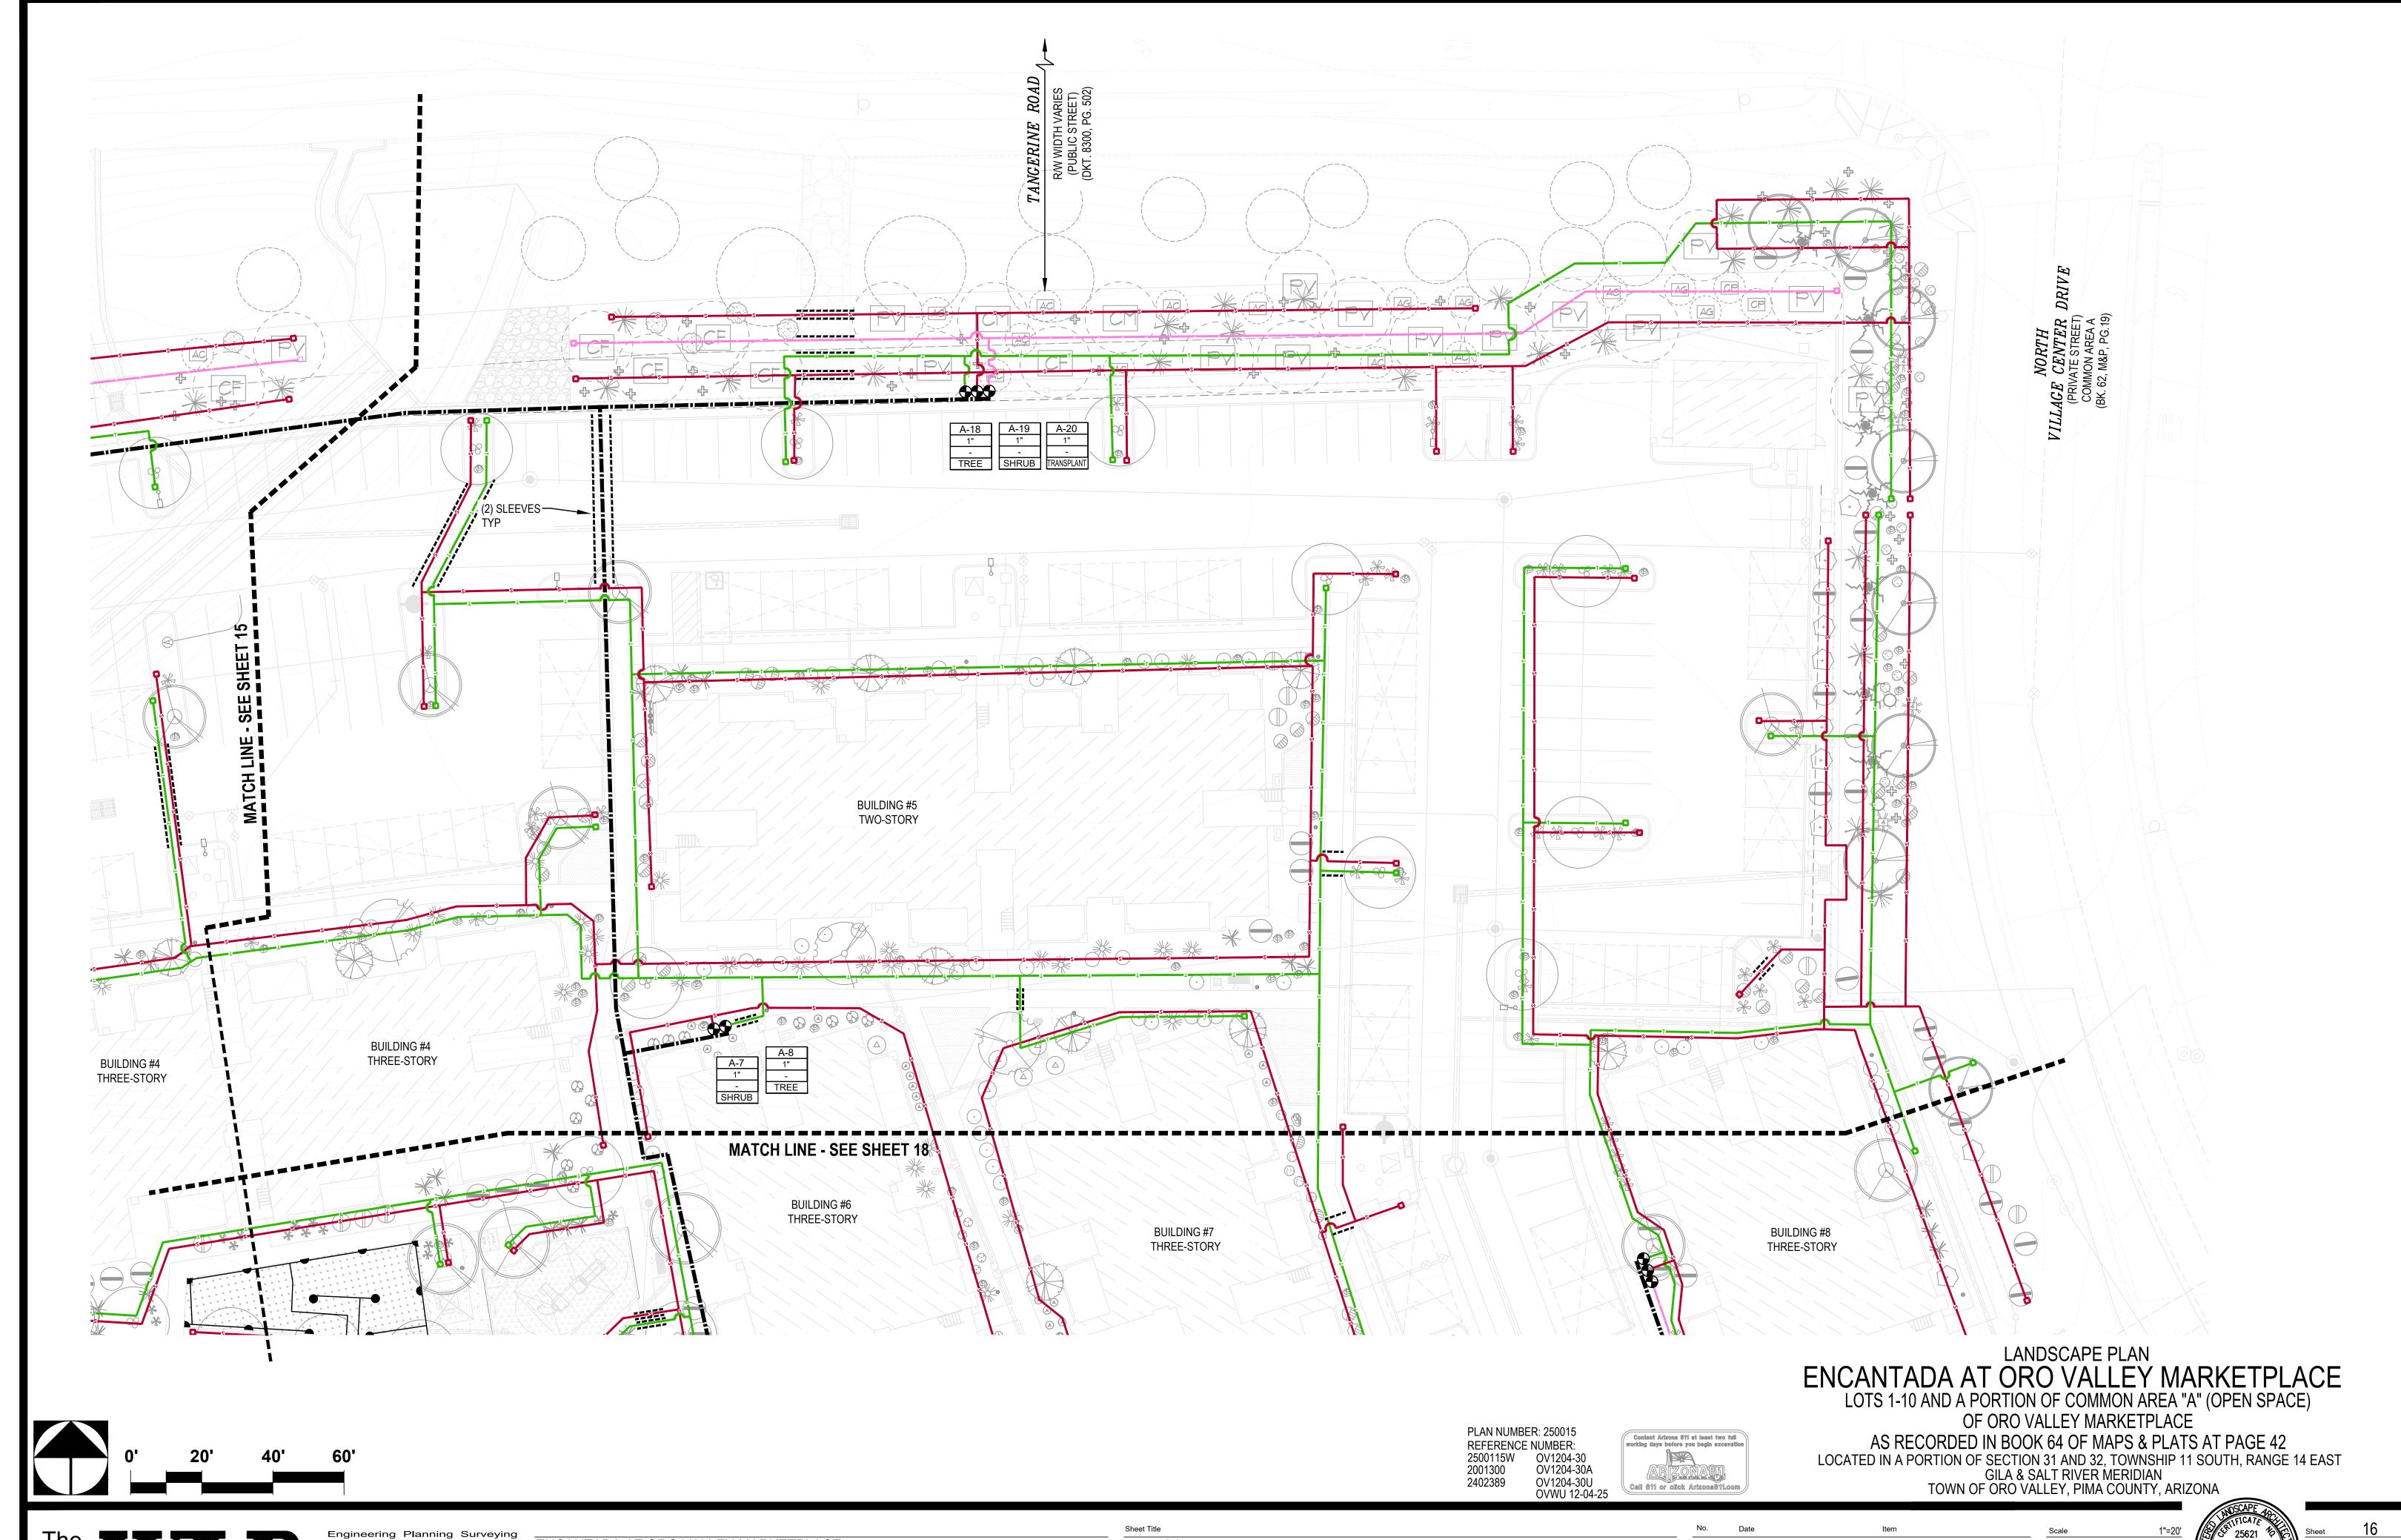
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Revisions





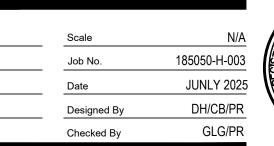

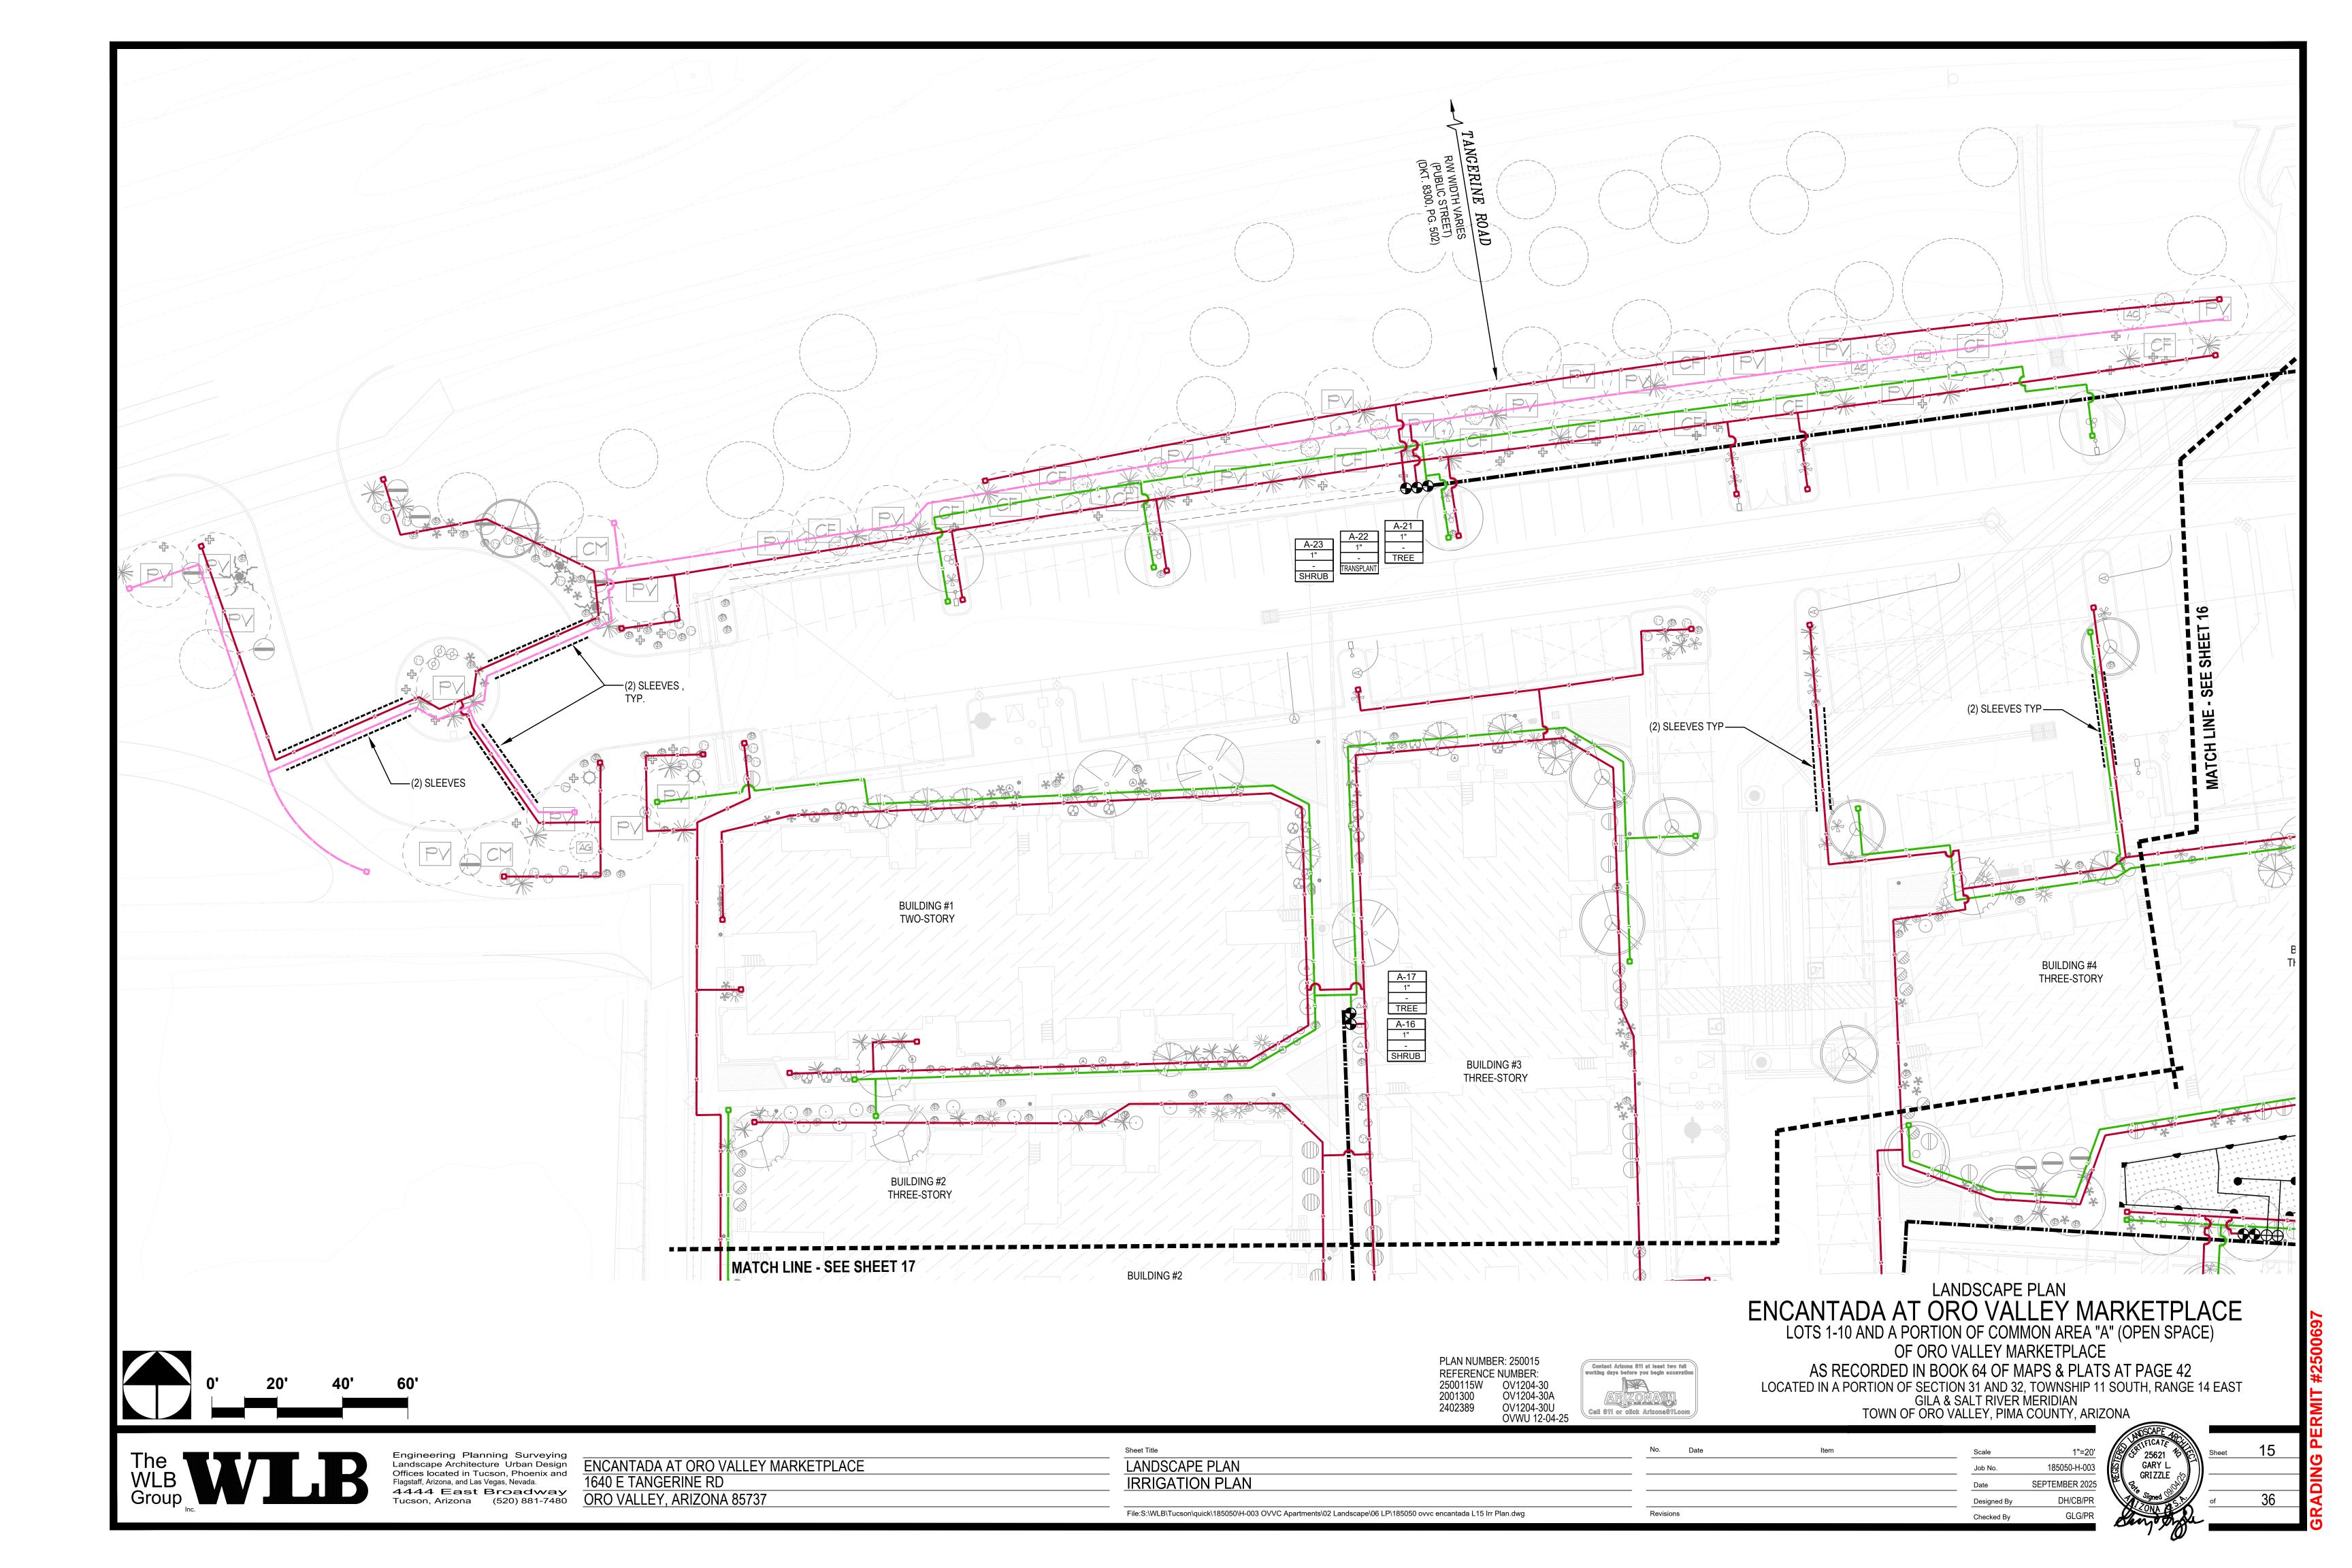

LANDSCAPE PLAN
IRRIGATION PLAN

185050-H-003 SEPTEMBER 2025 DH/CB/PR GLG/PR Checked By




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ENCANTADA AT ORO VALLEY MARKETPLACE 1640 E TANGERINE RD ORO VALLEY, ARIZONA 85737

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LOCATED IN A PORTION OF SECTION 31 AND 32, TOWNSHIP 11 SOUTH, RANGE 14 EAST GILA & SALT RIVER MERIDIAN TOWN OF ORO VALLEY, PIMA COUNTY, ARIZONA

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ENCANTADA AT ORO VALLEY MARKETPLACE 1640 E TANGERINE RD ORO VALLEY, ARIZONA 85737

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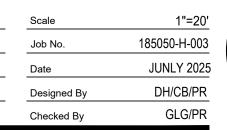
Contact Arizona 811 at least two full working days before you begin excavation
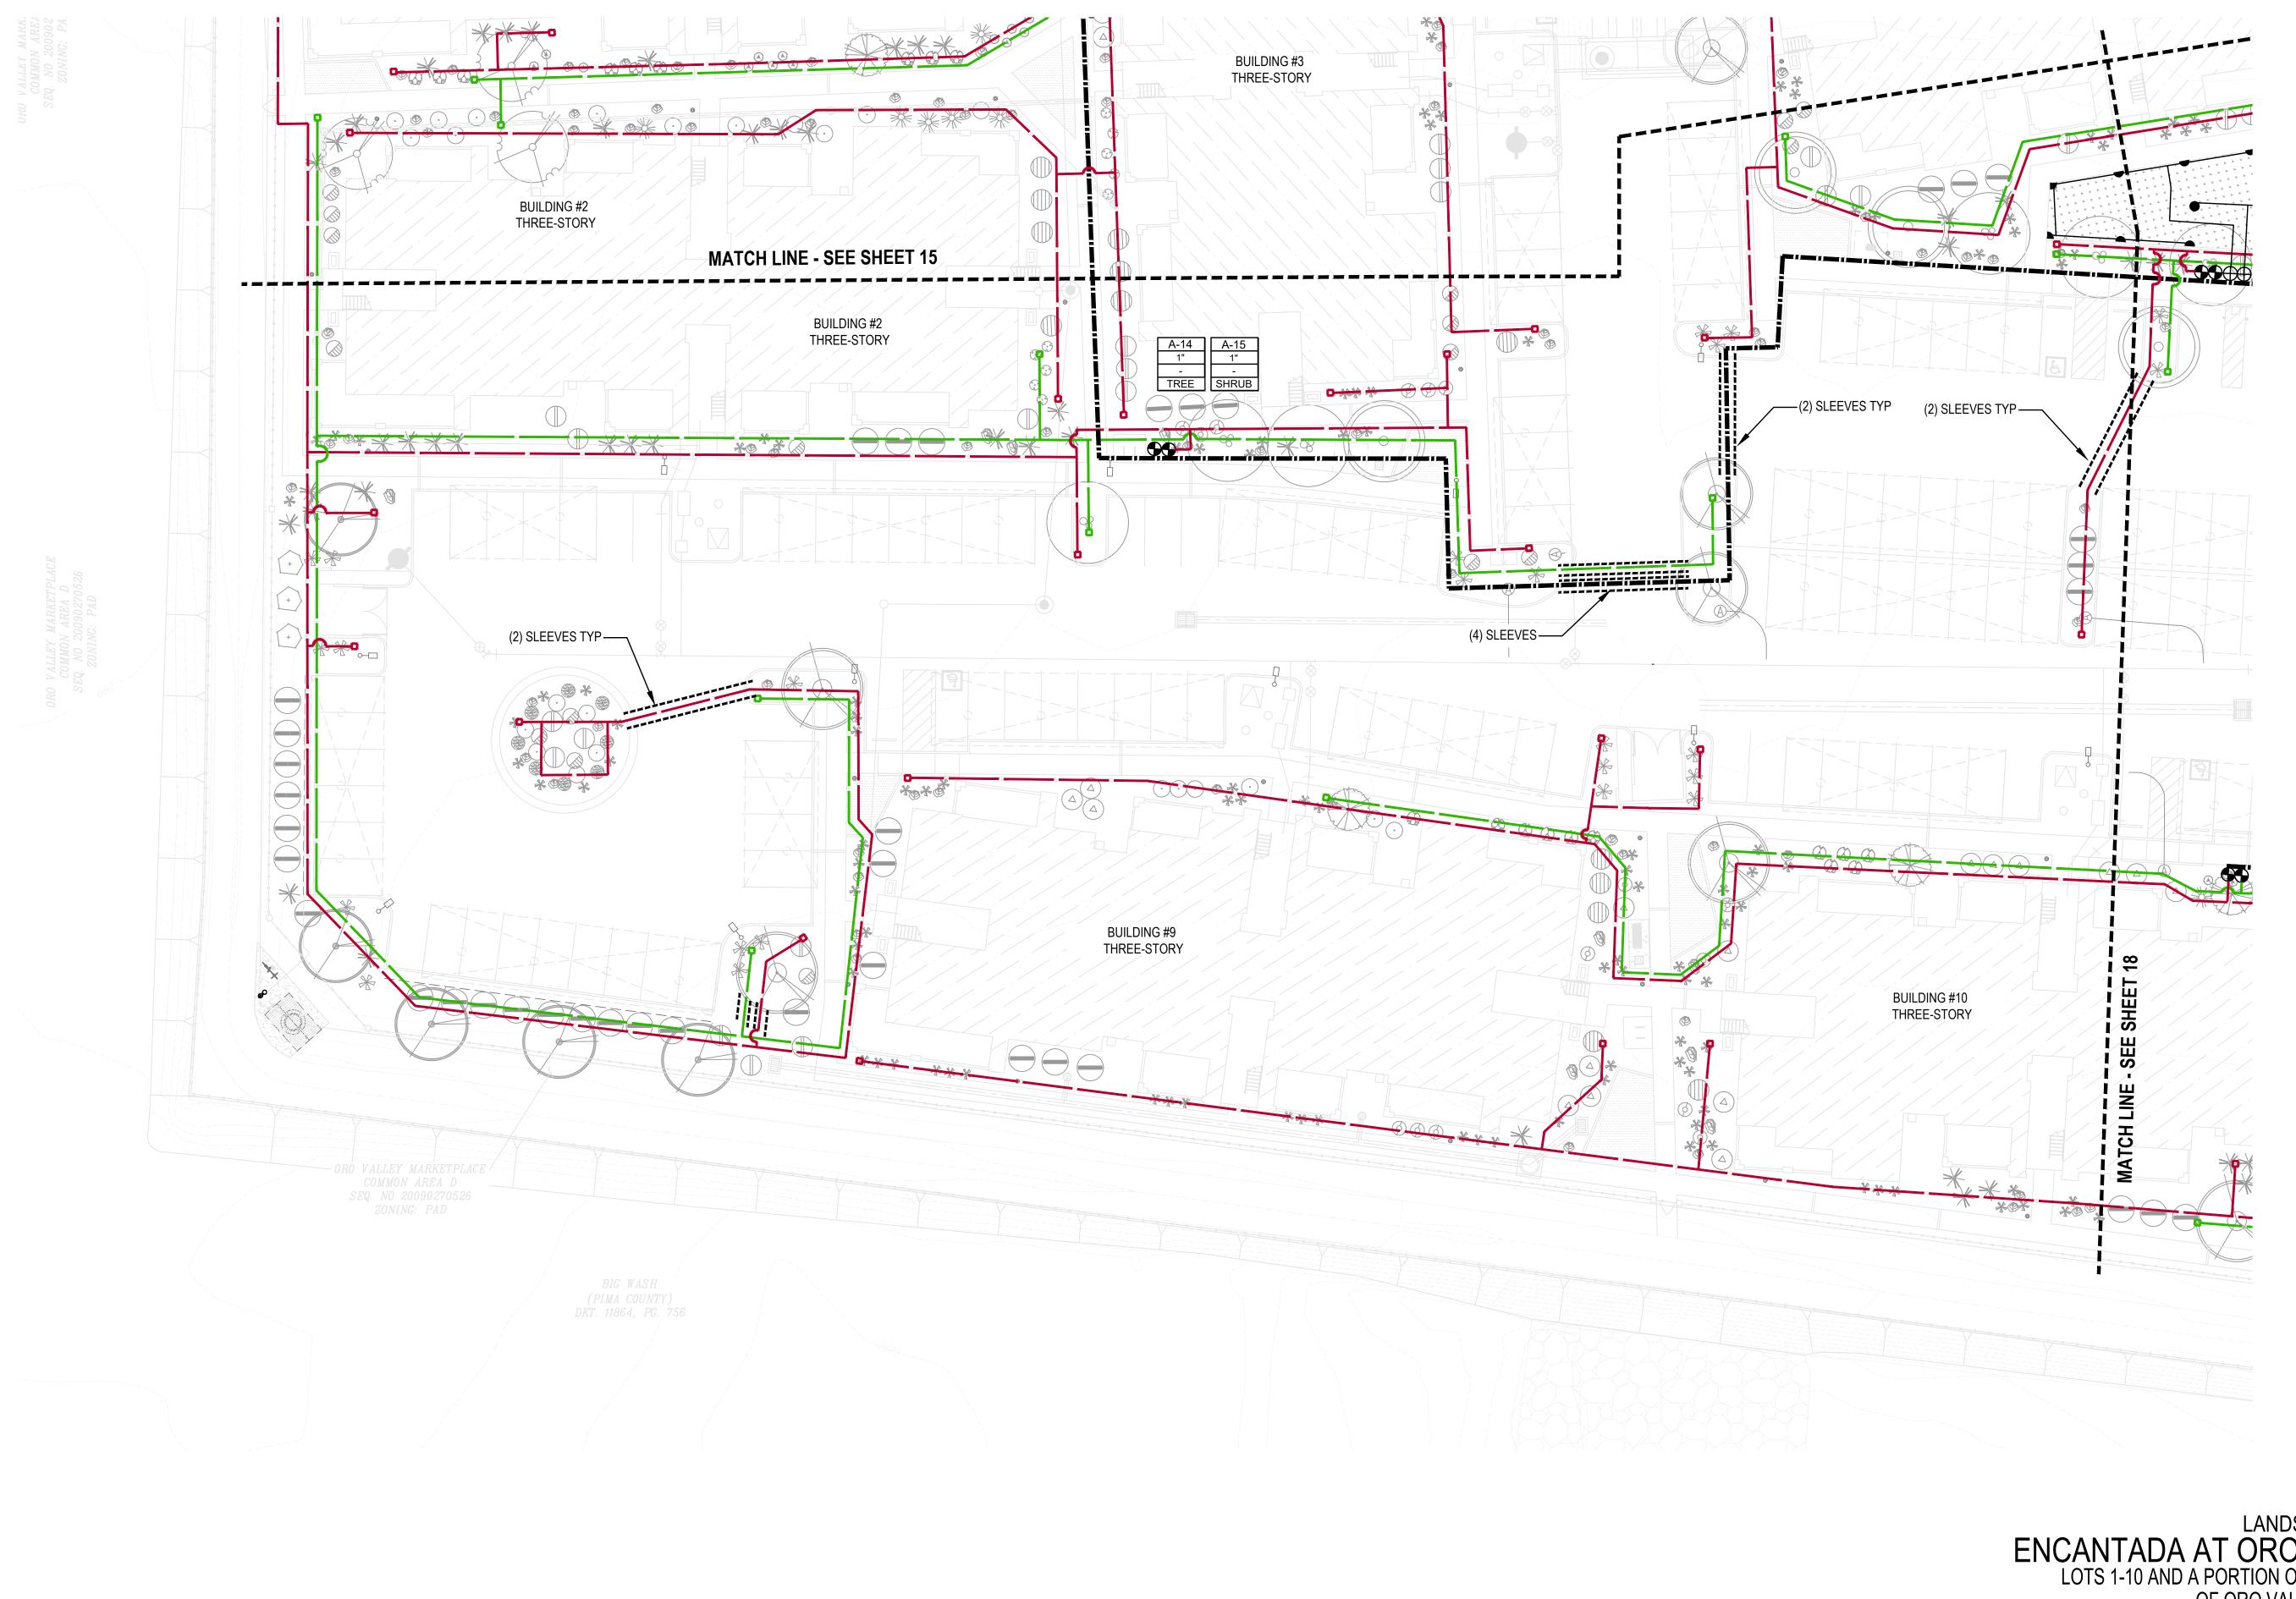
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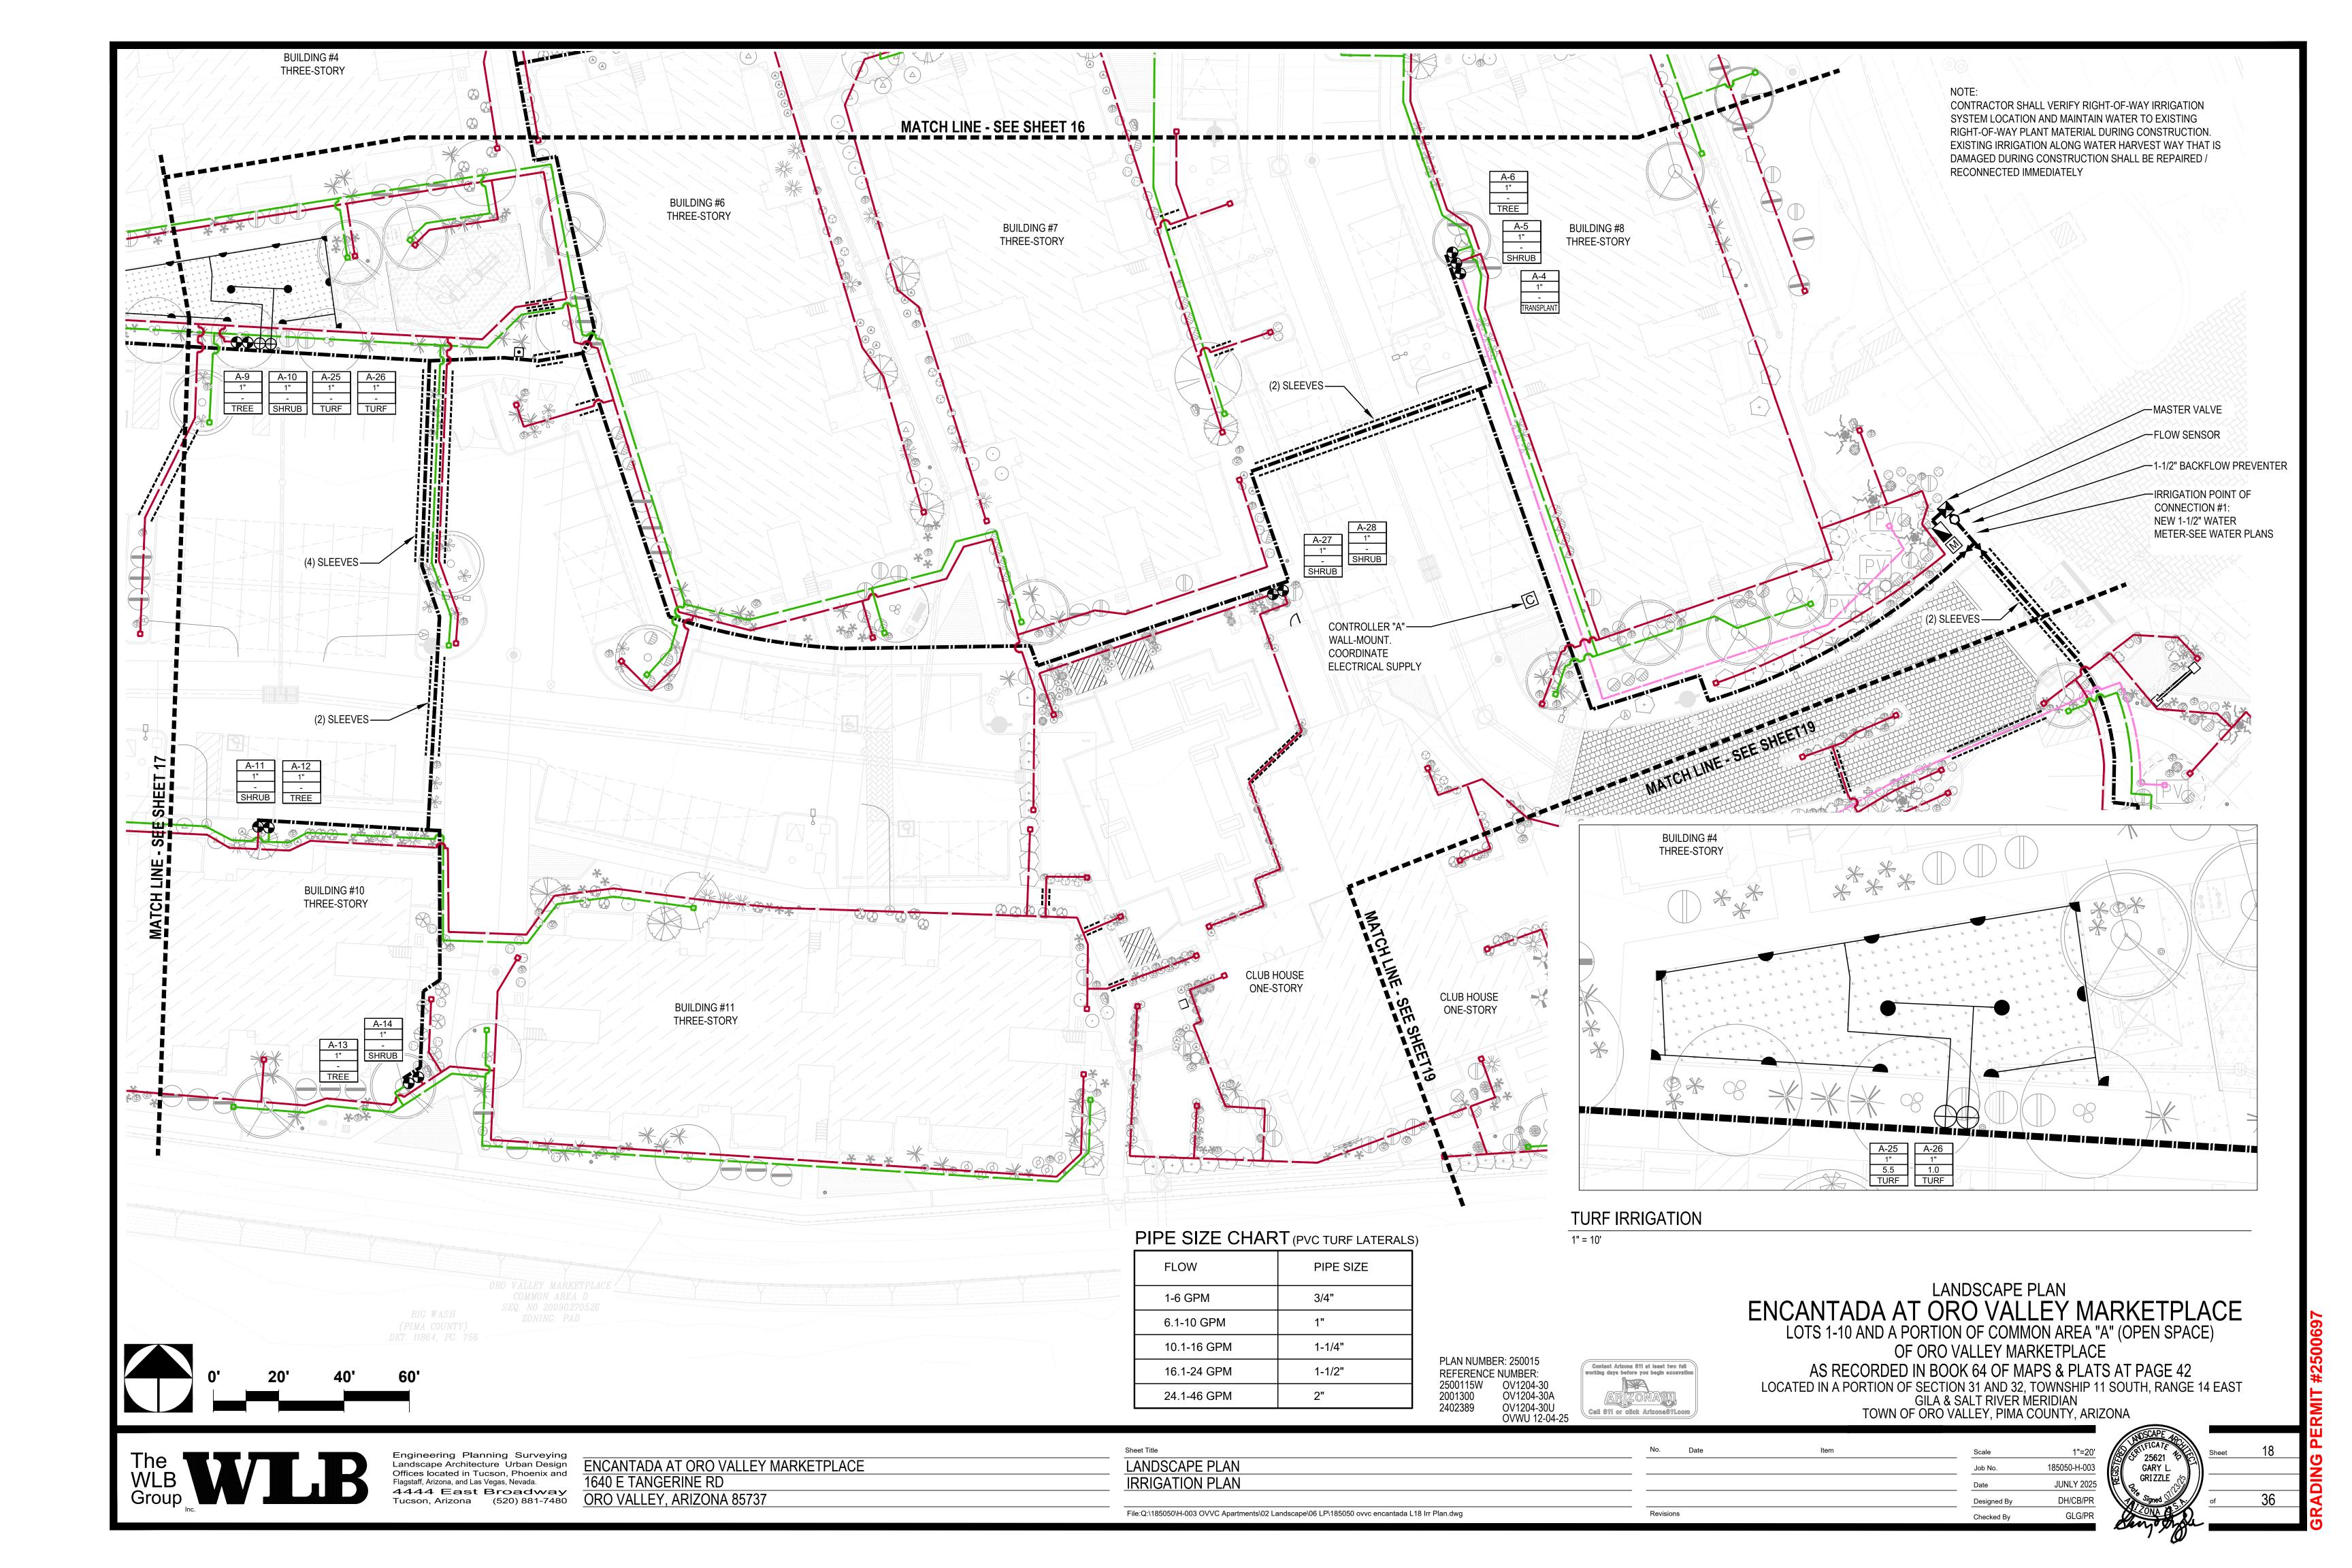
Call 811 or click Arizona811.com

PLAN NUMBER: 250015
REFERENCE NUMBER:
2500115W OV1204-30
P001300 OV1204-30A
P02389 OV1204-30U
OVWU 12-04-25


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LOCATED IN A PORTION OF SECTION 31 AND 32, TOWNSHIP 11 SOUTH, RANGE 14 EAST GILA & SALT RIVER MERIDIAN TOWN OF ORO VALLEY, PIMA COUNTY, ARIZONA

ENCANTADA AT ORO VALLEY MARKETPLACE 1640 E TANGERINE RD ORO VALLEY, ARIZONA 85737

Sheet Title LANDSCAPE PLAN IRRIGATION PLAN File:Q:\185050\H-003 OVVC Apartments\02 Landscape\06 LP\185050 ovvc encantada L19 Irr Plan.dwg

PLAN NUMBER: 250015
REFERENCE NUMBER:
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P001300 OV1204-30A
P02389 OV1204-30U
OVWU 12-04-25

Contact Arizona 811 at least two full working days before you begin excavation

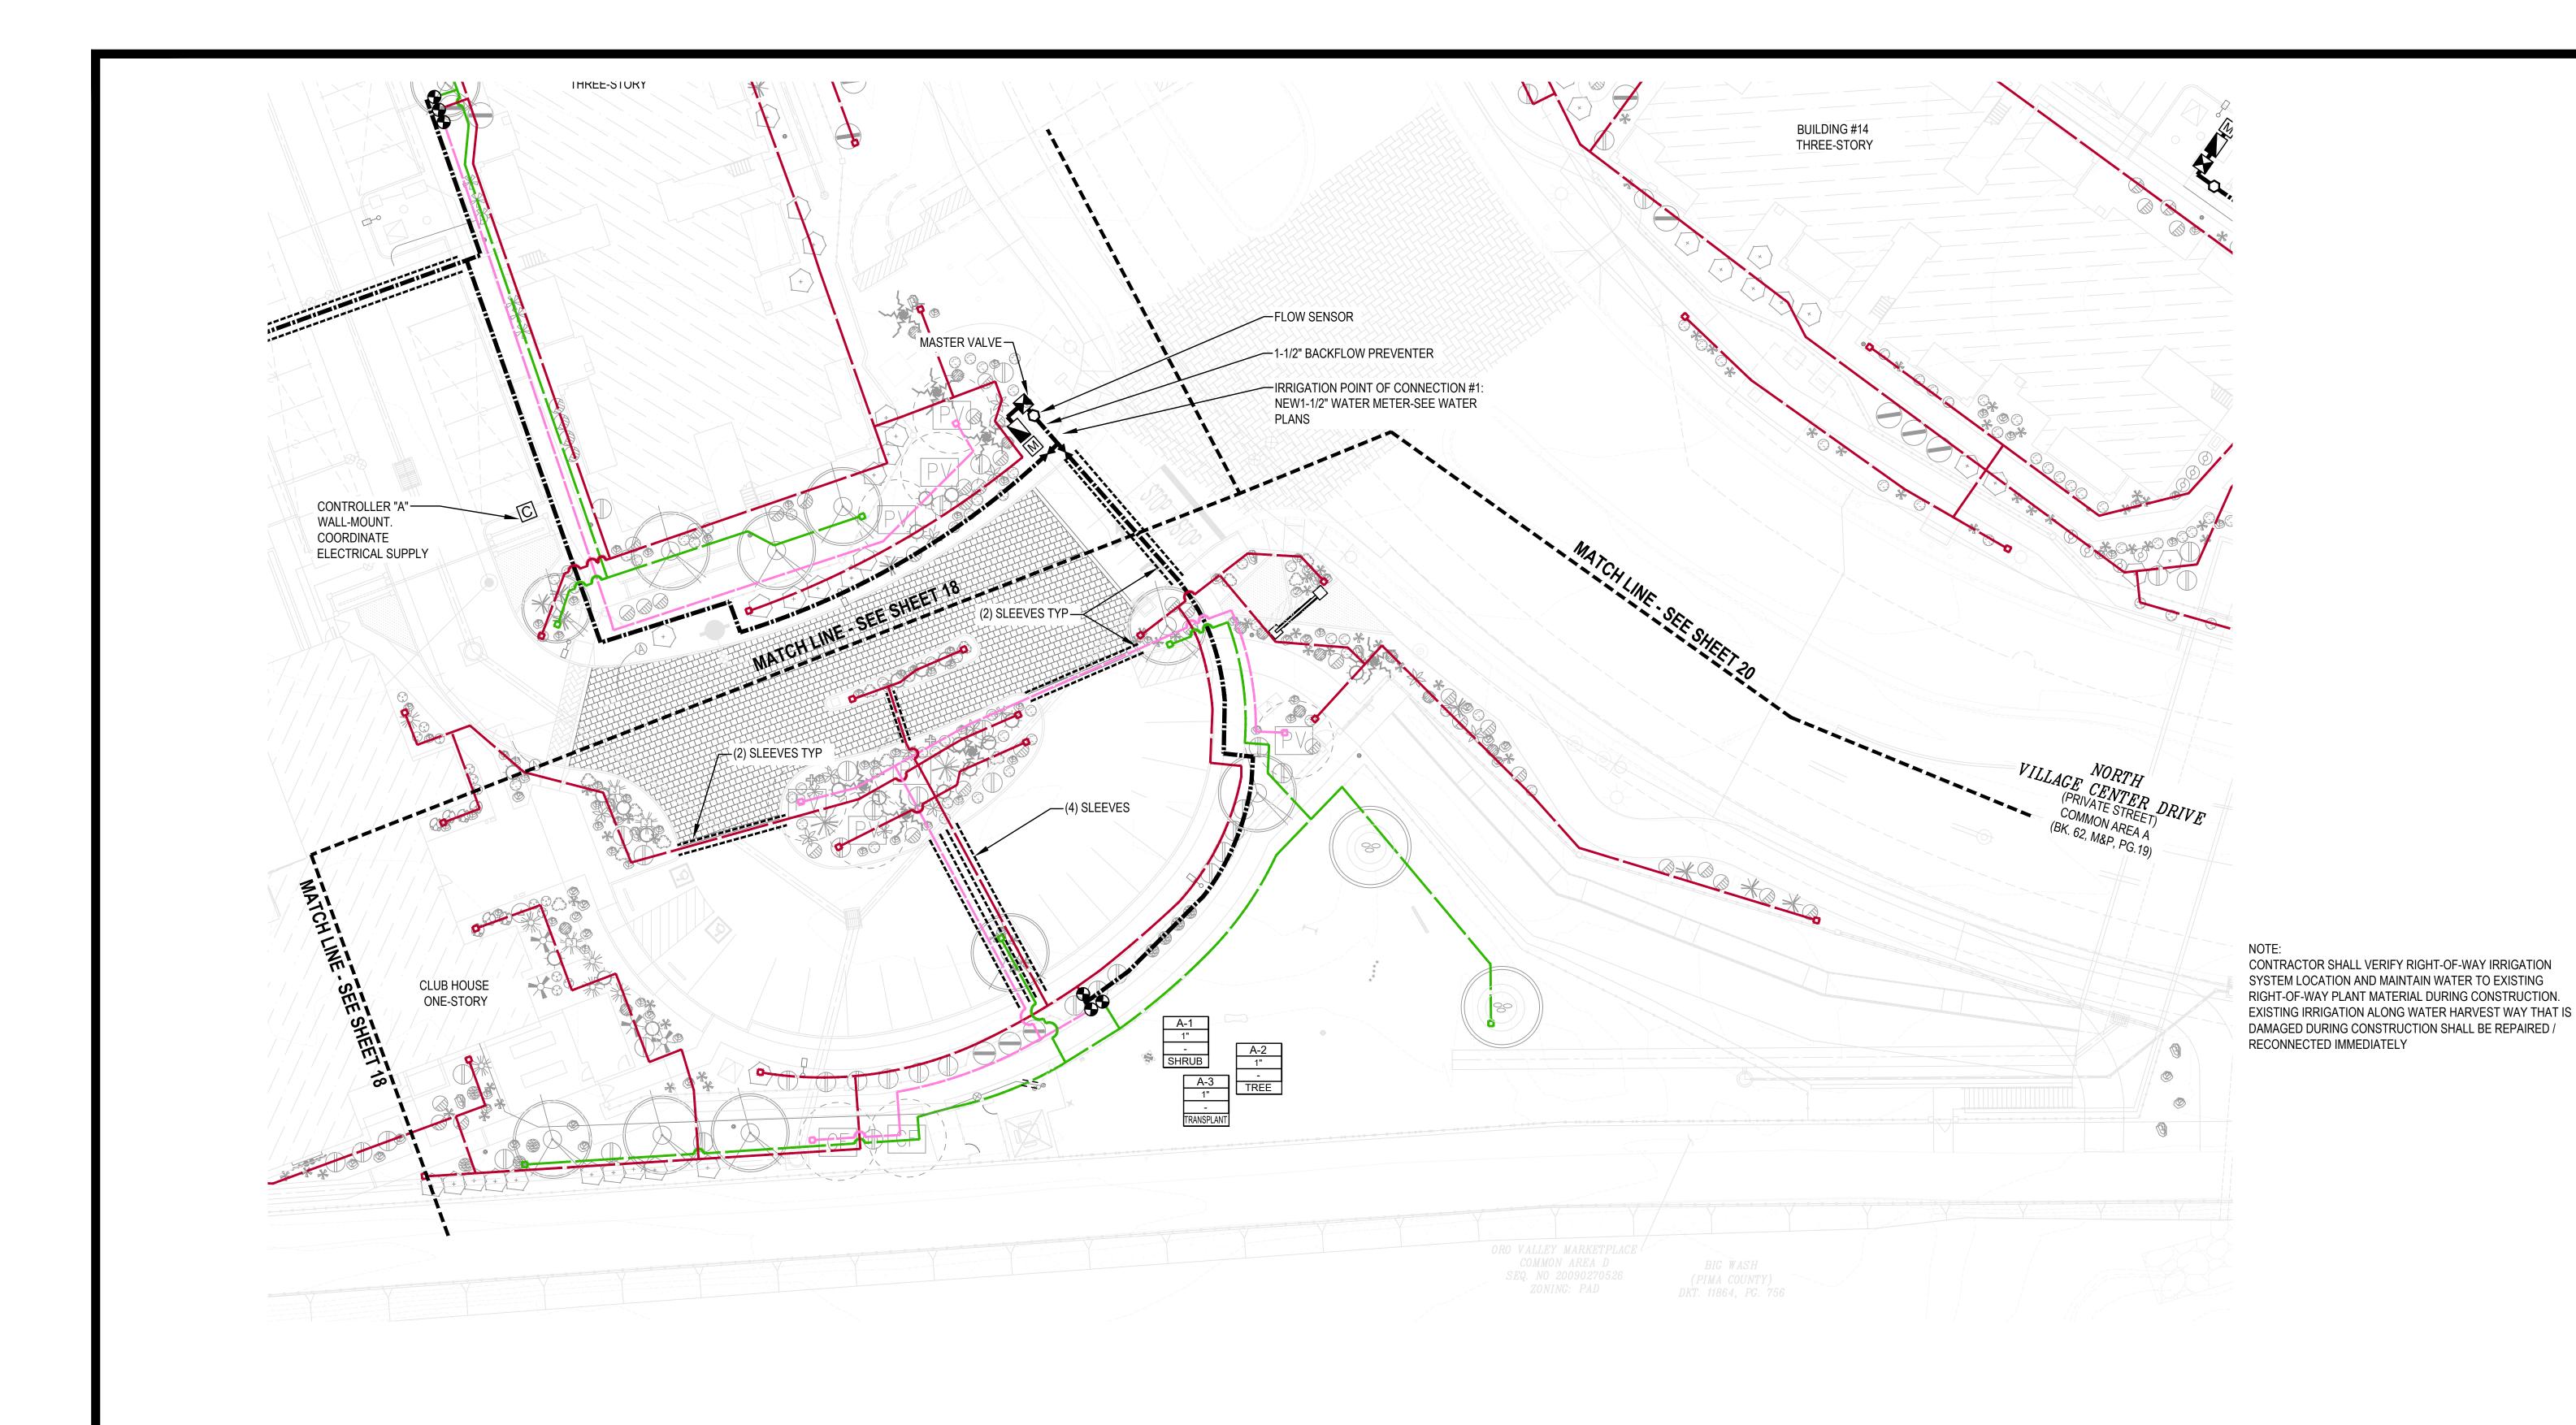
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PLAN NUMBER: 250015

185050-H-003 **JUNLY 2025** DH/CB/PR GLG/PR Checked By

| The WLB TT.R | Engineering Planning Surveying Landscape Architecture Urban Design Offices located in Tucson, Phoenix and Flagstaff, Arizona, and Las Vegas, Nevada. 4444 East Broadway |
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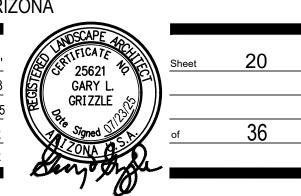
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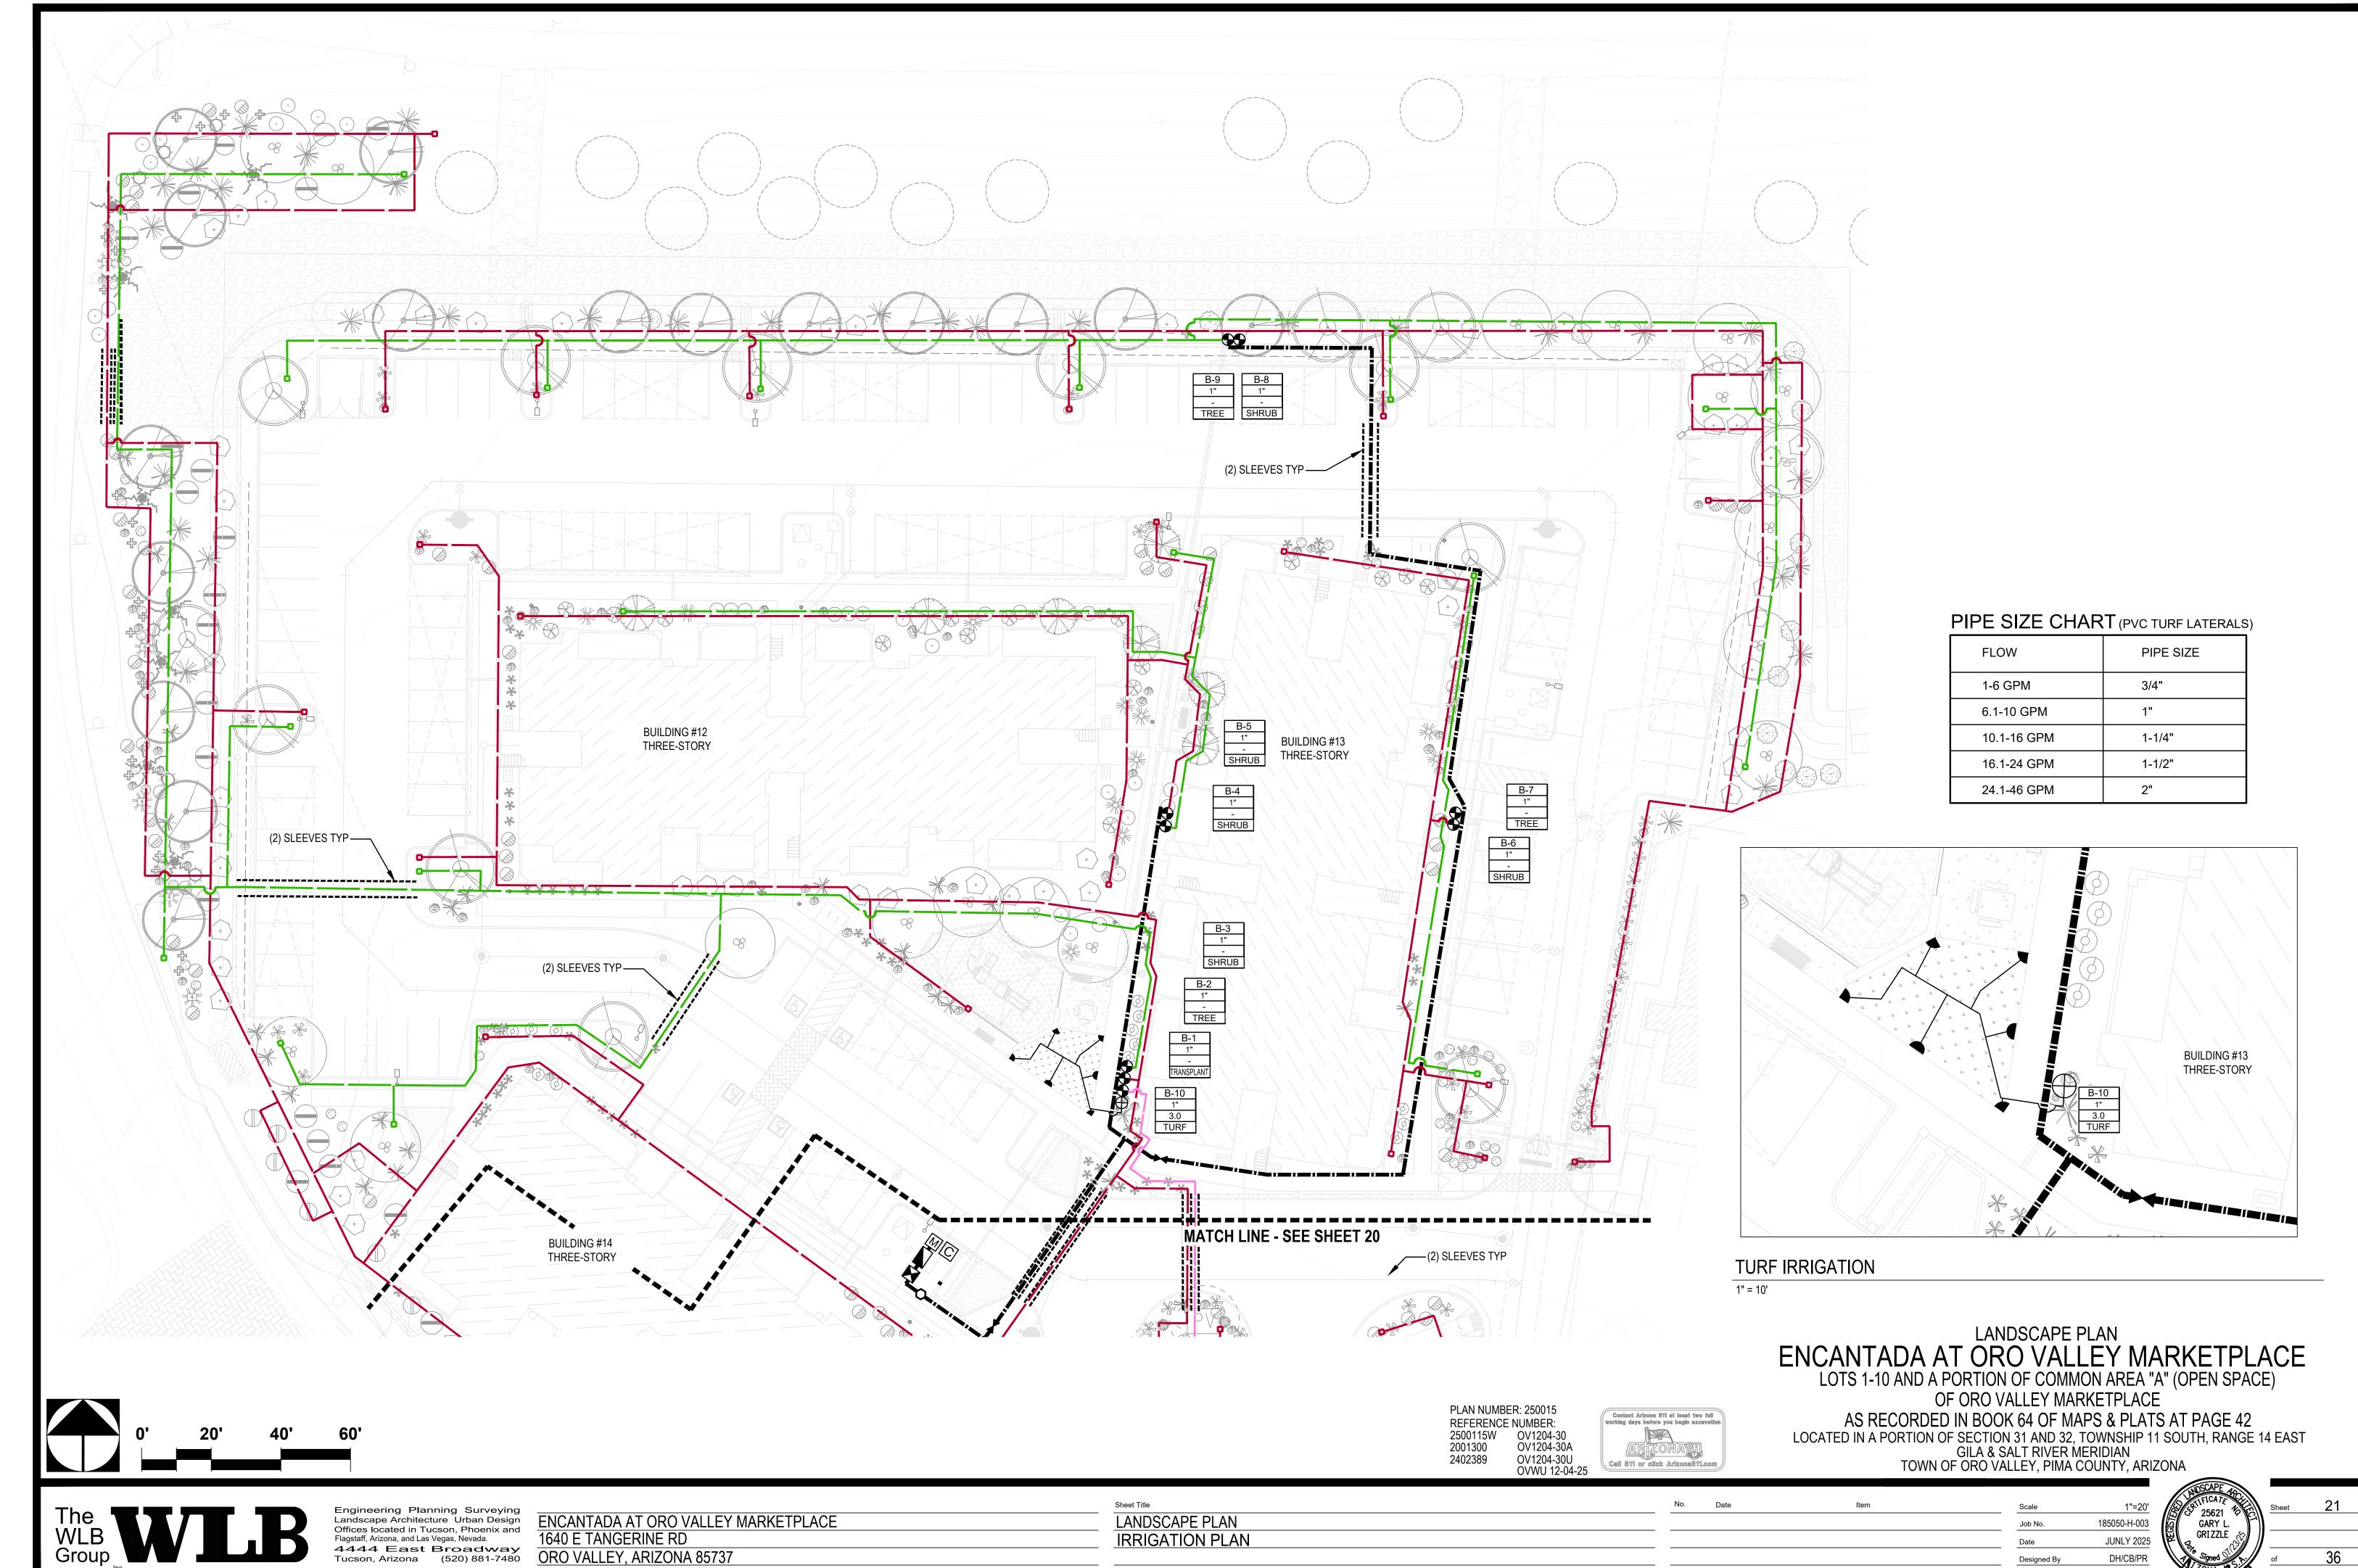
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ENCANTADA AT ORO VALLEY MARKETPLACE 1640 E TANGERINE RD ORO VALLEY, ARIZONA 85737

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185050-H-003 JUNLY 2025 DH/CB/PR GLG/PR Checked By



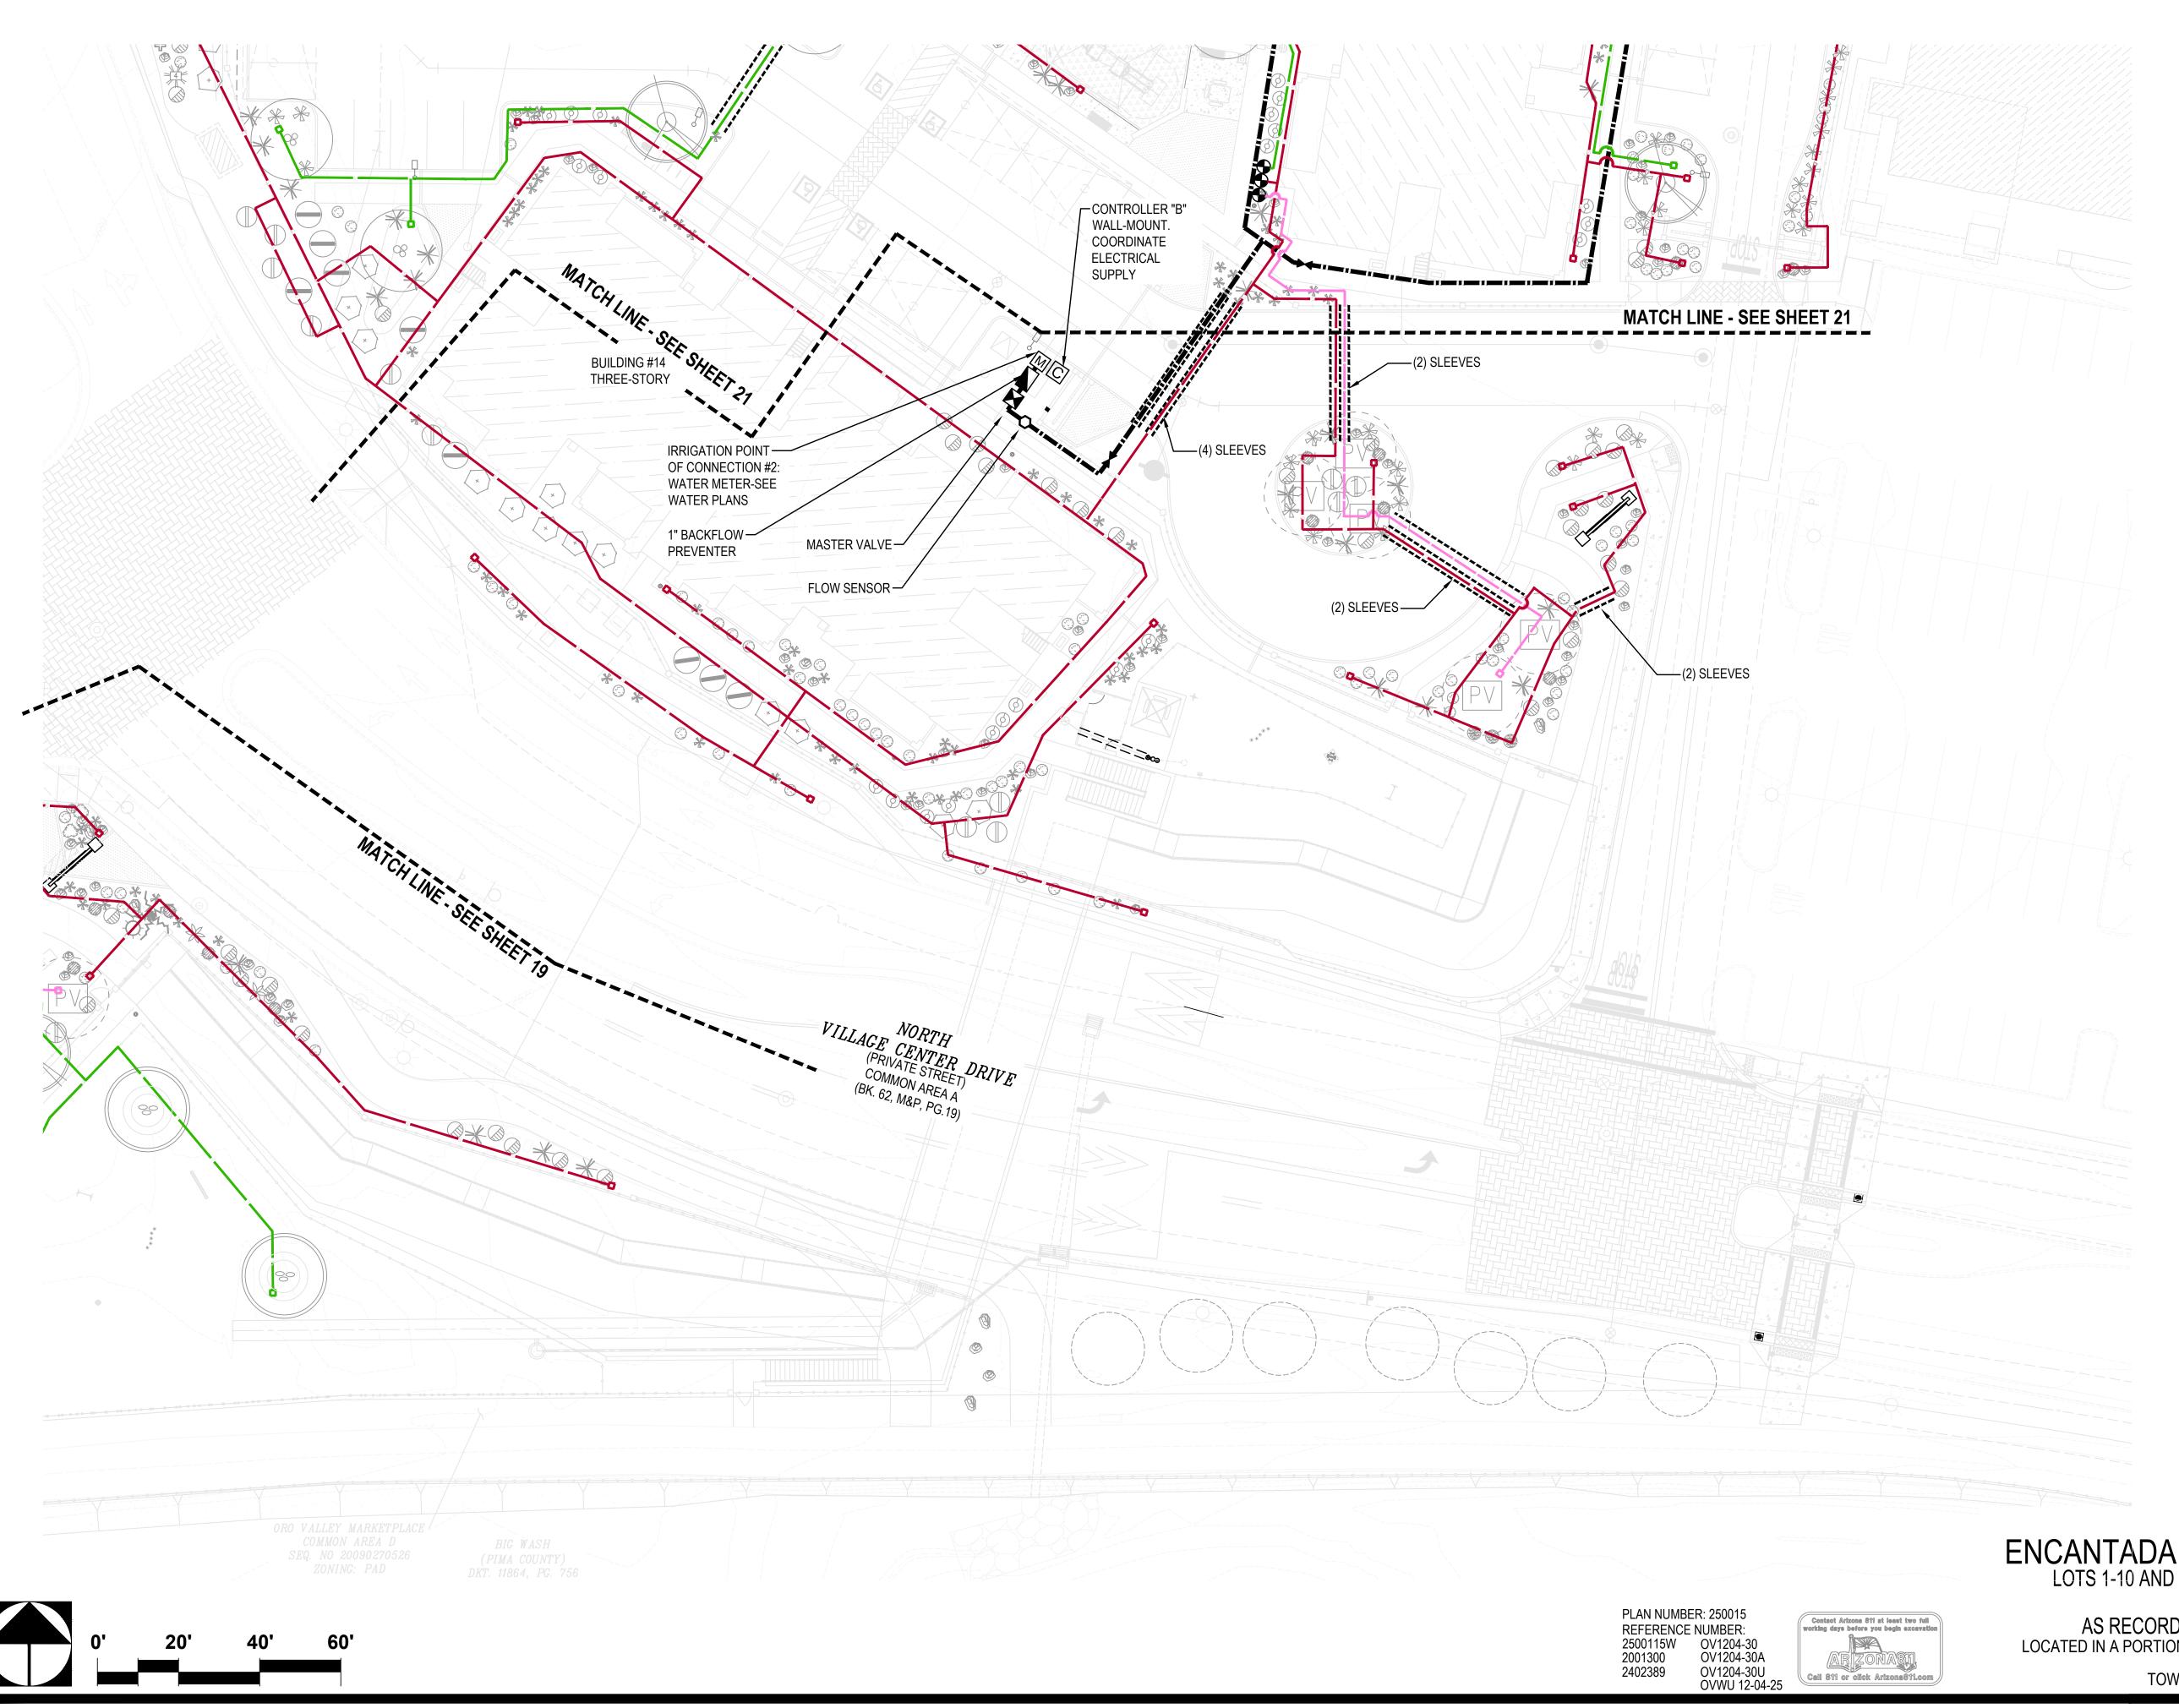


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ORO VALLEY, ARIZONA 85737

JUNLY 2025

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IRRIGATION DETAILS

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Flagstaff, Arizona, and Las Vegas, Nevada.

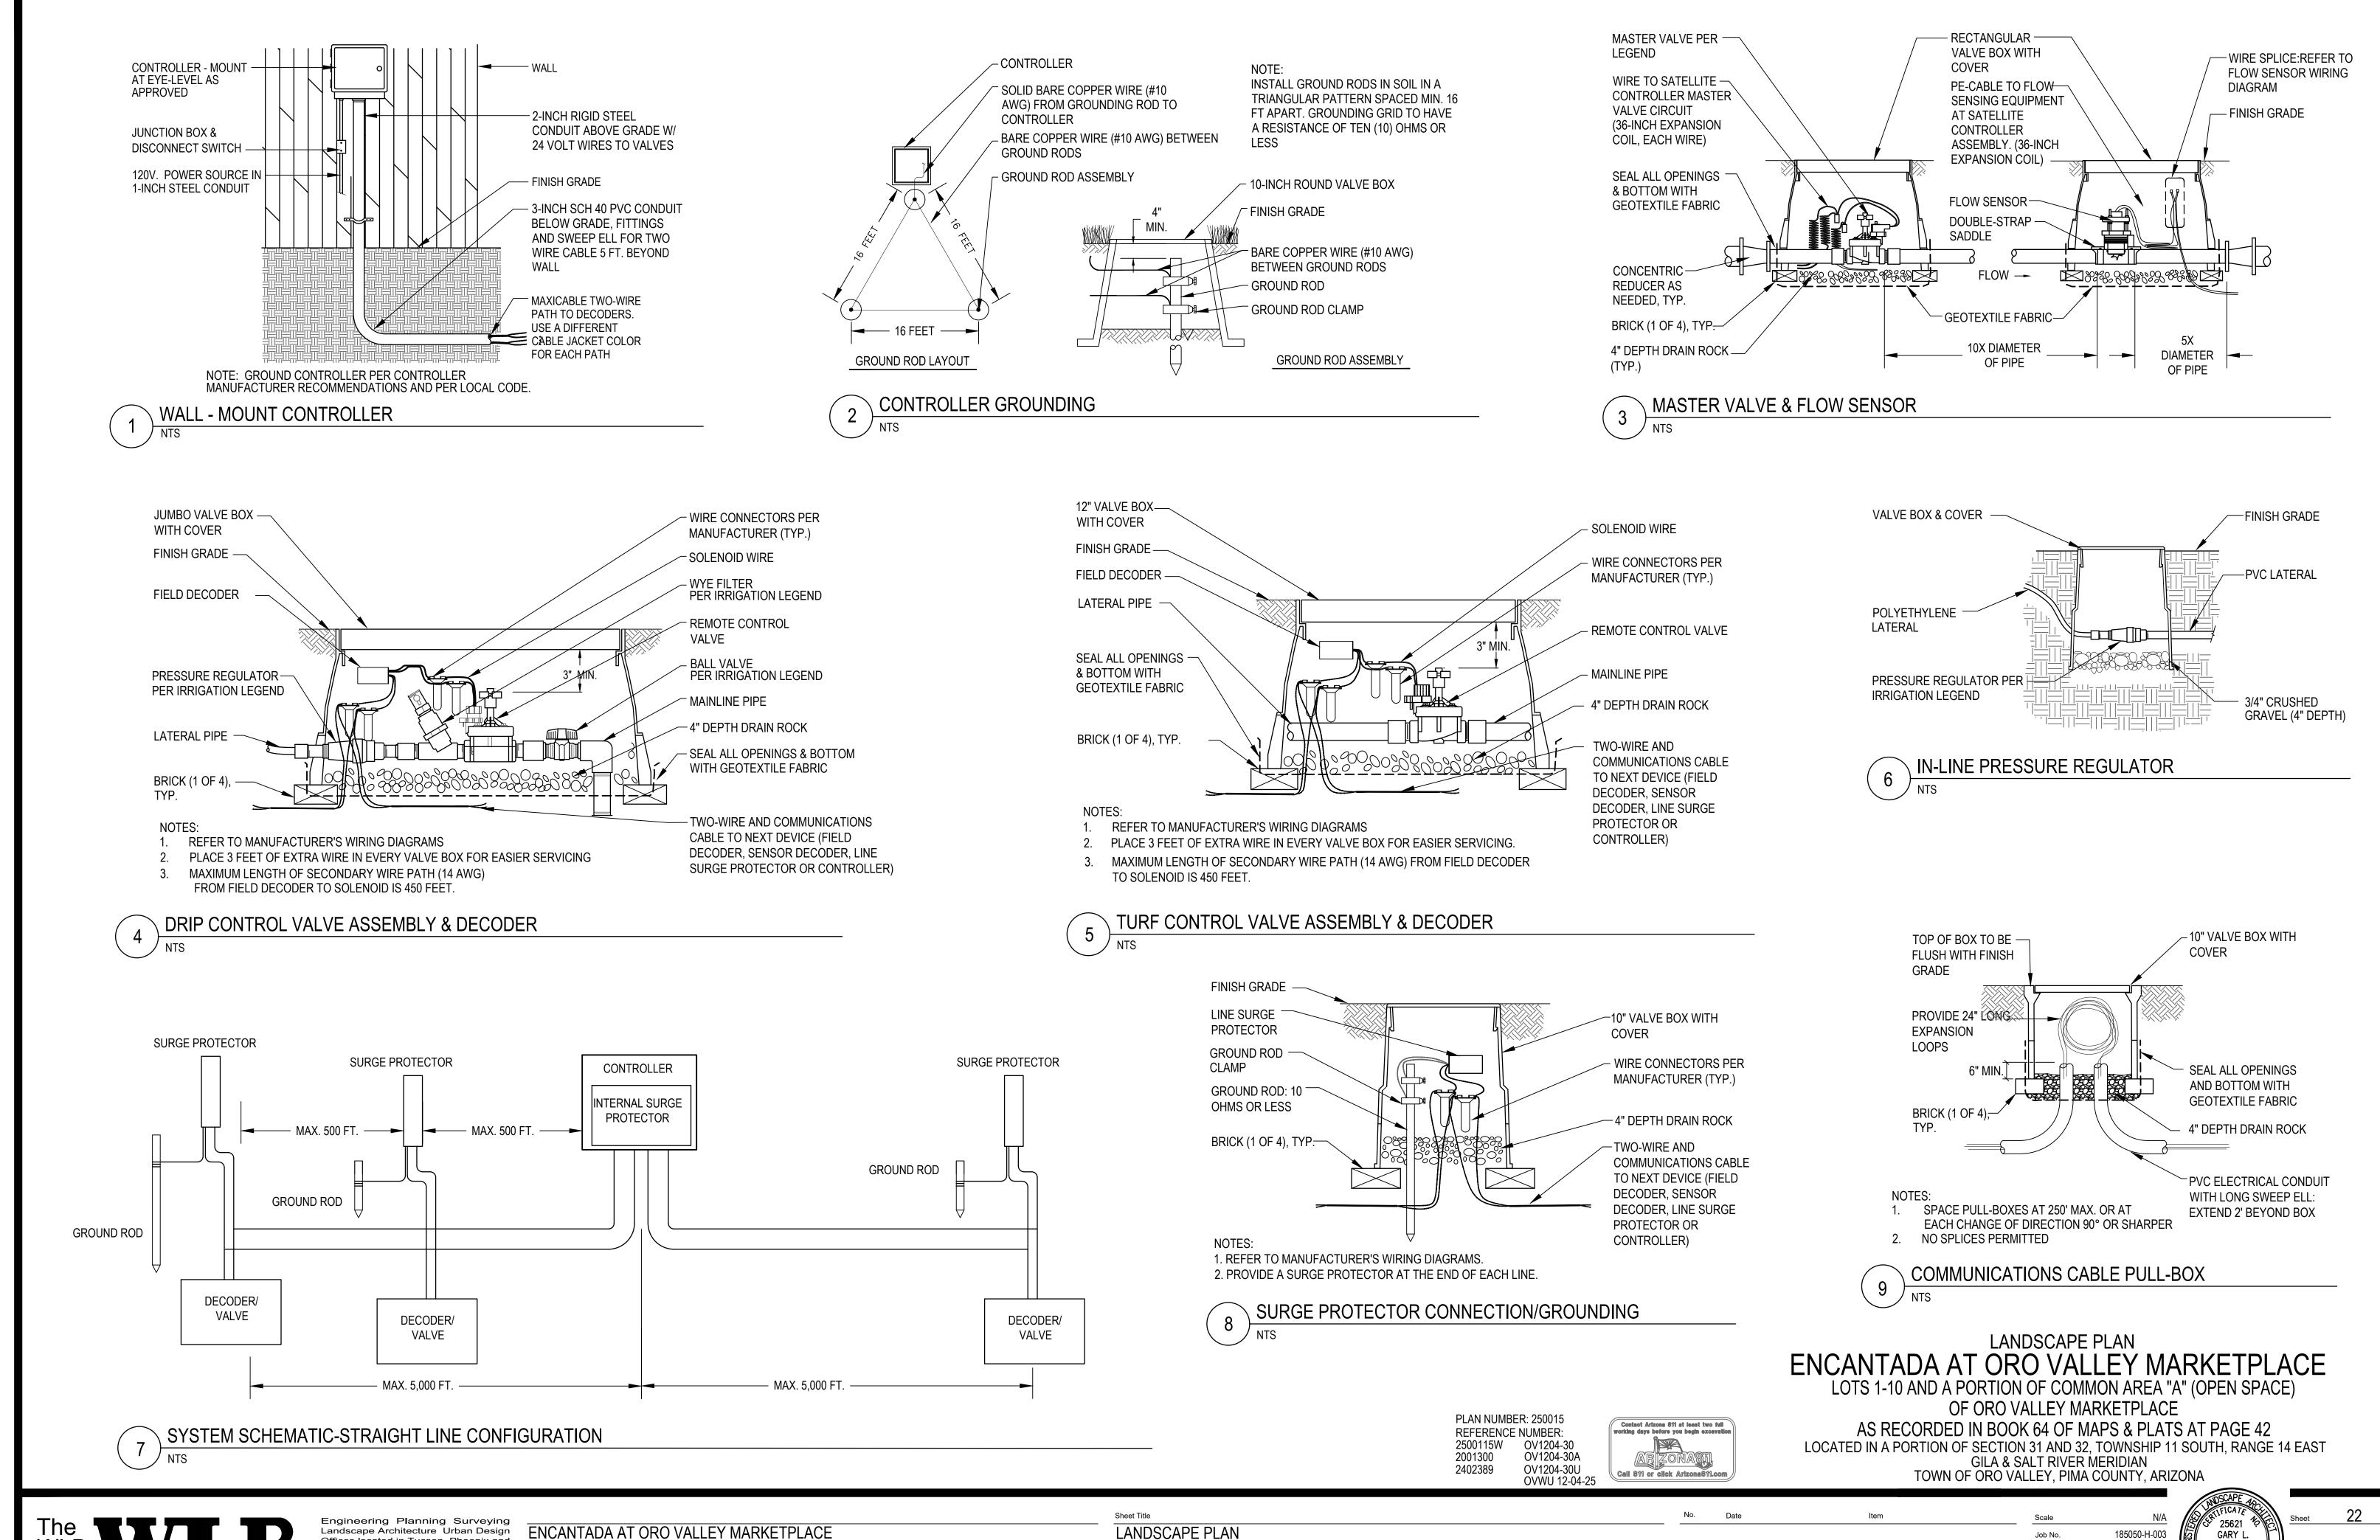1640 E TANGERINE RD

ORO VALLEY, ARIZONA 85737

Sheet 22

of 36

GRIZZLE


JUNLY 2025


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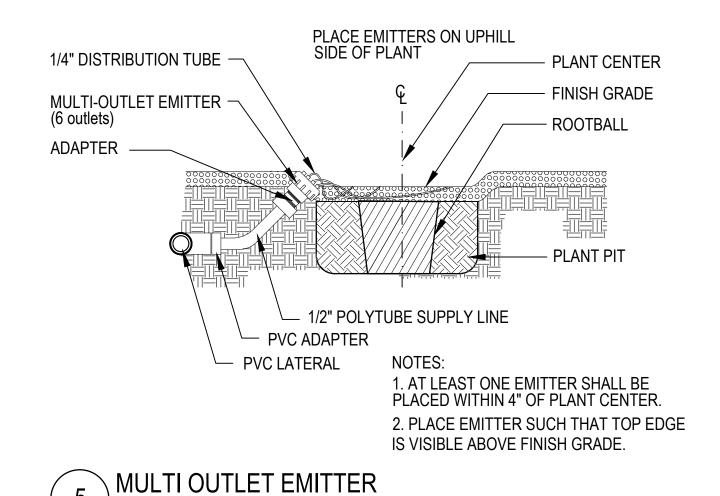
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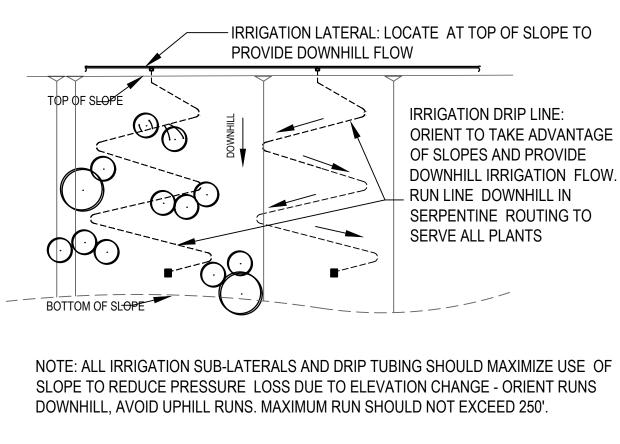
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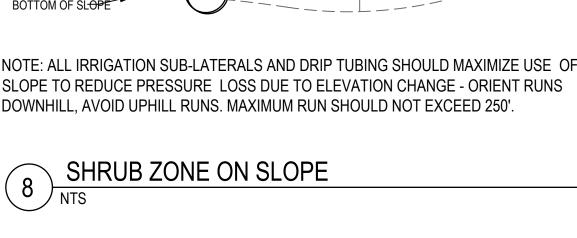









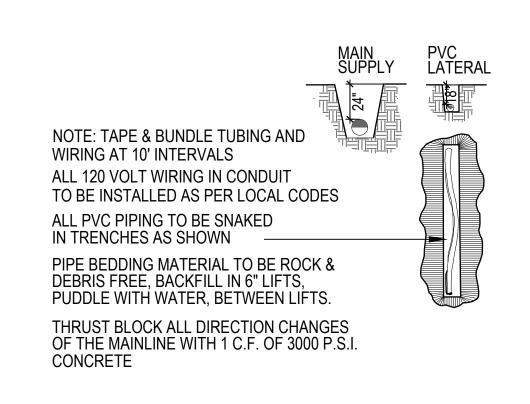


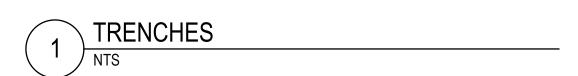

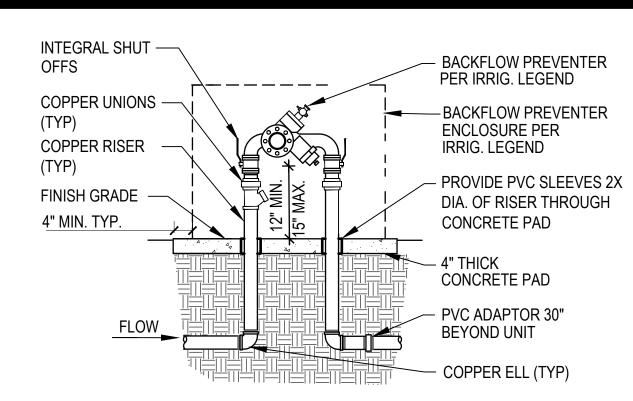



NOTES: PROVIDE BACKFLOW TESTING PER WATER COMPANY STANDARDS. PROVIDE TAN COLOR R30 "FROSTGUARD" BLANKET



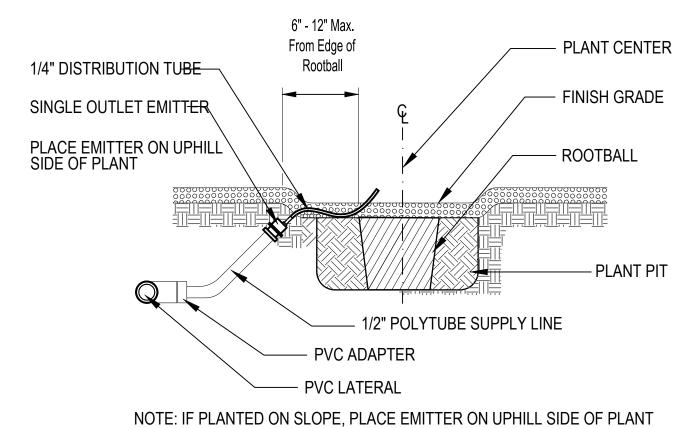




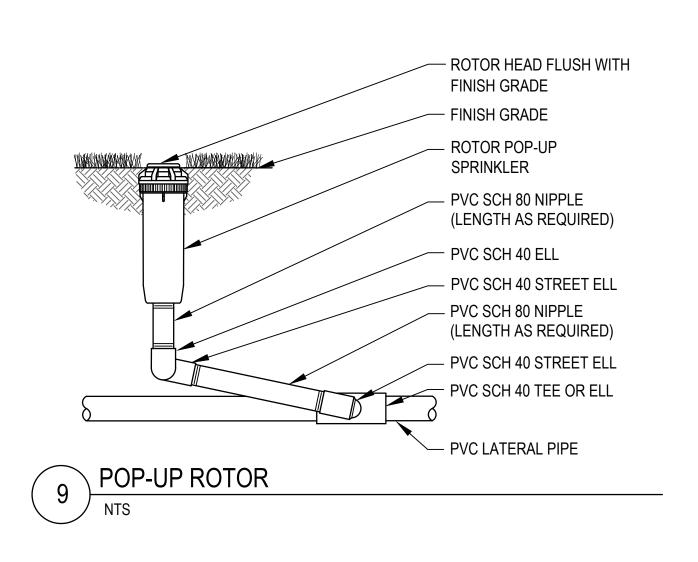


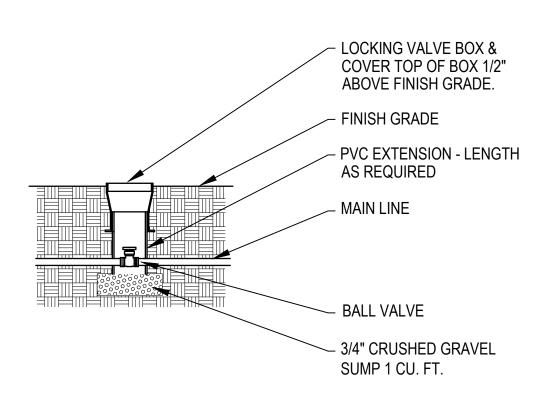



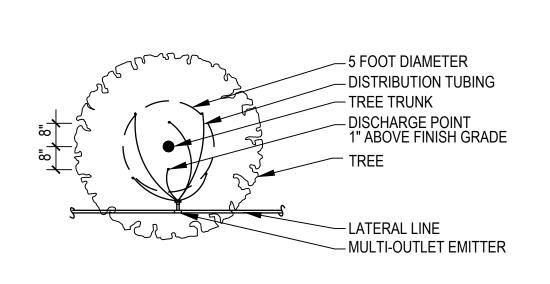



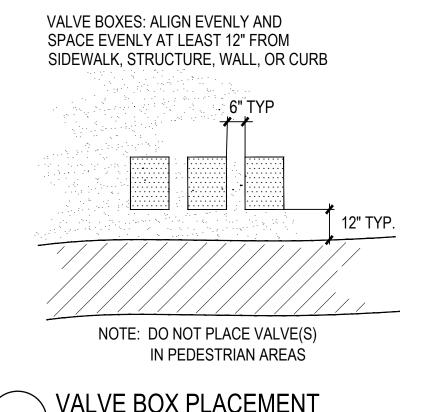

PLAN NUMBER: 250015

REFERENCE NUMBER:

2500115W 2001300

2402389

OV1204-30 OV1204-30A

OV1204-30U OVWU 12-04-25


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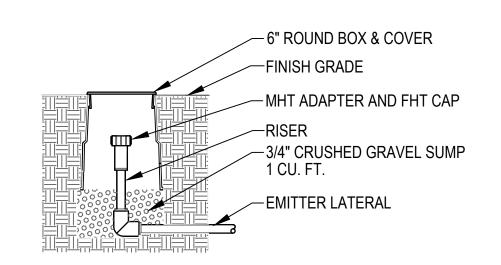
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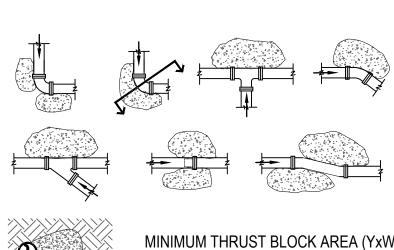










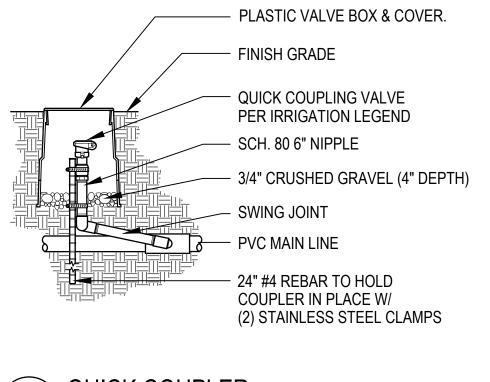

| MINIMUM THRUST BLOCK AREA (YxW) | | | | | | |
|---------------------------------|--------------|-----------------|-----------------|--|--|--|
| | PIPE | IRRIGATION PIPE | | | | |
| SECTION | />/>/>/ SIZE | | 45° & 22.5° | | | |
| THRUST BLOCK | <2" | NOT REQUIRED | NOT REQUIRED | | | |
| | 3" | 1:5 SF | 1 SF | | | |
| BLOCK SEE | 4" | 3 SF | 3 SF | | | |
| 1'-0" MIN. | 6" | 4 SF | 3 SF | | | |

| NTS |
|-----|
|-----|

LANDSCAPE PLAN ENCANTADA AT ORO VALLEY MARKETPLACE LOTS 1-10 AND A PORTION OF COMMON AREA "A" (OPEN SPACE)

OF ORO VALLEY MARKETPLACE AS RECORDED IN BOOK 64 OF MAPS & PLATS AT PAGE 42

LOCATED IN A PORTION OF SECTION 31 AND 32, TOWNSHIP 11 SOUTH, RANGE 14 EAST GILA & SALT RIVER MERIDIAN TOWN OF ORO VALLEY, PIMA COUNTY, ARIZONA



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1640 E TANGERINE RD ORO VALLEY, ARIZONA 85737

Sheet Title LANDSCAPE PLAN IRRIGATION DETAILS

185050-H-003 Job No. **JUNLY 2025** DH/CB/PR GLG/PR



ENCANTADA AT ORO VALLEY MARKETPLACE

File:Q:\185050\H-003 OVVC Apartments\02 Landscape\06 LP\185050 ovvc encantada L23 Irr Dets.dwg

- 1.1 SUMMARY
- Seeding.
- Sodding. Trees, Shrub and Cacti.

A. This Section includes the following:

- 4. Inert Ground Cover.
- 1.2 SUBMITTAL REQUIREMENTS
- A. General: The Contractor shall make the submittals identified below. Submittals shall be approved prior delivery or placement of materials.
- B. Certificates of Compliance: Submit 3 copies of the following certificates of compliance to the Owner's Representative for review and approval:
- 1. Fertilizer, Soil Sulfur, Gypsum, Manganese Sulfate: Manufacturer's certified statement of analysis
- 2. Organic Soil Conditioner: A certificate, signed by the supplier, stating that the product complies with the project specifications
- 3. Soil Stabilizer: Manufacturer's certified statement of analysis.
- C. Materials Test Reports: for existing surface soil and imported soil.
- D. Certification of Grass Seed: From seed vendor for each grass-seed monostand or mixture stating the botanical and common name and percentage by weight of each species and percentage of purity, germination, and weed seed. Include the year of production and date of packaging.
- 1. Certification of each seed mixture for turfgrass sod, identifying source, including name and telephone number of supplier.
- E. Samples for Verification: For each of the following provide the following samples: 1. 5 lb of decomposed granite mulch for the color and gradation of decomposed granite proposed for use on the project, in labeled plastic bag.
- 1.3 COMPLIANCE WITH APPLICABLE REGULATIONS
- A. The Contractor shall comply with all local, state, and federal regulations regarding materials, methods of work, and disposal of excess and waste materials. The Contractor shall provide notices required by all governmental authorities, request required inspections, obtain required permits, and pay for all associated fees.
- 1.4 QUALITY ASSURANCE
- A. Installer Qualifications: All work shall be performed by a Contractor licensed by the State of Arizona Register of Contractors. The commercial license held by the Contractor shall be appropriate for the work being performed.
 - 1. The Contractor shall maintain an experienced full-time supervisor on Project site the construction period.
- B. Observation: Owner's Representative may observe plants either at place of growth or at site before planting for compliance with requirements for genus, species, variety, size, and quality. Owner's Representative retains right to observe plants further for size and condition of balls and root systems, insects, injuries, and latent defects and to reject unsatisfactory or defective material at any time during progress of work. Remove rejected plants immediately from Project site. Owner's Representative may observe any and all plant pits prior to backfilling or planting.
- 1.5 DELIVERY, STORAGE, AND HANDLING
- A. Do not prune trees, shrubs and cacti before delivery, except as approved by Owner's Representative. Protect bark, branches, and root systems from sun scald, drying, sweating, whipping, and other handling and tying damage. Do not bend or bind-tie trees, shrubs or cacti in such a manner as to destroy their natural shape. Provide protective covering of plants during delivery. Do not drop
- B. Deliver plants after preparations for planting have been completed and install immediately. If planting is delayed more than six hours after delivery, protect from weather and mechanical damage, and keep roots moist. Do not remove container-grown stock from containers before time of planting.
- C. Inorganic Soil Amendments: Deliver in original sealed, labeled, and undamaged containers.
- D. Fertilizer: Deliver in original sealed, labeled, and undamaged containers.
- E. Sod: Harvest, deliver, store, and handle sod according to requirements in TPI's "Specifications for Turfgrass Sod Materials" and "Specifications for Turfgrass Sod Transplanting and Installation" in its "Guideline Specifications to Turfarass Sodding."
- 1. Sod shall be harvested, delivered to site, and installed, within a 24-hour period.
- 2. Sod shall be kept moist, protected from wind and sun from the time of cutting to the of installation.
- 1.6 COORDINATION
- A. Weather Limitations: Proceed with planting only when existing and forecasted weather conditions
- B. Work that is completed or in-progress shall be protected during installation of landscape work. The Contractor shall coordinate all landscape related work with the Owner's Representative.
- 1.7 GUARANTEE
- A. The Contractor shall guarantee all Contractor provided plants for the period indicated, commencing on the date of Final Acceptance, against all defects including death and unsatisfactory growth, except for defects resulting from lack of adequate maintenance, neglect, or abuse by Owner, causes deliberate, or incidents that are beyond Contractor's control.
- 1. Guarantee Period for Trees, Shrubs and Cacti: One year from date of Substantial Completion.
- Guarantee Period for Turf: ninety days from date of Substantial Completion. 3. Remove dead plants immediately. Replace immediately unless directed otherwiseby Owner's
- Representative.
- 4. Replace plants that are diseased, or that exhibit more than 25 percent die-back, at end of guarantee
- 5. A limit of one replacement of each plant will be required, except for losses or replacements due to failure to comply with requirements.
- 6. Include the following remedial actions for turf as a minimum: a. Immediately remove dead turf and replace.
- b. Repair failed areas due to erosion, replace erosion control materials in failed areas c. Sod bare seeded areas or other by methods acceptable to Owner's Representative.

- 1.8 MAINTENANCE DURING CONSTRUCTION
- A. The Contractor shall maintain throughout the construction period all trees, shrubs, cacti, decomposed granite, and other landscape improvements. Maintenance during construction shall continue until the issue of a Certificate of Substantial Completion. All maintenance and plant replacements throughout the construction period shall be at no additional cost to the Owner.
- 1. Trees, Shrubs and Cacti: During the construction, maintain by pruning, cultivating, watering, weeding, fertilizing, restoring planting saucers, tightening and repairing stakes and guy supports, clean-up and resetting to proper grades or vertical position, as required to establish healthy, viable plantings. Spray as required to keep trees, shrubs, and cacti free of insects.
- 2. Turf: Begin maintenance immediately after each area is planted and continue until acceptable lawn is established, but for not less than the following periods:
- 3. Maintain and establish lawn by watering, fertilizing, weeding, mowing, trimming, replanting and other operations. Roll, regrade, and replant bare or eroded areas and re-mulch to produce a uniformly smooth lawn.
- 4. Turf Watering: Schedule watering to prevent wilting, puddling, erosion, and displacement of seed or mulch. Lay out temporary watering system to avoid walking over muddy or newly planted areas. Mowing: Mow lawn as soon as top growth is tall enough to cut. Repeat mowing to maintain specified
- height without cutting more than 40 percent of grass height. Remove no more than 40 percent of grass-leaf growth in initial or subsequent mowings. Do not delay mowing until grass blades bend over and become matted. Do not mow when grass is wet. Schedule initial and subsequent mowings to maintain supplier's recommended growing height:
- Lawn Postfertilization: Apply fertilizer after initial mowing and when grass is dry. Use fertilizer that will provide actual nitrogen of at least 1 lb/1000 sq. ft. to lawn area.
- 8. Decomposed Granite (including stabilized and field mixes): During the construction, maintain by raking, weeding, recompacting, reapplying, regrading, and repairing eroded areas. Protect field areas from traffic.
- B. Inspection of Completed Landscape Work: Upon completion of the landscape work, the Contractor shall notify the Owner's Representative who will schedule an inspection of the landscape improvements. During the inspection, items which are incomplete or which must be repaired or replaced will be identified. Completion or correction of items noted will be required prior to the issuance of a Certificate of Substantial Completion.
- 1.9 MAINTENANCE AFTER SUBSTANTIAL COMPLETION
- A. Maintenance Period: Six months from date of Substantial Completion for trees, shrubs, cactus and other landscape improvements. All work shall be performed in a professional manner within the standards of the industry, using quality equipment methods and materials.
- B. Initial Turf Maintenance Service: Provide full maintenance by skilled employees of landscape Installer. Maintain as required in Part 3. Begin maintenance immediately after each area is planted and continue until acceptable turf is established but for not less than the following periods: a. Maintain until 60 days after Substantial Completion of turf.
- C. Stand of Sodded Turf: A stand of turf from the sodding operation is defined as a healthy, well-rooted, even-colored, viable turf area, free of weeds, open joints, bare areas, and surface irregularities.
- D. Re-establish turf that does not comply with requirements and continue maintenance until turf meet the above standards.
- E. At the end of the turf maintenance period (after substantial completion), a final inspection will be made. Final acceptance of the turf will be based upon a satisfactory stand of turf as defined above. Rejected areas shall be replanted or repaired as directed by the Owner.
- F. Work Schedule: Contractor will supply the Owner's Representative with a proposed schedule of the expected day and time tasks listed below will be performed. This schedule shall be approved prior to project maintenance commencement.

| Item No. | Task Work Item Description | Task Work Item Description | Time Frame |
|----------|------------------------------------|----------------------------|------------|
| 1 | Prune Plants | Once | 4th Month |
| 2 | Mow and Edge Turf | Weekly | |
| 3 | Fertilize Plants | Once | 4th Month |
| 4 | Fertilize Turf | 6 Weeks | |
| 5 | Irrigate Plants | Adjust per Season | |
| 6 | Irrigate Turf | Adjust per Season | |
| 7 | Weed All Areas | 2x Month | |
| 8 | Apply Pre-Emergent Herbicide | Once | 4th Month |
| 9 | Ensure Soil Conditions | Once | 2nd Month |
| 10 | Re-Sod Bare Areas | As Needed | |
| 11 | Insect, Rodent and Disease Control | Monthly | |
| 12 | Granite Areas | Monthly | |
| 13 | Police Site | Mookly | |

- Police Site The frequencies of the tasks stated above are suggested minimums only. During extremely wet or dry periods, the Contractor must adjust schedules to ensure correct and proper conditions are maintained.
- G. After satisfactory completion of the maintenance period, the Owner will assume responsibility for landscape maintenance
- 1.10 SUSPENSION OF MAINTENANCE PERIOD FOR NON-COMPLIANCE
- A. Failure to comply with the specified maintenance requirements, as determined by the Owner's representative, may result in the suspension of the maintenance period until such time as the required remedial actions have been completed by the Contractor. A number of days equal to the number of days of the suspension will be added to the maintenance period.

PART 2 - PRODUCTS

- 2.1 TREE, SHRUB, AND CACTI MATERIAL
- A. General: All Contractor-provided plants used on the project shall be subject to the Owner's review
- B. Plant Form and Quality: All plants shall comply with the project specifications, be normally developed individuals of their species. Provide well-shaped, fully branched, healthy, vigorous stock free of disease, insects, eggs, larvae, and defects such as knots, sun scald, injuries, abrasions, and disfigurement.
- C. Grade: Provide quality, size, genus, species, and variety of plants indicated, complying with applicable requirements in ANSI Z60.1, "American Standard for Nursery Stock" or "Arizona Nurseryman's Association Recommended Average Tree Specifications", whichever is the more stringent. Trees, shrubs, and cacti of a larger size may be used if acceptable to Owner's Representative and at no additional cost to Owner.
- D. Plant Root Systems: All plants shall have healthy root systems. Container-grown plants shall have been in containers for a sufficient time for the root system to hold the soil when the plant is removed from the container, but not long enough for the plant to become root-bound or to cause a hardening of the root system.
- E. Label at least one tree, shrub, and cacti of each variety and caliper with a securely attached, waterproof tag bearing legible designation of botanical and common name.

2.2 TURFGRASS SOD

- A. Turfgrass Sod: Variety shall be as specified on the landscape plans. Turf shall be certified, complying with "Specifications for Turfgrass Sod Materials" in TPI's "Guideline Specifications to Turfgrass Sodding."
- 1. Furnish viable sod of uniform density, color, and texture, strongly rooted, and capable of vigorous growth and
- development when planted. Sod shall be certified and provided in rolls (large in open/flat areas).
- B. Overseeding: As determined by Owner's Representative, sod sod installed during the dormant season of the specified warm-season grass shall be over-seeded with perennial Rye grass to standards normal for the turfgrass industry.
- 2.3 PREPARED PLANTING SOIL MIX FOR TREES, SHRUBS, AND CACTI
- A. Planting Soil Mix: Planting soil shall be native topsoil mixed to a uniform volume and loose measure, with the following soil amendments and fertilizers in the following quantities per cubic yard:
- 1. Trees and Shrubs: 20 cubic feet of (native) topsoil, 7 cubic feet of organic soil conditioner, 2 lbs soil sulfur, 1 lb of fertilizer (16-20-0). The prepared planting soil shall be thoroughly blended prior to placement in plant pits.
- 2. Cacti: Planting soil shall be native topsoil with 0.25 lbs of soil sulfur incorporated into the soil backfill at each cactus. 3. Turf: Verify suitability of proposed soil to produce viable planting soil by taking samples and providing soil sample
- analysis. Remove stones, roots, plants, sod, clods, clay lumps, pockets of coarse sand, concrete slurry, concrete layers or chunks, cement, plaster, building debris, and other extraneous materials harmful to plant growth. Mix surface soil with the required soil amendments and fertilizers to produce a high quality planting soil for sod and seed areas at a depth of 4
- 2.4 FERTILIZER
- A. General Requirements: All fertilizers used on the project shall be in pelleted form and of recent manufacture.
- B. Slow-Release Fertilizer for Tree and Shrub Planting: Ammonium Phosphate consisting of 50 percent water-insoluble nitrogen, and phosphorus in the following composition: 1. Composition: 16 percent nitrogen, 20 percent phosphoric acid by weight.
- 2.5 INERT GROUNDCOVER
- A. Decomposed Granite: Decomposed granite shall be durable granite material size as shown on the plan. Except as may be approved by the Owner's Representative, all materials used on the project shall be from the same source and shall match the approved sample. Decomposed granite shall be free of loam, sand, clay, and other foreign substances. 1. Type: As indicated on plans.
- 2.6 TREE STAKING
- A. Tree Stakes: Tree Stakes shall be 2-inch (minimum) diameter by 8 feet (minimum) long peeled Lodge Pole Pine stakes. Treat with an EPA approved wood preservative. If required to support properly trees used on the project, stakes longer than specified shall be used at no cost to the Owner.
- B. Tie Wire: 12 gauge, annealed, galvanized wire.
- C. Chafing Guard: Biodegradable cotton tree ties with brass eyelet, provided in lengths required to protect tree trunks from damage. Cut tree ties are not acceptable.
- 2.7 HORTICULTURAL CHEMICALS
- A. Pre-Emergent Herbicide: "Surflan" or "Pendulum", or approved equal. Delivered in original, sealed, and fully labeled containers and mixed according to manufacturer's written instructions.
- B. Post-Emergent Herbicide: "Round-Up", or approved equal. Delivered in original, sealed, and fully labeled containers and mixed according to manufacturer's written instructions.
- PART 3 EXECUTION
- 3.1 EXAMINATION
- A. Examine areas to receive plants and decomposed granite for compliance with requirements and conditions affecting installation and performance. Proceed with installation only after unsatisfactory conditions have been corrected.
- 3.2 BLUE STAKING
- A. The Contractor shall have the work area Blue-Staked prior to the start of any excavation work. Blue Staking shall be kept current throughout the course of the work. All utilities damaged by the Contractor shall be repaired or replaced by the Contractor, as required by the Owner or applicable utility company, at the Contractor's expense.
- 3.3 SITE PREPARATION
- A. Protect structures, utilities, sidewalks, pavements and other facilities and existing plants from damage caused by landscape
- B. Provide erosion-control measures to prevent erosion or displacement of soils and discharge of soil-bearing water runoff or airborne dust to adjacent properties and walkways
- C. Lay out individual tree locations. Stake locations, adjust locations when requested, and obtain Owner's Representative's acceptance of layout before planting. Make minor adjustments as required.
- 3.4 TREE AND SHRUB PIT EXCAVATION
- A. Seasonal Limitations: The planting of trees and shrubs may be done at any time selected by the Contractor consistent with the overall project schedule. Planting during excessively hot, cold, or windy weather shall be at the Contractor's risk. Plants that die or are damaged as a result of weather conditions shall be replaced by the Contractor at no additional cost to the Owner.
- B. Excavation of Plant Pits: Excavate circular pits with sides sloped inward, pit size according to the drawings. Do not disturb sub-grade. Scarify sides of plant pit if smeared or smoothed during excavation.
- Subsoil removed from excavations may be amended as specified and used as backfill.
- D. Obstructions: Do not install any plant if a large obstruction is encountered below the rootball. Notify Owner's Representative if unexpected rock or obstructions detrimental to trees, shrubs or cactus are encountered in excavations.
- E. Tests for Drainage: Partially fill plant pits with water and allow water to percolate away. For acceptance, all pits shall drain at least 6" per hour. All pits not draining at 6" per hour shall be deepened or relocated as directed by Owner's Representative. Drainage testing for up to 25 percent of all tree pits shall be performed by the Contractor at no additional cost to the Owner. 1. Deepening Tree Pits: Drill 6-inch diameter holes into free-draining strata or to a depth of ten feet, whichever is less,
 - and backfill with free-draining material. 2. Deepening all tree pits shall be performed by the Contractor at no additional
- 3.5 TREE AND SHRUB PLANTING
- A .Set container-grown stock plumb and in center of pit or trench with top of root ball one inch above adjacent finish grades. Plants that settle shall be excavated and re-planted at correct grade.
- 1. Carefully remove root ball, immediately prior to planting, from container, without damaging root ball, stems or foliage.
- Damaged plants shall be replaced by the Contractor at no additional cost to the Owner. 2. Backfill planting soil mix around root ball in layers, tamping to settle mix and eliminate voids and air pockets. When pit is approximately one-half backfilled, water thoroughly before placing remainder of backfill. Repeat watering until no more water is absorbed. Water again after placing and tamping final layer of planting soil mix.

PLAN NUMBER: 250015 REFERENCE NUMBER: 2500115W OV1204-30 OV1204-30A 2001300 2402389 OV1204-30U OVWU 12-04-25

Contact Arizona 811 at least two full working days before you begin excavati

Call 811 or click Arizona811.com

- 3.6 TREE AND SHRUB PRUNING
- A. Prune, thin, and shape trees and shrubs according to standard horticultural practice. Unless otherwise indicated by Owner's Representative, do not cut tree leaders; remove only injured or dead branches. Prune shrubs to ANA
- Standards to retain natural character. Shrub sizes indicated are sizes after pruning. 1. All dead wood, suckers, broken or bruised branches shall be removed.
- 2. Pruning shall be carried out with clean, sharp tools.
- 3. If, in the opinion of the Owner's Representative, pruning results in a plant not natural in character, the plant shall be replaced by the Contractor at no additional cost to the Owner.
- 3.7 TREE STAKING
- A. Upright Staking and Tying: Stake trees as detailed on the drawings. Use a minimum of 2 stakes of length required to penetrate at least 18 inches below bottom of backfilled excavation and to extend at least 72 inches above grade. Set vertical stakes and space to avoid penetrating root balls or root masses. Support trees with two tree ties at contact points with tree trunk. Allow enough slack to avoid rigid restraint of tree. Use the number of stakes shown on the
 - 1. Staking and tying shall be capable of supporting the plant, without repair, for two years.
- 3.8 PREPARATION OF TURF GRASS AREAS

be completely pulverized by tillage.

A. Subgrade Preparation: Rip or scarify subgrade to a minimum depth of 8 inches. If necessary, make a second pass at 90 degrees to the first. Remove stones larger than one inch in any dimension and sticks, roots, rubbish, and other extraneous matter and legally dispose of them off Owner's property. Rock removal shall be repeated after the irrigation system has been made operational and initial irrigation cycles have been conducted.

1. Apply post-emergent herbicide as directed by the Owner's Representative and according to manufacturer's

- written instructions. 2. Mix soil amendments thoroughly into top 6 inches of soil immediately after application. Till soil to a
- homogeneous mixture of fine texture. 3. In order to prevent settlement following planting of the turf, Contractor shall settle and compact tilled area to approximately 85 percent maximum density. This shall be accomplished by water settling, rolling or other methods necessary to ensure all voids are removed and soil has attained final settlement. Contractor will be


responsible for repairs of any areas that settle following planting operations or during the guarantee period.

- B. Final Physical Nature: Upon completion of the tillage settlement operation and soil plating, the physical nature of the soil shall be such as to permit a water infiltration rate of not less than 0.6 inches per hour. Contractor shall verify this condition has been met. There shall be no sticks or debris, and no soil clods larger than 1 inch following the tillage
- 1. Turf areas shall be filled as needed or have surplus soil removed to attain the proper finished grade. Drainage patterns and finish grades shall be maintained per plan. Turf areas compacted by construction operations shall
- 2. Turf areas shall have debris and stones larger than ½ inch in any dimension removed from the surface, as well as larger stones visible from the surface. Grade planting areas to a smooth, uniform surface plane with loose, uniformly fine texture. Roll and rake,
- remove ridges, and fill depressions to meet finish grades. Limit fine grading to areas that can be planted in the a. Grade to within plus or minus one half of a foot of finish elevation. In field areas the surface shall not vary
- more than 3/4 inch from the bottom edge of a 10 foot straight-edge placed on the prepared surface. b. Softball fields shall be fine graded using laser leveling devices. 4. Irrigate prepared turf areas before planting. Water thoroughly and allow surface to dry before planting. Do not
- 5. Restore areas if eroded or otherwise disturbed after finish grading and before planting.
- 3.9 SODDING
- A. Schedule: Sod that is not overseeded shall be planted after May 25 and before July 15. Overseeded sod may be planted at any time of year that is consistent with the overall project schedule. Sodding of turf grass areas shall not commence until irrigation the turf system is operational.
- B. Lay sod within 24 hours of harvesting. Do not lay sod if dormant or if ground is frozen or muddy.
- C. Lay sod to form a solid mass with tightly fitted joints. Butt ends and sides of sod; do not stretch or overlap. Stagger sod strips or pads to offset joints in adjacent courses. Avoid damage to subgrade or sod during installation. Tamp and roll with a water-filled hand-propelled drum roller to ensure contact with subgrade, eliminate air pockets, and form a smooth surface. Open joints shall be top-dressed with clean sand; remove excess sand to avoid smothering sod and adjacent grass. Irrigate sod immediately after planting. Thereafter keep sod continuously moist until turf is
- 3.8 INORGANIC SURFACING INSTALLATION
- A. Decomposed Granite Surfacing: All areas to be surfaced with decomposed granite shall be brought to the lines and grades shown on the plans, with allowance made for depth of the decomposed granite. Install decomposed granite in accordance with the project drawings.
- 1. A reveal shall be provided adjacent to paved surfaces as shown on the project drawings. Where not detailed, the reveal shall be 3/4 inch.
- 3.9 HORTICULTURAL CHEMICALS
- A. Herbicides: Herbicides shall be applied according to manufacturer's written instructions by an Applicator licensed by
- 3.10 CLEANUP AND PROTECTION
- A. During landscape operations, keep adjacent paving and construction clean and work area in an orderly condition.
- B. Protect all plants and decomposed granite areas from damage due to landscape operations, operations by other contractors and trades, and others. Maintain protection during installation and maintenance periods. Treat, repair, or
- C. Promptly remove soil and debris created by landscape work from paved areas. Clean wheels of vehicles before leaving site to avoid tracking soil onto roads, walks, or other paved areas.
- D. Erect barricades and warning signs as required, to protect newly landscaped areas from traffic.
- 3.11 DISPOSAL
- A. Disposal: Remove surplus soil and waste material, including excess subsoil, unsuitable soil, trash, and debris and trimmings, and dispose of them legally off Owner's property.

LANDSCAPE PLAN ENCANTADA AT ORO VALLEY MARKETPLACE LOTS 1-10 AND A PORTION OF COMMON AREA "A" (OPEN SPACE) OF ORO VALLEY MARKETPLACE

AS RECORDED IN BOOK 64 OF MAPS & PLATS AT PAGE 42 LOCATED IN A PORTION OF SECTION 31 AND 32, TOWNSHIP 11 SOUTH, RANGE 14 EAST

GILA & SALT RIVER MERIDIAN TOWN OF ORO VALLEY, PIMA COUNTY, ARIZONA

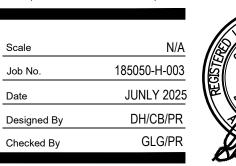

25621 GRIZZLE



Engineering Planning Surveying Landscape Architecture Urban Design Offices located in Tucson, Phoenix and Flagstaff, Arizona, and Las Vegas, Nevada. 4444 East Broadway Tucson, Arizona (520) 881-7480

ENCANTADA AT ORO VALLEY MARKETPLACE 1640 E TANGERINE RD ORO VALLEY. ARIZONA 85737

LANDSCAPE PLAN LANDSCAPE SPECIFICATIONS

Sheet Title

File:Q:\185050\H-003 OVVC Apartments\02 Landscape\06 LP\185050 ovvc encantada L24 LS Specs.dwg

1.1 RELATED DOCUMENTS

- A. Codes and Standards: 1. NFPA 70: National Electric Code
- 2. American Water Works Association (AWWA) for pipe and fitting manufacturer
- 3. American Society for Testing and Materials International (ASTM) for pipe and fitting manufacturer compliance

1.2 SUMMARY

- A. Section Includes:
- 1. Piping. 2. Encasement for piping.
- Manual valves.
- 4. Automatic control valves.
- 5. Transition fittings.
- 6. Miscellaneous piping specialties.
- 7. Quick couplers.
- 8. Drip irrigation specialties.
- 9. Controllers.
- 10. Boxes for automatic control valves.
- 11. Backflow Preventer. 12. Evapo-transpiration Sensor or Weather Station.

1.3 DEFINITIONS

- A. Circuit Piping: Downstream from control valves to sprinklers, specialties, and drain valves. Piping is under pressure during flow.
- B. Drain Piping: Downstream from circuit-piping drain valves. Piping is not under
- C. Main Piping: Downstream from point of connection to water distribution piping to, and including, control valves. Piping is under water-distribution-system pressure.

1.4 PERFORMANCE REQUIREMENTS

- A. Irrigation zone control shall be automatic operation with controller and automatic
- B. Location of Emission Devices and Specialties: It is hereby specified that the system shall be complete and fully operational covering 100% of the planted area.
- C. Minimum Working Pressures: The following are minimum pressure requirements for piping, valves, and specialties, unless otherwise indicated:
- 1. Minimum Pressure at drip emission devices: 15 psi.
- 2. Minimum pressure at spray heads shall be per manufacturer's recommendations.

1.5 CLOSEOUT SUBMITTALS

- A. As-built Drawings: Document the piping sizes and layout, each zone, zone type, number of heads in each zone, note emitter spacing. In addition closeout submittals should include:
 - Controller Keys.
- Controller manual Quick Coupler key.
- As-built drawings.
- Submit 2 copies; one 11"x17" laminated copy, one full-sized copy. Submit
- one electronic copy in .pdf format
- Controller schedule
- Backflow preventer test certificate.
- Warranty documents for the irrigation system Backflow preventer enclosure keys.

1.6 DELIVERY, STORAGE, AND HANDLING

- A. Store plastic piping protected from direct sunlight. Support to prevent sagging and
- 1.7 PROJECT CONDITIONS
- A. Interruption of Existing Water Service: Do not interrupt water service to facilities occupied by Owner or others unless permitted under the following conditions and then only after arranging to provide temporary water service according to requirements
- 1. Notify Owner's Representative no fewer than two (2) days in advance of proposed
- interruption of water service. 2. Do not proceed with interruption of water service without Owner's Representative's
- 1.8 MAINTENANCE SERVICE
- A. Initial Maintenance Service: Provide full maintenance by skilled employees of irrigation installer. Maintain as required in Part 3. Begin maintenance immediately after each area is planted and continue until not less than the following period:
- 1. Maintain until 30 days after handover and approved at "30 Day Walk."

1.9 WARRANTY

A. Special Warranty: Installer agrees to repair or replace irrigation and accessories tha fail in materials or workmanship within on-year warranty period.

PART 2-PRODUCTS

2.1 PIPES, TUBES, AND FITTINGS

- A. Comply with requirements for applications of pipe, tube, and fitting materials, and for
- joining methods for specific services, service locations, and pipe sizes.
- B. PVC Pipe: ASTM D 1785, PVC 1120 compound, Schedule 40. 1. PVC Socket Fittings: ASTM D 2466, Schedule 40.
 - 2. PVC Threaded Fittings: ASTM D 2464, Schedule 80.
 - 3. PVC Socket Unions: Construction similar to MSS SP-107, except both headpiece and tailpiece shall be PVC with socket ends.

2.2 PIPING JOINING MATERIALS

- Solvent Cements for Joining PVC Piping: ASTM D 2564. Include primer according to
- Plastic, Pipe-Flange Gasket, Bolts, and Nuts: Type and material recommended by piping system manufacturer unless otherwise indicated.
- 2.3 ISOLATION VALVES

Isolation Valves shall be as indicated on the irrigation plans.

- 2.4 AUTOMATIC CONTROL VALVES
- A. Automatic Circuit Control Valves shall be as indicated on the irrigation plans.
- 2.5 TRANSITION FITTINGS
- A. General Requirements: Same size as, and with pressure rating at least equal to and with ends compatible with, piping to be joined. Provide products compatible with piping, valves, heads and controllers for proposed system which conform to standards of practice.
- 2.6 SPRINKLERS
- A. Sprinklers shall be as indicated on the irrigation plans.
 - 1. Install for uniform "Head to Head" coverage over entire spray area indicated.
- 2.7 QUICK COUPLERS
- A. Quick-Coupling Valves shall be as indicated on the irrigation plans.
- 2.8 DRIP IRRIGATION SPECIALTIES
- A. Drip Tubes:
- 1. Tubing:
 - a. Body Material: PE or vinyl.
 - b. Mounting: On riser, inserted into lateral line at set intervals.
- . Capacities and Characteristics: As indicated on the irrigation plans.
- B. Emission Device:
- Emitter: As indicated on Irrigation Plans.
- C. Off-Ground Supports: Plastic stakes.
- D. Application Pressure Regulators: Brass or plastic housing, NPS ¾, with corrosion-resistant internal parts; capable of controlling outlet pressure to approximately 30 psig.
- E. Filter Units: Brass or plastic housing, with corrosion-resistant internal parts; of size and capacity required for devices downstream from unit.
- Air Relief Valves: Brass or plastic housing, with corrosion-resistant internal parts.
- G. Vacuum Relief Valves: Brass or plastic housing, with corrosion-resistant internal parts.
- 2.9 CONTROLLERS
- A. Controller shall be as indicated on the irrigation plans.
- 1. Provide 2 spare unused controller zones. Provide expansion modules as
- necessary to operate number of valves indicated on irrigation plans.
- Mount at location indicated on the irrigation plans.
- 2.10 BOXES FOR AUTOMATIC CONTROL VALVES AND FLUSH ENDS
- A. Plastic Boxes shall be as indicated on the irrigation plans. Description: Box and cover, with open bottom and openings for piping; designed for installing flush with grade. 1. Size: 10" Round-Isolation Valve: "Jumbo" Rectangular-Control Valve. One Valve
- 2. Shape: Round and Rectangular. 3. Sidewall Material: PE.
- 4. Cover Material: PE.
- 5. Lettering: Irrigation Valve Box.
- 2.11 BACKFLOW PREVENTER
- A. Provide backflow preventer on concrete pad in lockable enclosure as indicated on the
 - a. Provide R-30 Insulation cover.
- 2.12 WEATHER SENSOR
 - 1. Weather Sensor shall be as indicated on the irrigation plans.

PART 3 - EXECUTION

3.1 EARTHWORK

- A. Install warning tape directly above pressure piping, 12 inches below finished grades, except 6 nches below subgrade under pavement and slabs.
- Provide minimum cover over top of underground piping according to the following:
- 1. Irrigation Main Piping: Minimum depth of 18 inches
- 2 Circuit Piping: 12 inches.
- 3. Drain Piping: 12 inches. 4. Sleeves: 24 inches.
- 3.2 PREPARATION
- A. Set stakes to identify locations of proposed irrigation system. Obtain Owner's Representative's approval before excavation. Notify Owner's Representative of any conflicts prior to installation.
- 3.3 PIPING INSTALLATION
- A. Location and Arrangement: Drawings indicate location and arrangement of piping systems.
- Install piping at minimum uniform slope of 0.5 percent down toward drain valves.
- Install piping free of sags and bends.
- Install group of pipes parallel to each other, spaced to permit valve servicing.
- Install fittings for changes in direction and branch connections.
- Install unions adjacent to valves and to final connections to other components with NPS 2 or
- smaller pipe connection. G. Install flanges adjacent to valves and to final connections to other components with NPS 2-1/2
- or larger pipe connection. H. Install expansion loops in control-valve boxes for plastic piping.
- Lay piping on solid sub-base, uniformly sloped without humps or depressions.
- Install PVC piping in dry weather when temperature is above 40 deg F. Allow joints to cure at least 24 hours at temperatures above 40 deg F before testing.
- K. Install pressure regulators with shutoff valve and strainer on inlet and pressure gauge on outlet. nstall shutoff valve on outlet. Install aboveground or in control-valve boxes.
- Install piping in sleeves under parking lots, roadways, and sidewalks. M. Install sleeves made of 4" Schedule 40 PVC pipe and socket fittings, and solvent-cemented
- N. Install transition fittings for plastic-to-metal pipe connections according to the following:
- 1. Underground Piping:
- a. NPS 1-1/2 and Smaller: Plastic-to-metal transition fittings. b. NPS 2 and Larger: AWWA transition couplings.
- 2. Aboveground Piping (Not permitted in markets of freezing environments):
- a. NPS 2 and Smaller: Plastic-to-metal transition fittings and unions. b. NPS 2 and Larger: Use dielectric flange kits with one plastic flange.
- 3.4 JOINT CONSTRUCTION
- A. Ream ends of pipes and tubes and remove burrs. Bevel plain ends of steel pipe. B. Remove scale, slag, dirt and debris from inside and outside of pipe and fittings before assembly.
- C. PVC Piping Solvent-Cemented Joints: Clean and dry joining surfaces. Join pipe and fittings according to the following:
- 1. Comply with ASTM F 402 for safe-handling practice of cleaners, primers, and solvent 2. PVC Pressure Piping: Join schedule number, ASTM D 1785, PVC pipe and PVC socket fittings according to ASTM D 2672. Join other-than-schedule-number PVC pipe and socket
- fittings according to ASTM D 2855. 3. PVC Non-pressure Piping: Join according to ASTM D 2855.

3.5 VALVE INSTALLATION

- A. Valve (All) Location: 1. Valve and Control Boxes must be a minimum 3' behind face of curb or sidewalk.
- 2. Top of all Irrigation Boxes must be at grade or slightly above. Above-ground Valves: Install as components of connected piping system.
- 3.6 SPRINKLER INSTALLATION
- Install sprinklers after hydrostatic test is completed. Install sprinklers plumb and flush with finish grade as indicated in the Irrigation Plans.
- Compact soil around heads. Re-adjust to be plumb and flush after installation. Locate part-circle sprinklers to maintain a minimum distance of six inches from walls, header, sidewalk and other boundaries unless otherwise indicated.
- 3.7 DRIP IRRIGATION SPECIALTY INSTALLATION
- Install freestanding emitters on pipe riser to mounting height indicated. Install manifold emitter systems with tubing to emitters. Plug unused manifold outlets. Install
- Install multiple-outlet emitter systems with tubing to outlets. Plug unused emitter outlets. nstall outlets on off-ground supports at height indicated.

emitters on off-ground supports at height indicated.

- Install drip tubes with direct-attached emitters on in 6" round valve boxes.
- Install drip tubes with remote-discharge in 6" round valve boxes. with outlets on off-ground supports at height indicated. Install off-ground supports of length required for indicated mounted height of device.

Install drip assembly pressure regulator and filter below grade in a 10" round valve box as

shown on the detail. Locate within 2' of the electronic control valve.

3.8 AUTOMATIC IRRIGATION-CONTROL SYSTEM INSTALLATION

- A. Equipment Mounting: Install interior controllers in Low Voltage Cabinet.
- 1. Place and secure anchorage devices. Use setting drawings, templates, diagrams, instructions, and directions furnished with items to be embedded. 2. Install anchor bolts to elevations required for proper attachment to supported equipment. B. Install control wire in same trench as irrigation piping and at least 2 inches beside piping.

Provide conductors of size not smaller than recommended by controller manufacturer. Install

PLAN NUMBER: 250015 REFERENCE NUMBER: OV1204-30 2500115W OV1204-30A 2001300 2402389 OV1204-30U

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No. Date


ENCANTADA AT ORO VALLEY MARKETPLACE LOTS 1-10 AND A PORTION OF COMMON AREA "A" (OPEN SPACE) OF ORO VALLEY MARKETPLACE AS RECORDED IN BOOK 64 OF MAPS & PLATS AT PAGE 42

LANDSCAPE PLAN

LOCATED IN A PORTION OF SECTION 31 AND 32, TOWNSHIP 11 SOUTH, RANGE 14 EAST **GILA & SALT RIVER MERIDIAN** TOWN OF ORO VALLEY, PIMA COUNTY, ARIZONA

DH/CB/PR

GLG/PR

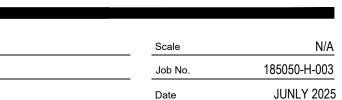

Designed By

Checked By

25621 GRIZZLE

Engineering Planning Surveying Landscape Architecture Urban Design Offices located in Tucson, Phoenix and Flagstaff, Arizona, and Las Vegas, Nevada. 4444 East Broadway Гucson, Arizona (520) 881-7480

ENCANTADA AT ORO VALLEY MARKETPLACE 1640 E TANGERINE RD ORO VALLEY, ARIZONA 85737

LANDSCAPE PLAN IRRIGATION SPECIFICATIONS

Sheet Title

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cable in separate sleeve under paved areas.

and automatic control valves to confirm proper system operation. 3. Test and adjust controls and safeties. Replace damaged and malfunctioning

retest until no leaks exist.

controls and equipment.

A. Perform startup service. 1. Complete installation and startup checks according to manufacturer's written

B. Any irrigation product will be considered defective if it does not pass tests and

A. Drawings indicate general arrangement of piping, fittings, and specialties.

C. Connect wiring between controllers and automatic control valves.

B. Install piping adjacent to equipment, valves, and devices to allow service and

1. Leak Test: After installation, charge system and test for leaks. Repair leaks and

2. Operational Test: After electrical circuitry has been energized, operate controllers

2. Verify that controllers are installed and connected according to the Contract

3. Verify that electrical wiring installation complies with manufacturer's submittal.

3.12 ADJUSTING

3.9 CONNECTIONS


3.10 FIELD QUALITY CONTROL


A. Tests and Inspections:

inspections.

3.1 START UP SERVICE

- A. Adjust settings of controllers.
- B. Adjust automatic control valves to provide flow rate at rated operating pressure required for each irrigation circuit.
- C. Adjust devices, except those intended to be mounted aboveground, so they will be flush with finish grade.
- 3.13 CLEANING
- A. Flush dirt and debris from piping before installing emission devices.
- 3.14 DEMONSTRATION
- A. Coordinate an operating demonstration and acceptance meeting with Owner's Representative.

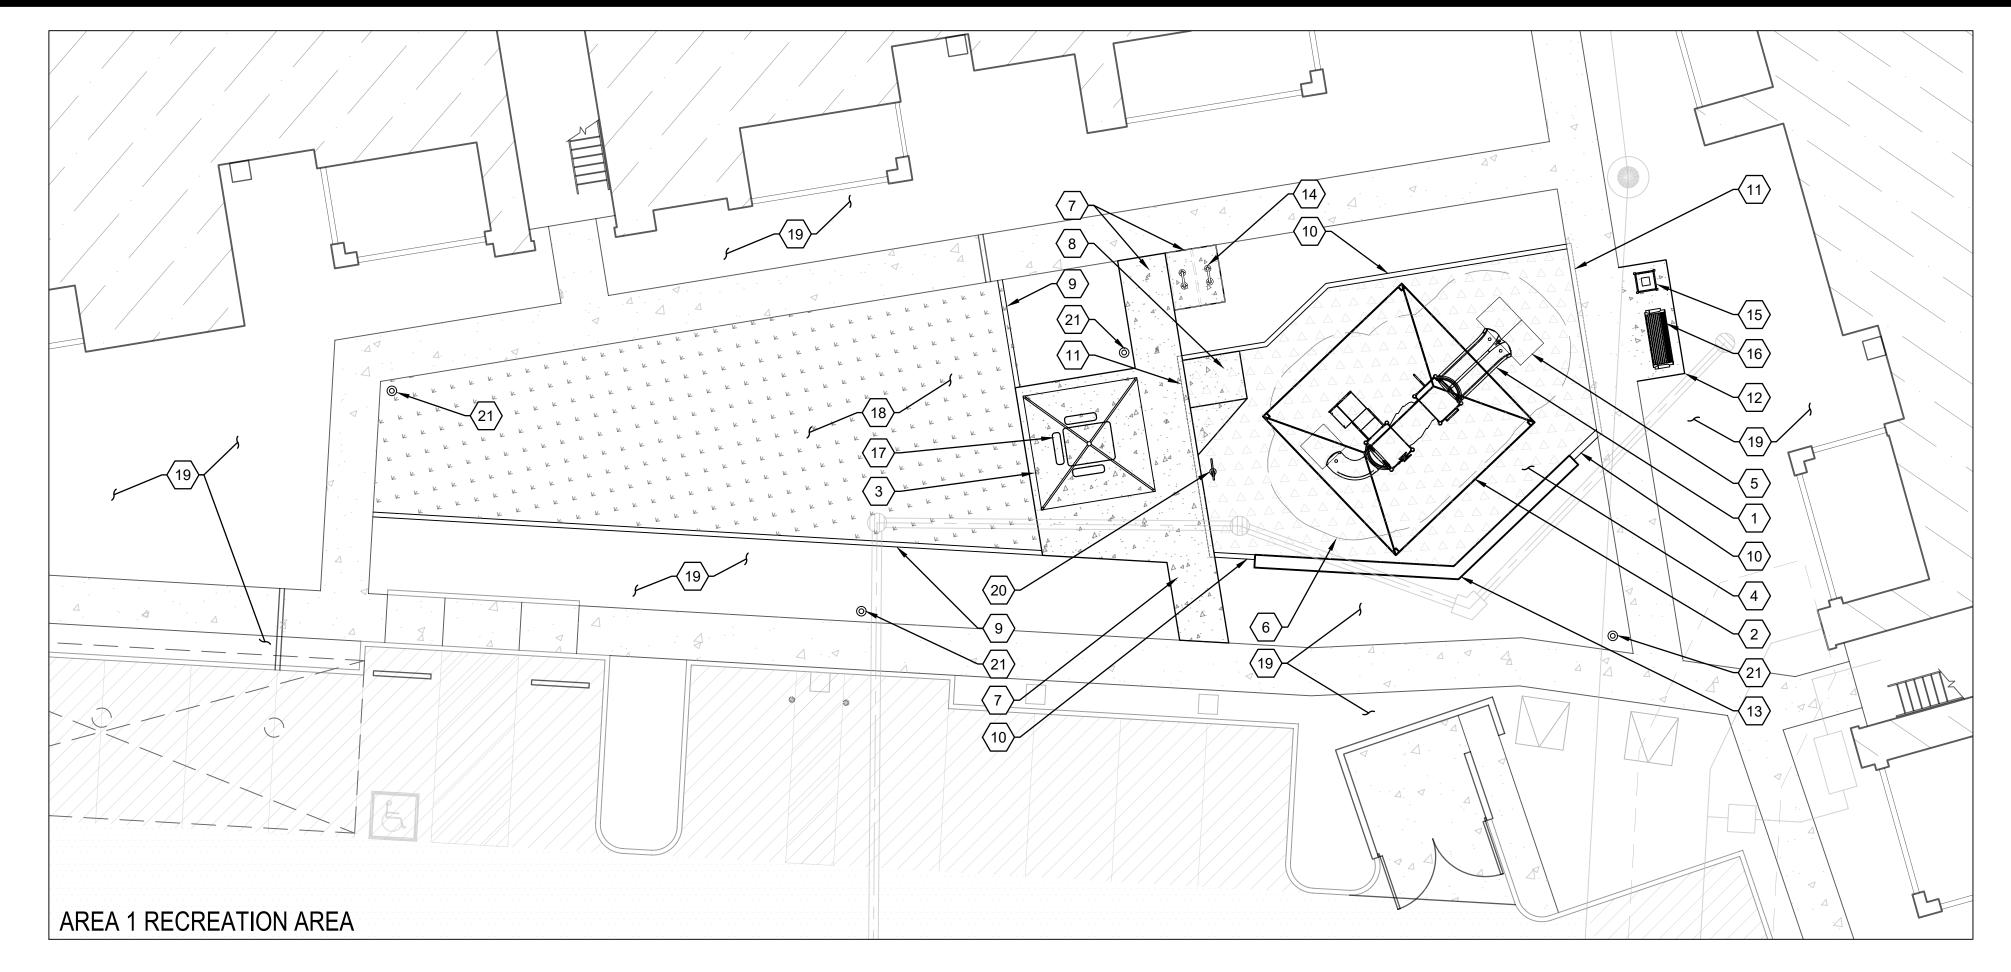

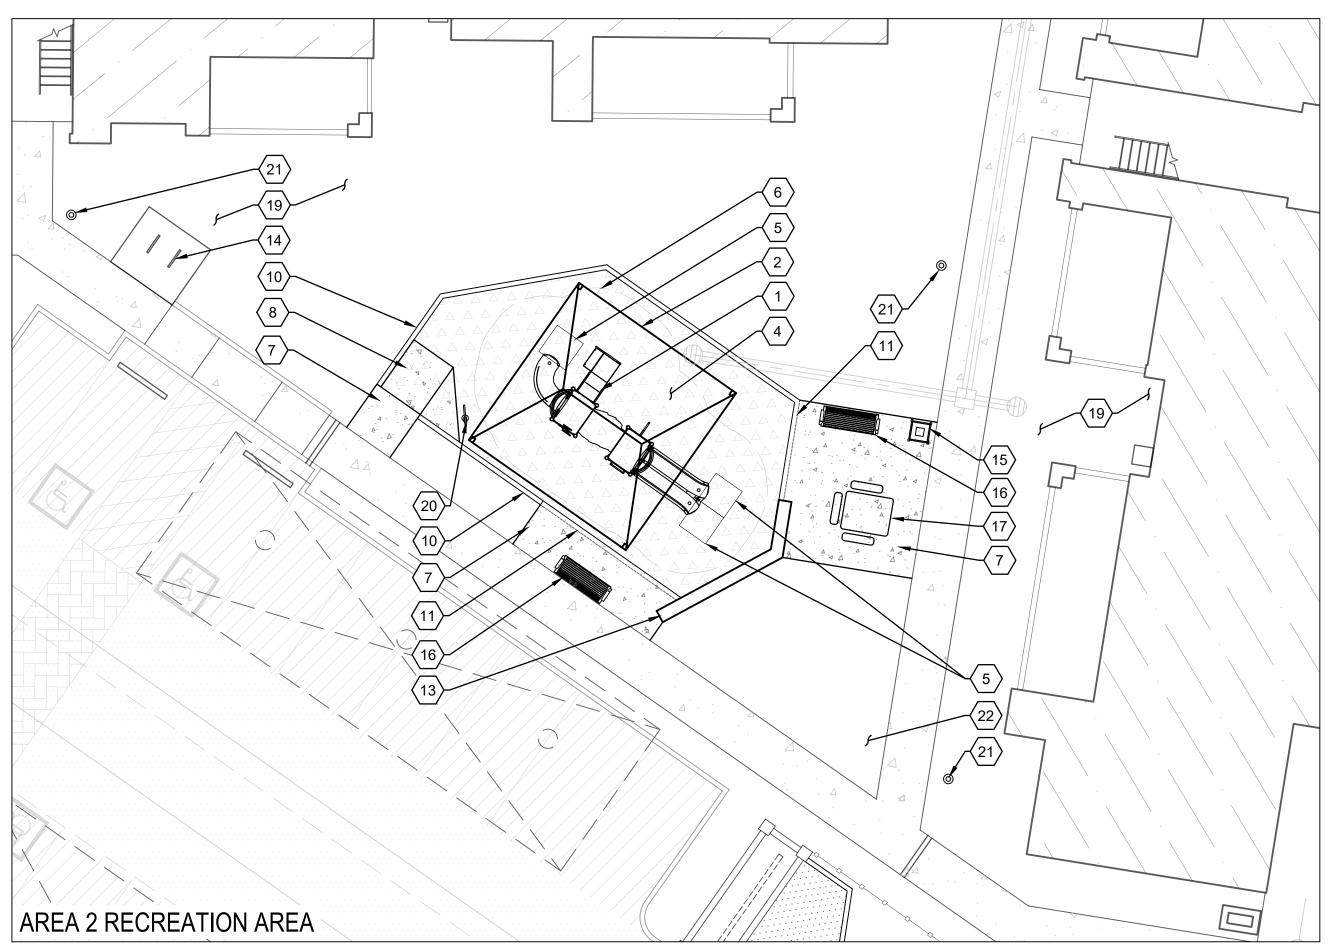



1 PLAY EQUIPMENT: SUPERIOR RECREATIONAL PRODUCTS #PS3-31747 (2-12 YEARS) POSTS: "BLUE", METAL: "GREEN", PANELS: "SKY BLUE", DECKS: "BROWN", PLASTICS: "RED". COORDINATE WITH MANUFACTURER TO ENSURE CORRECT FALL ZONES AND ADA ACCESSIBILITY. AVAILABLE FROM AMERICAN PLAY SYSTEMS - CONTACT: MARIA SMITH [maria@americanplaysystems.com]

PLAYGROUND SHADE STRUCTURE:

SHADE' N' NET 20' X 20' HIP POSTS: DARK BRONZE FABRIC COLOR: DESERT SAND (TAN) COORDINATE WITH MANUFACTURER TO ENSURE CORRECT FALL ZONES AND ADA ACCESSIBILITY. $\frac{29}{29}$ IN-GROUND MOUNT PER MANUFACTURER'S RECOMMENDATIONS AVAILABLE FROM AMERICAN PLAY SYSTEMS - CONTACT: MARIA SMITH [maria@americanplaysystems.com]

AVAILABLE FROM AMERICAN PLAY SYSTEMS - CONTACT: MARIA SMITH [maria@americanplaysystems.com]

SUPERIOR RECREATIONAL PRODUCTS SQR-12' X 12' STANDARD STEEL RAMADA POST: BRONZE, ROOF COLOR: SURREY BEIGE (TAN) POST: BRONZE, ROOF COLOR: SURREY BEIGE (TAN) SURFACE-MOUNT PER MANUFACTURER'S RECOMMENDATIONS FOOTINGS BY STRUCTURAL ENGINEER

ENGINEERED WOOD FIBER SAFETY SURFACE: "WOODCARPET SYSTEM 1". MUST MEET ASTM 2075-04 & ASTM #F1292 FOR 15 YEARS 12" MINIMUM DEPTH INSTALL PER MANUFACTURER'S RECOMMENDATIONS AVAILABLE FROM ZEAGER BROTHERS.

WEAR MAT: SUPERIOR RECREATIONAL PRODUCTS # WM-05 BEVELED MAT 40" X 40" (OR EQUAL) AT SLIDE EXITS. INSTALL PER MANUFACTURER'S RECOMMENDATIONS

AVAILABLE FROM AMERICAN PLAY SYSTEMS 6 USE ZONE:

CONTRACTOR SHALL ENSURE USE ZONE IS COMPLETELY WITHIN SAFETY SURFACE AREA WITH NO OBSTRUCTIONS. CONCRETE PAVING: 3/8" EXPOSED AGGREGATE FINISH PER PAG STD. DTL. #200, MODIFIED 4" THICK, COMPACT SUBGRADE PER GEOTECHNICAL REPORT.

CONCRETE ACCESS RAMP: 3/8" EXPOSED AGGREGATE FINISH $\frac{5}{33}$ CONCRETE HEADER (6" X 6") $\frac{6}{33}$

CONCRETE PLAYGROUND HEADER (6" X 18") $\left(\frac{2}{33}\right)$

CONCRETE PAVING TURN DOWN AT PLAYGROUND $\frac{1}{33}$ CONCRETE BENCH PAD 3/8" EXPOSED AGGREGATE FINISH $(\frac{5}{32})$

BICYCLE PARKING (4 BIKES): LOOP BIKE RACK 83 SERIES, DUMOR, INC, 800-598-4018 OR OWNER - APPROVED EQUIVALENT. EARTH - TONE COLOR INSTALL PER MANUFACTURER'S RECOMMENDATIONS.

SEE CIVIL PLANS FOR DETAIL. TRASH RECEPTACLE: WABASH # YO3F33C, YORKTOWN RECEPTACLE - SLAT (OR EQUAL)
SURFACE MOUNT PER MANUFACTURER'S RECOMMENDATIONS COLOR: TEXTURED BLACK AVAILABLE FROM DAVE BANG ASSOCIATES - CONTACT: TREVIN MACLAY

WABASH VALLEY #WO1119S, 6' BENCH WITH BACK AND ARMS (OR EQUAL) HORIZONTAL SLAT - SM COLOR: TEXTURED BLACK

AVAILABLE FROM DAVE BANG ASSOCIATES PICNIC TABLE: PREMIER POLYSTEEL #927-IP-1 4' X 5' ADA ACCESSIBLE FREESTANDING TABLE AND BENCHES (OR EQUAL) $\left(\frac{8}{32}\right)$ PERFORATED PATTERN COLOR: DARK BRONZE

AVAILABLE FROM PREMIER POLYSTEEL (18) GRASS PER PLANTING LEGEND

DECOMPOSED GRANITE/ DECORATIVE ROCK PER LANDSCAPE LEGEND

AGE-APPROPRIATE SIGN - BY PLAY EQUIPMENT MANUFACTURER

BOLLARD LIGHT-SEE CIVIL PLANS

(22) SYNTHETIC TURF $(\frac{7}{33})$

LANDSCAPE PLAN ENCANTADA AT ORO VALLEY MARKETPLACE LOTS 1-10 AND A PORTION OF COMMON AREA "A" (OPEN SPACE)

OF ORO VALLEY MARKETPLACE

AS RECORDED IN BOOK 64 OF MAPS & PLATS AT PAGE 42 LOCATED IN A PORTION OF SECTION 31 AND 32, TOWNSHIP 11 SOUTH, RANGE 14 EAST GILA & SALT RIVER MERIDIAN TOWN OF ORO VALLEY, PIMA COUNTY, ARIZONA



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ENCANTADA AT ORO VALLEY MARKETPLACE 1640 E TANGERINE RD ORO VALLEY, ARIZONA 85737

Sheet Title LANDSCAPE PLAN PLAYGROUND SITE PLAN File:Q:\185050\H-003 OVVC Apartments\02 Landscape\06 LP\185050 ovvc encantada L26 Playground.dwg

PLAN NUMBER: 250015

REFERENCE NUMBER:

2500115W 2001300


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OV1204-30 OV1204-30A


OV1204-30U OVWU 12-04-25

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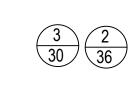


DOG PARK KEYNOTES


1 DOG ELEMENT: "LEASH POST" BY GYMS FOR DOGS, OR APPROVED EQUAL IN-GROUND-MOUNT PER MANUFACTURER'S RECOMMENDATIONS. AVAILABLE FROM GYMS FOR DOGS [gyms for dogs.com]

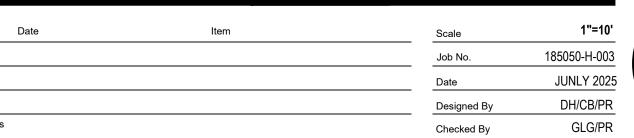

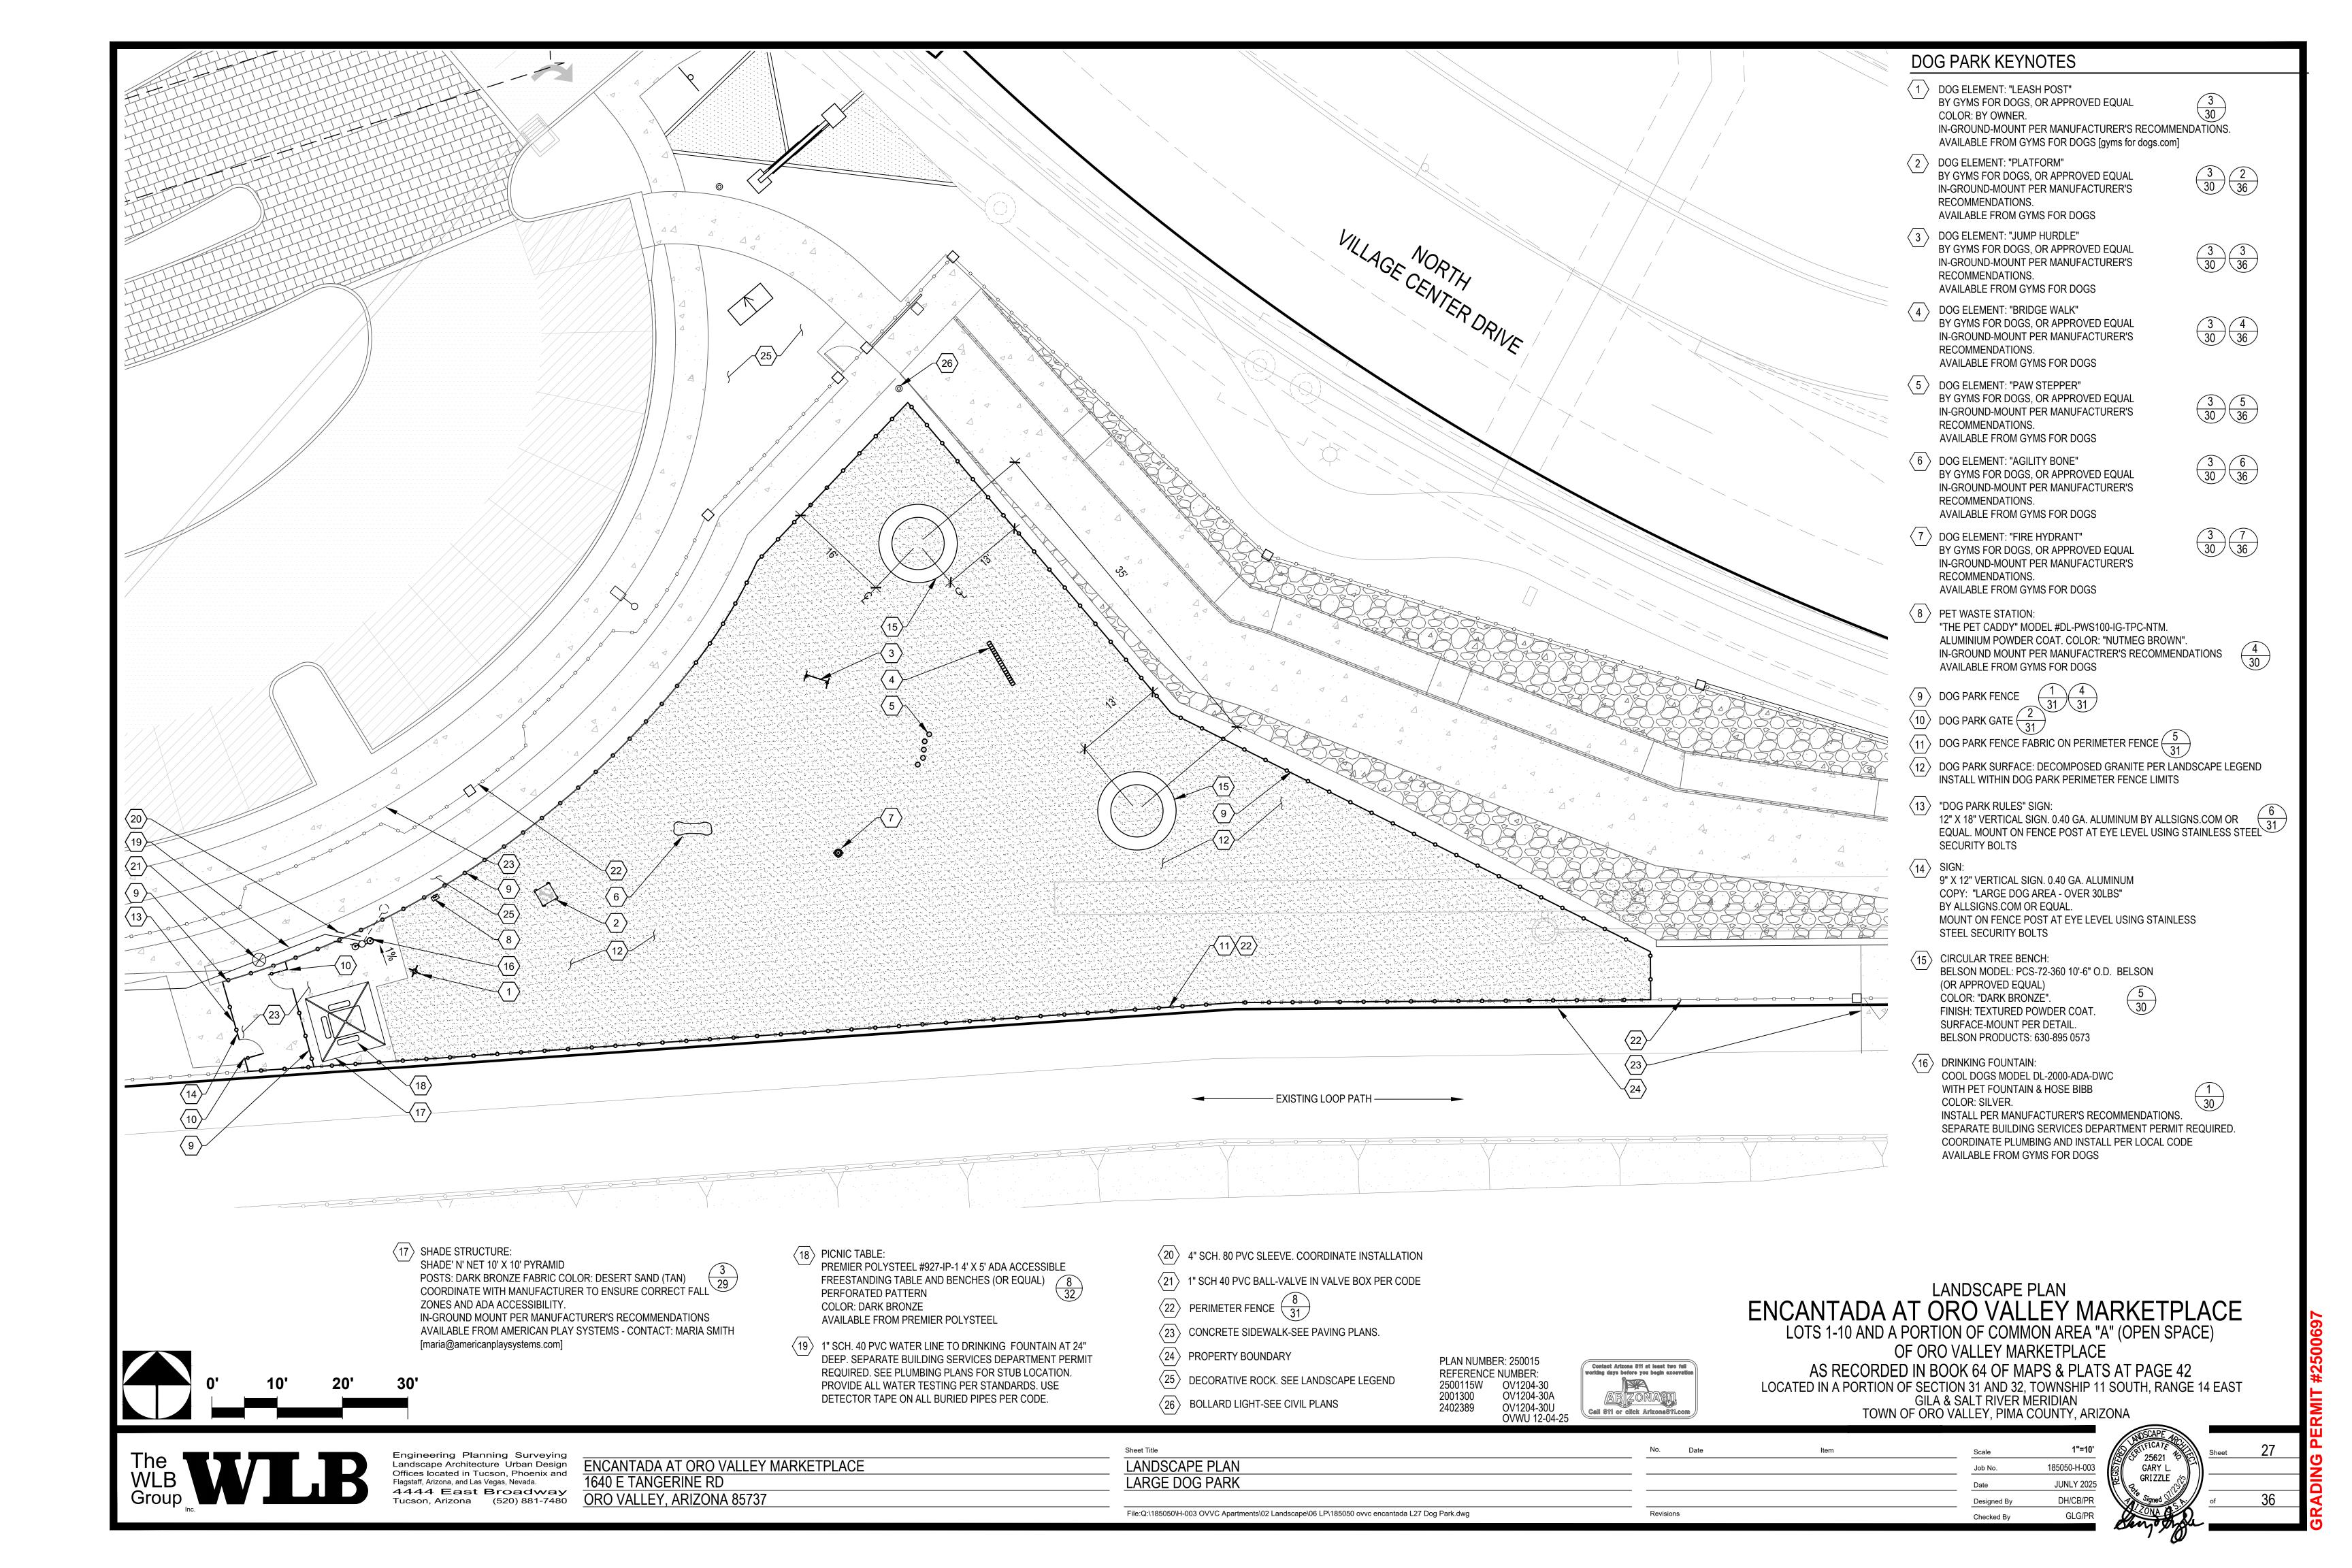
2 DOG ELEMENT: "PLATFORM" BY GYMS FOR DOGS, OR APPROVED EQUAL IN-GROUND-MOUNT PER MANUFACTURER'S RECOMMENDATIONS. AVAILABLE FROM GYMS FOR DOGS



3 DOG ELEMENT: "JUMP HURDLE" BY GYMS FOR DOGS, OR APPROVED EQUAL IN-GROUND-MOUNT PER MANUFACTURER'S RECOMMENDATIONS. AVAILABLE FROM GYMS FOR DOGS

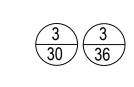

4 DOG ELEMENT: "PAW STEPPER" BY GYMS FOR DOGS, OR APPROVED EQUAL COLOR: BY OWNER. IN-GROUND-MOUNT PER MANUFACTURER'S RECOMMENDATIONS. AVAILABLE FROM GYMS FOR DOGS

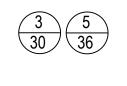

PET WASTE STATION: "THE PET CADDY" MODEL #DL-PWS100-IG-TPC-NTM. ALUMINIUM POWDER COAT. COLOR: "NUTMEG BROWN". IN-GROUND MOUNT PER MANUFACTRER'S RECOMMENDATIONS AVAILABLE FROM GYMS FOR DOGS



31

 $\langle 6 \rangle$ DOG PARK FENCE



8 DOG PARK SURFACE: DECOMPOSED GRANITE PER LANDSCAPE LEGEND INSTALL WITHIN DOG PARK PERIMETER FENCE LIMITS

9 "DOG PARK RULES" SIGN: 12" X 18" VERTICAL SIGN. 0.40 GA. ALUMINUM BY ALLSIGNS.COM OR EQUAL. MOUNT ON FENCE POST AT EYE LEVEL USING STAINLESS STEEL SECURITY BOLTS

 $\langle 10 \rangle$ SIGN: 9" X 12" VERTICAL SIGN. 0.40 GA. ALUMINUM COPY: "SMALL DOG AREA - UNDER 30LBS" BY ALLSIGNS.COM OR EQUAL MOUNT ON FENCE POST AT EYE LEVEL USING STAINLESS STEEL SECURITY BOLTS

 $\langle 10 \rangle$ (NOT USED)

 $\langle 12 \rangle$ DRINKING FOUNTAIN: COOL DOGS MODEL DL-2000-ADA-DWC WITH PET FOUNTAIN & HOSE BIBB COLOR: SILVER. INSTALL PER MANUFACTURER'S RECOMMENDATIONS SEPARATE BUILDING SERVICES DEPARTMENT PERMIT REQUIRED. COORDINATE PLUMBING AND INSTALL PER LOCAL CODE AVAILABLE FROM GYMS FOR DOGS

(13) SHADE STRUCTURE: SHADE' N' NET 10' X 10' PYRAMID POSTS: DARK BRONZE FABRIC COLOR: DESERT SAND (TAN) COORDINATE WITH MANUFACTURER TO ENSURE CORRECT FALL ZONES AND ADA ACCESSIBILITY. IN-GROUND MOUNT PER MANUFACTURER'S RECOMMENDATIONS AVAILABLE FROM AMERICAN PLAY SYSTEMS - CONTACT: MARIA SMITH [maria@americanplaysystems.com]

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14 PICNIC TABLE: PREMIER POLYSTEEL #927-IP-1 4' X 5' ADA ACCESSIBLE FREESTANDING TABLE AND BENCHES (OR EQUAL)

PERSONATED PATTERN

8
32 COLOR: DARK BRONZE AVAILABLE FROM PREMIER POLYSTEEL

PLAN NUMBER: 250015

REFERENCE NUMBER:

2500115W 2001300

2402389

OV1204-30 OV1204-30A

OV1204-30U OVWU 12-04-25

 $\langle 15 \rangle$ 1" SCH. 40 PVC WATER LINE TO DRINKING FOUNTAIN AT 24" DEEP. SEPARATE BUILDING SERVICES DEPARTMENT PERMIT REQUIRED. SEE PLUMBING PLANS FOR STUB LOCATION. PROVIDE ALL WATER TESTING PER STANDARDS. USE DETECTOR TAPE ON ALL BURIED PIPES PER CODE.

16 DRINKING FOUNTAIN DRAINAGE SUMP 1

(17) 1" SCH 40 PVC BALL-VALVE IN VALVE BOX PER CODE

4" SCH. 80 PVC SLEEVE. COORDINATE INSTALLATION

(19) CONCRETE SIDEWALK-SEE PAVING PLANS.

20 PROPERTY BOUNDARY

21 DECORATIVE ROCK: SEE LANDSCAPE LEGEND

 $\langle 22 \rangle$ PERIMETER FENCE-SEE ALSO ARCHITECTURAL PLANS $\begin{pmatrix} 8 \\ 31 \end{pmatrix}$

LANDSCAPE PLAN

ENCANTADA AT ORO VALLEY MARKETPLACE

LOTS 1-10 AND A PORTION OF COMMON AREA "A" (OPEN SPACE)

OF ORO VALLEY MARKETPLACE

AS RECORDED IN BOOK 64 OF MAPS & PLATS AT PAGE 42 LOCATED IN A PORTION OF SECTION 31 AND 32, TOWNSHIP 11 SOUTH, RANGE 14 EAST GILA & SALT RIVER MERIDIAN TOWN OF ORO VALLEY, PIMA COUNTY, ARIZONA

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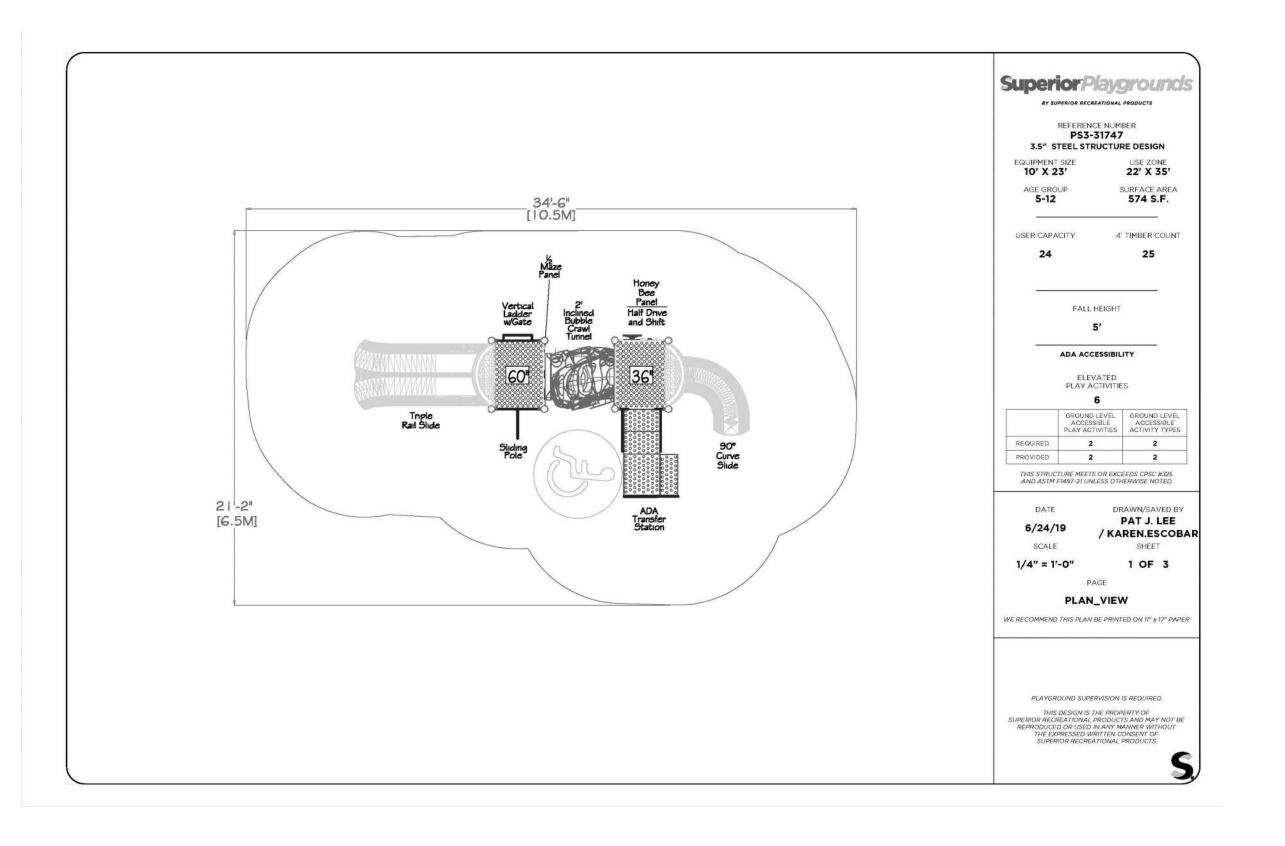
ENCANTADA AT ORO VALLEY MARKETPLACE 1640 E TANGERINE RD ORO VALLEY, ARIZONA 85737


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185050-H-003 Job No. **JUNLY 2025** DH/CB/PR GLG/PR Checked By









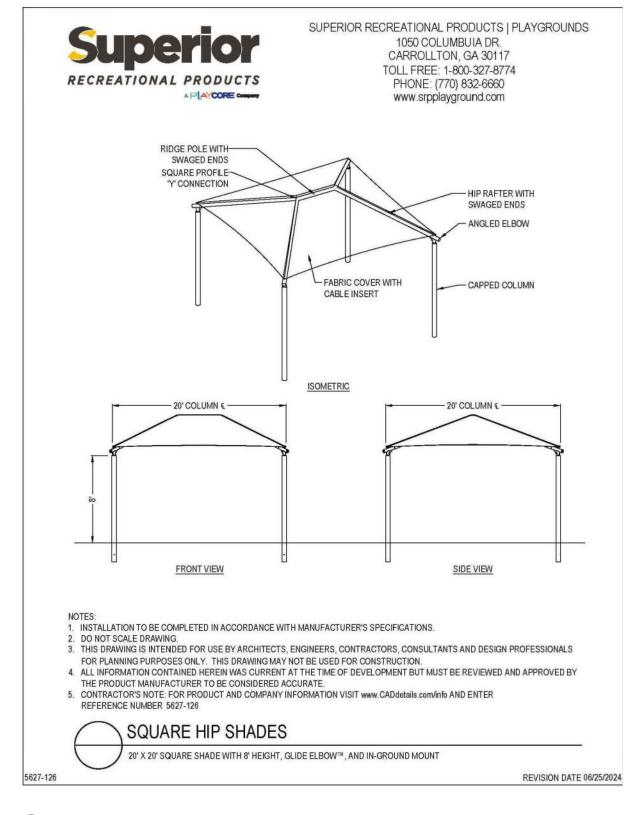


\ PLAY STRUCTURE (TWO)

PLAY SHADE STRUCTURE

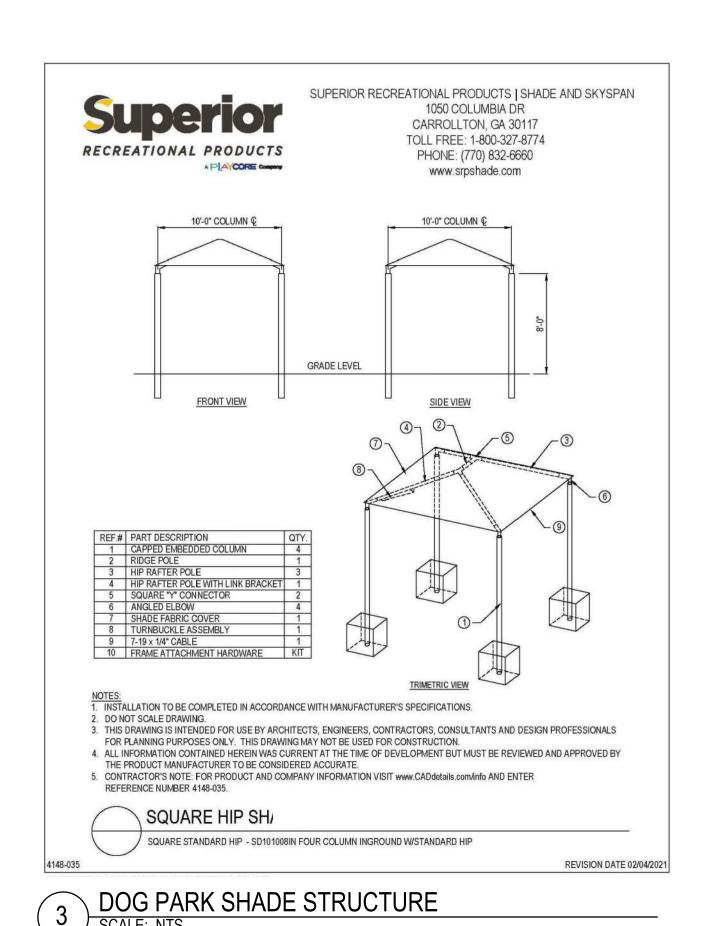

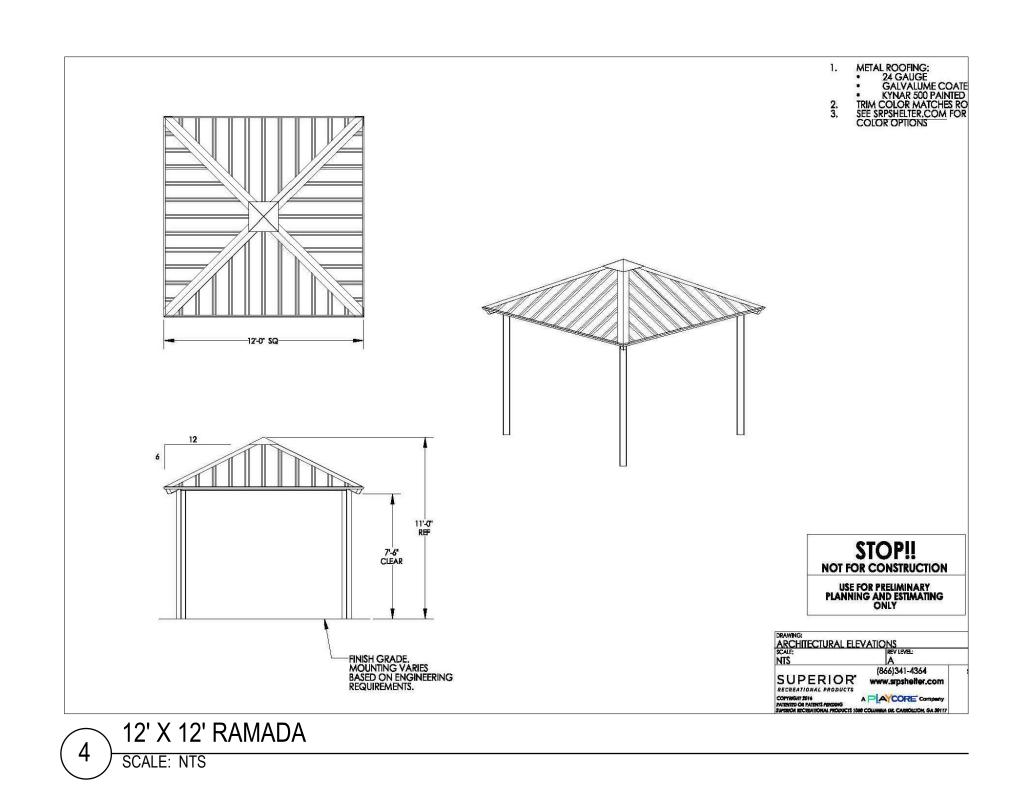

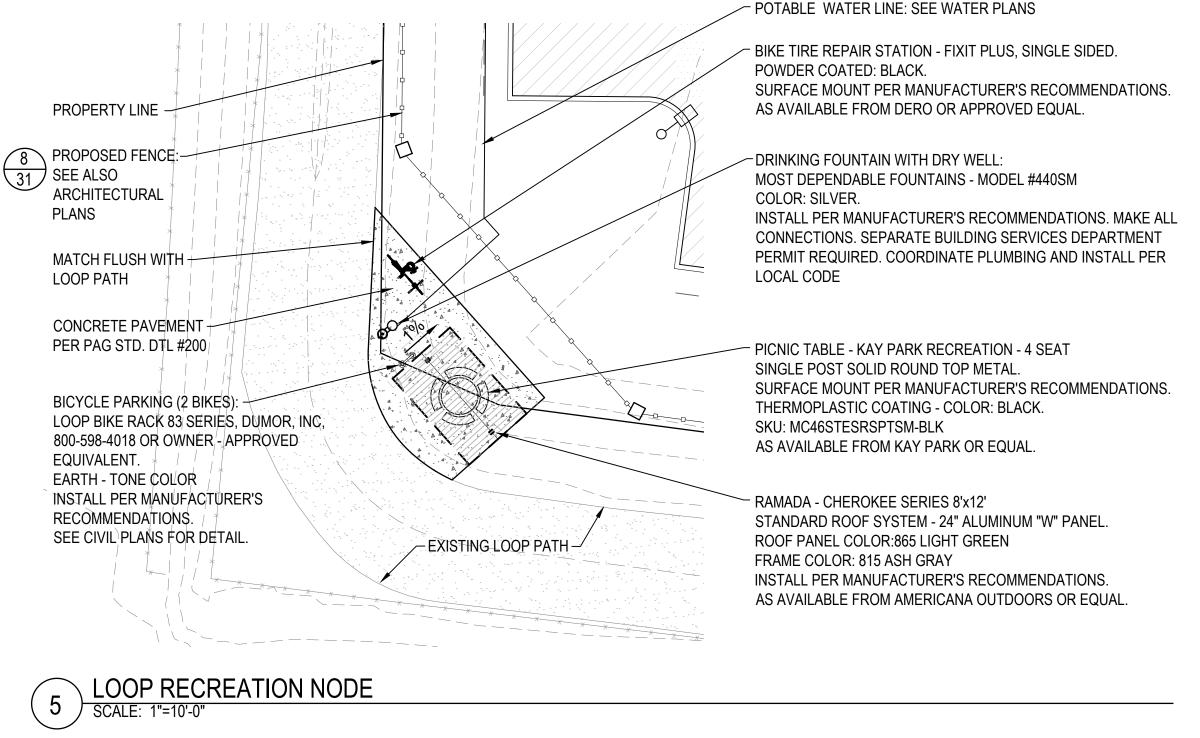

LANDSCAPE PLAN

ENCANTADA AT ORO VALLEY MARKETPLACE

LOTS 1-10 AND A PORTION OF COMMON AREA "A" (OPEN SPACE)

OF ORO VALLEY MARKETPLACE

AS RECORDED IN BOOK 64 OF MAPS & PLATS AT PAGE 42

LOCATED IN A PORTION OF SECTION 31 AND 32, TOWNSHIP 11 SOUTH, RANGE 14 EAST GILA & SALT RIVER MERIDIAN TOWN OF ORO VALLEY, PIMA COUNTY, ARIZONA



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No. Date Sheet Title LANDSCAPE PLAN SITE DETAILS File:Q:\185050\H-003 OVVC Apartments\02 Landscape\06 LP\185050 ovvc encantada L29 Site Dets.dwg

PLAN NUMBER: 250015

REFERENCE NUMBER:

2500115W 2001300 2402389

OV1204-30 OV1204-30A


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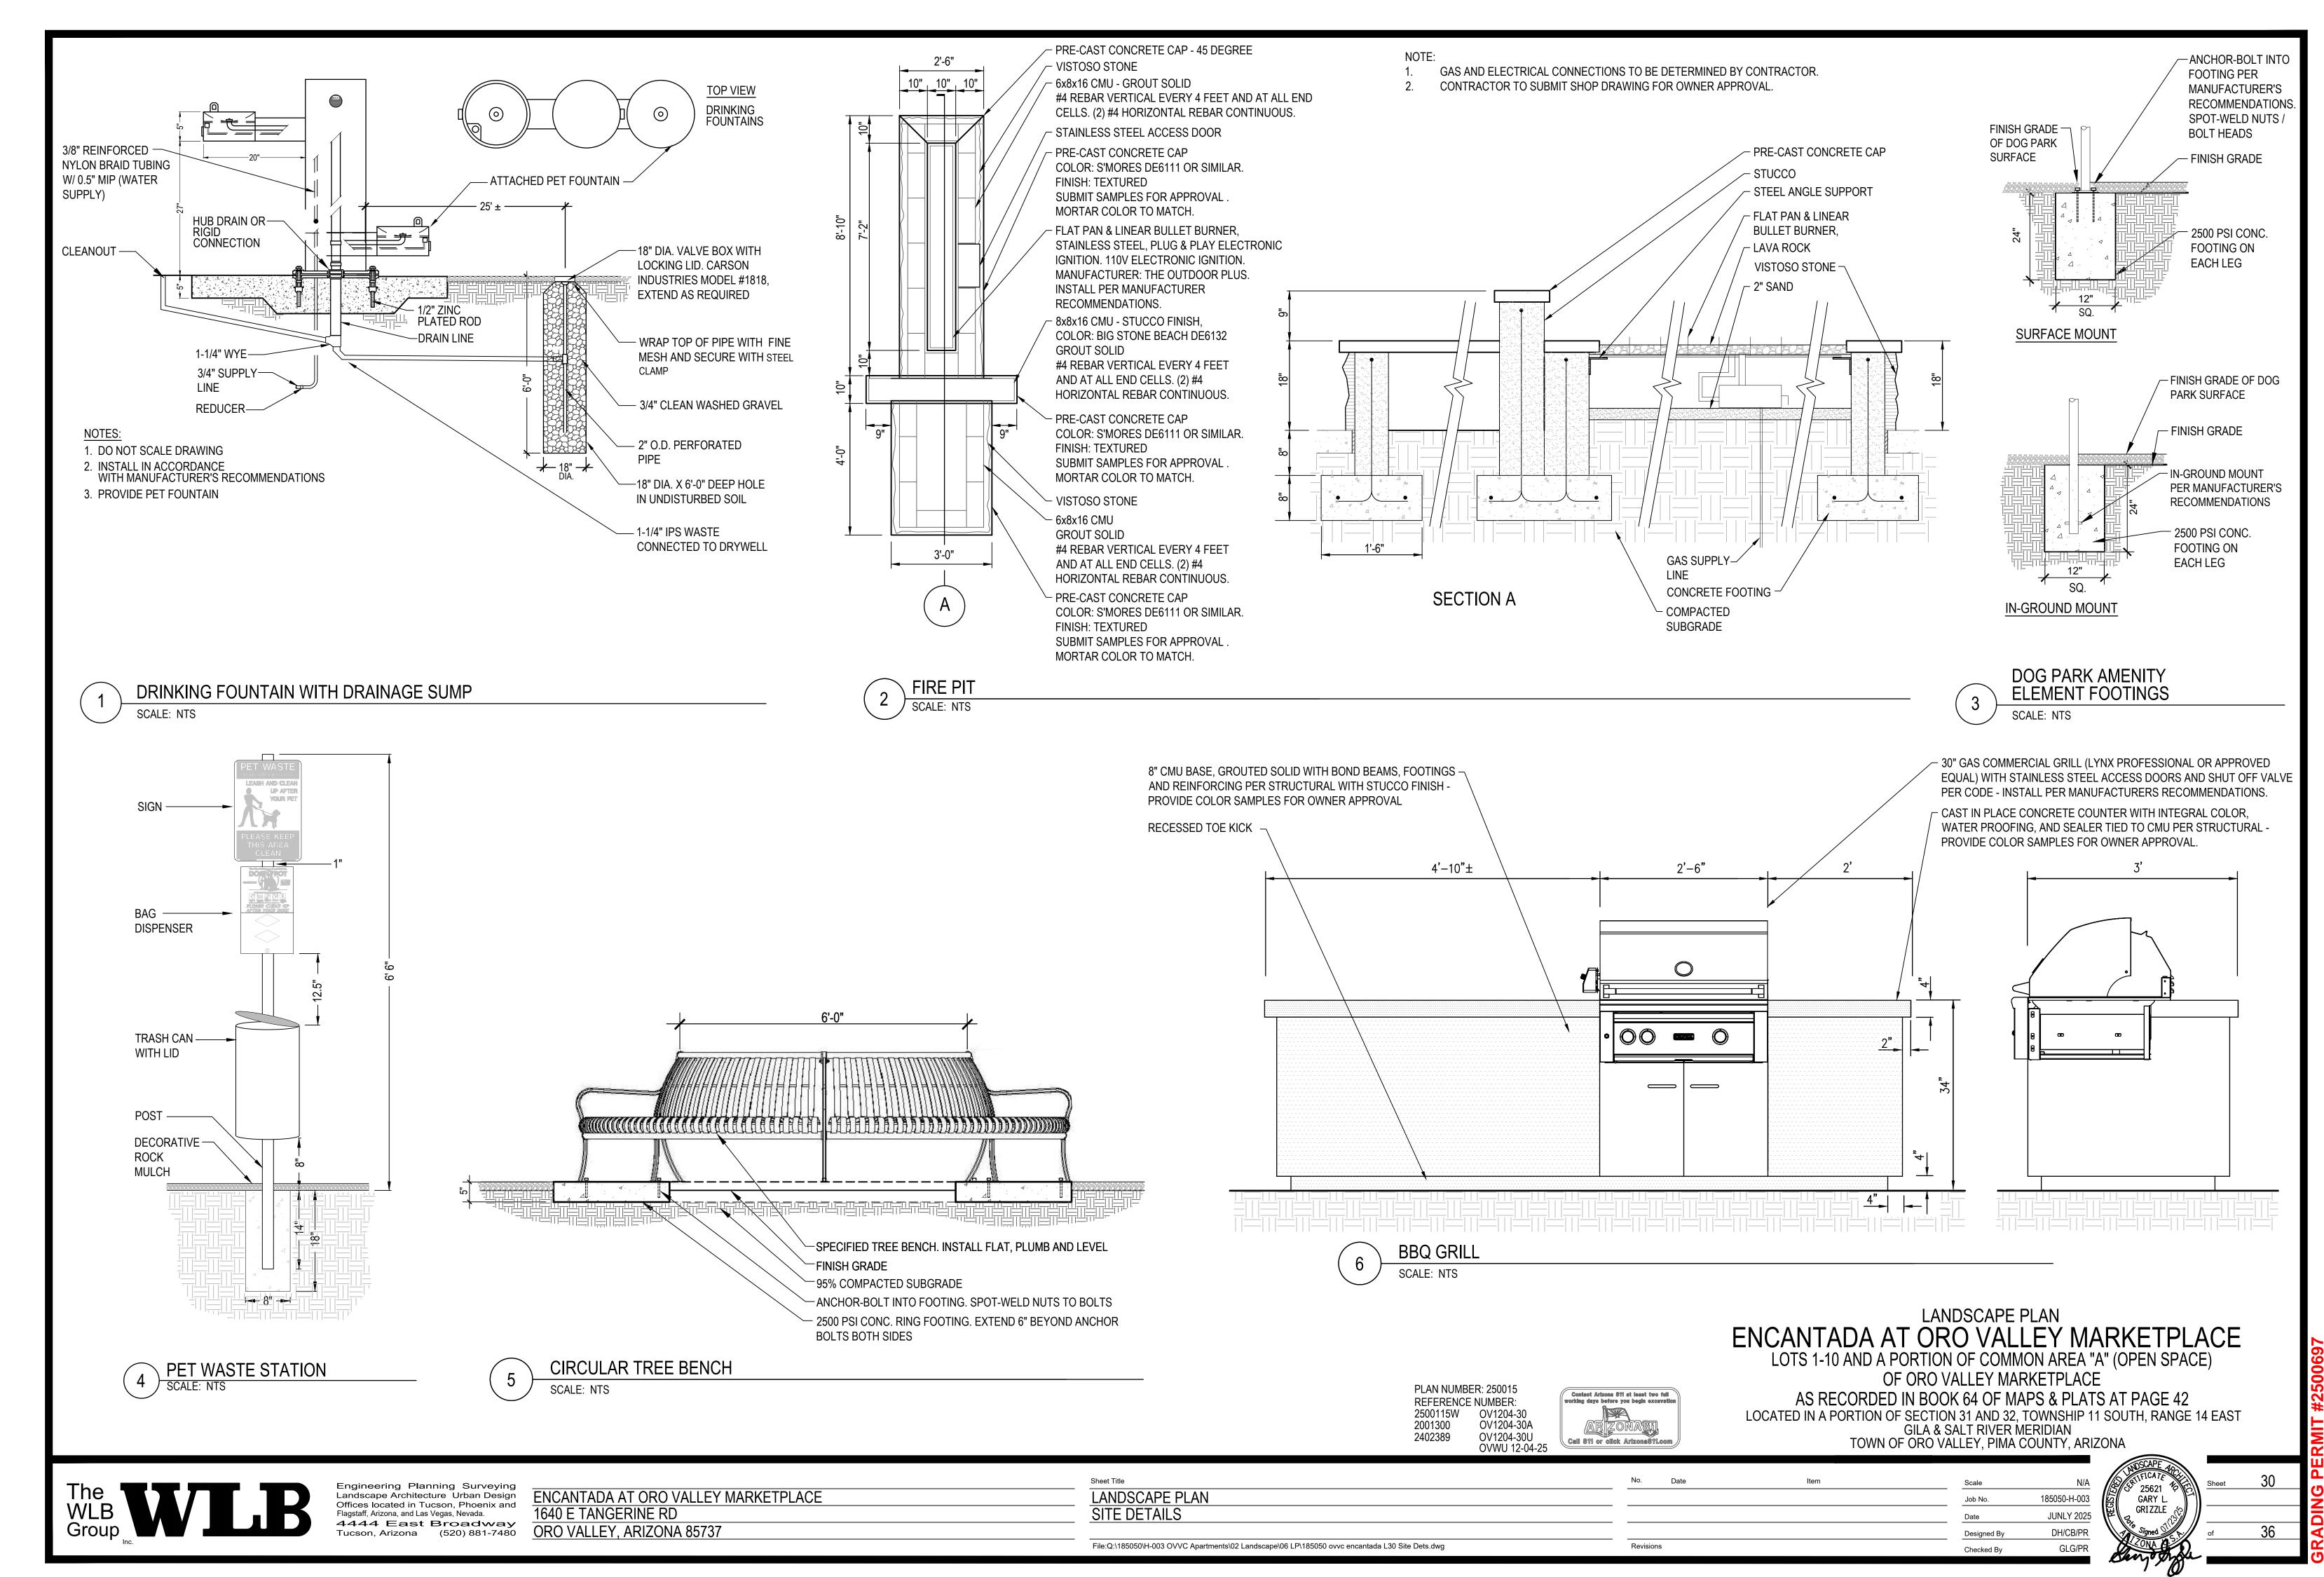
OVWU 12-04-25


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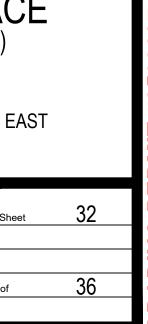
4444 East Broadway


Tucson, Arizona (520) 881-7480


ORO VALLEY, ARIZONA 85737


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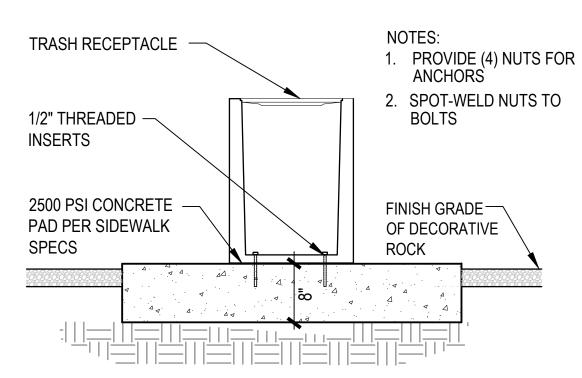
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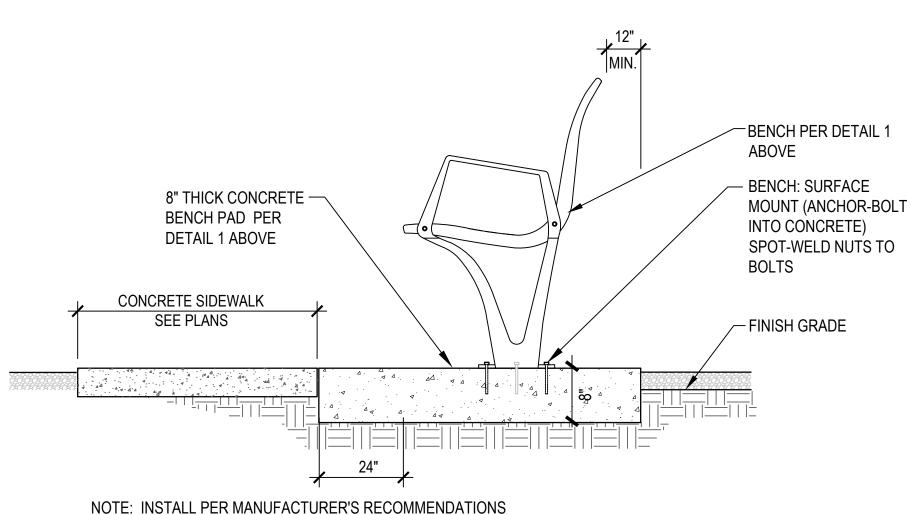


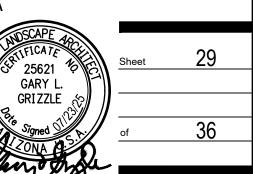

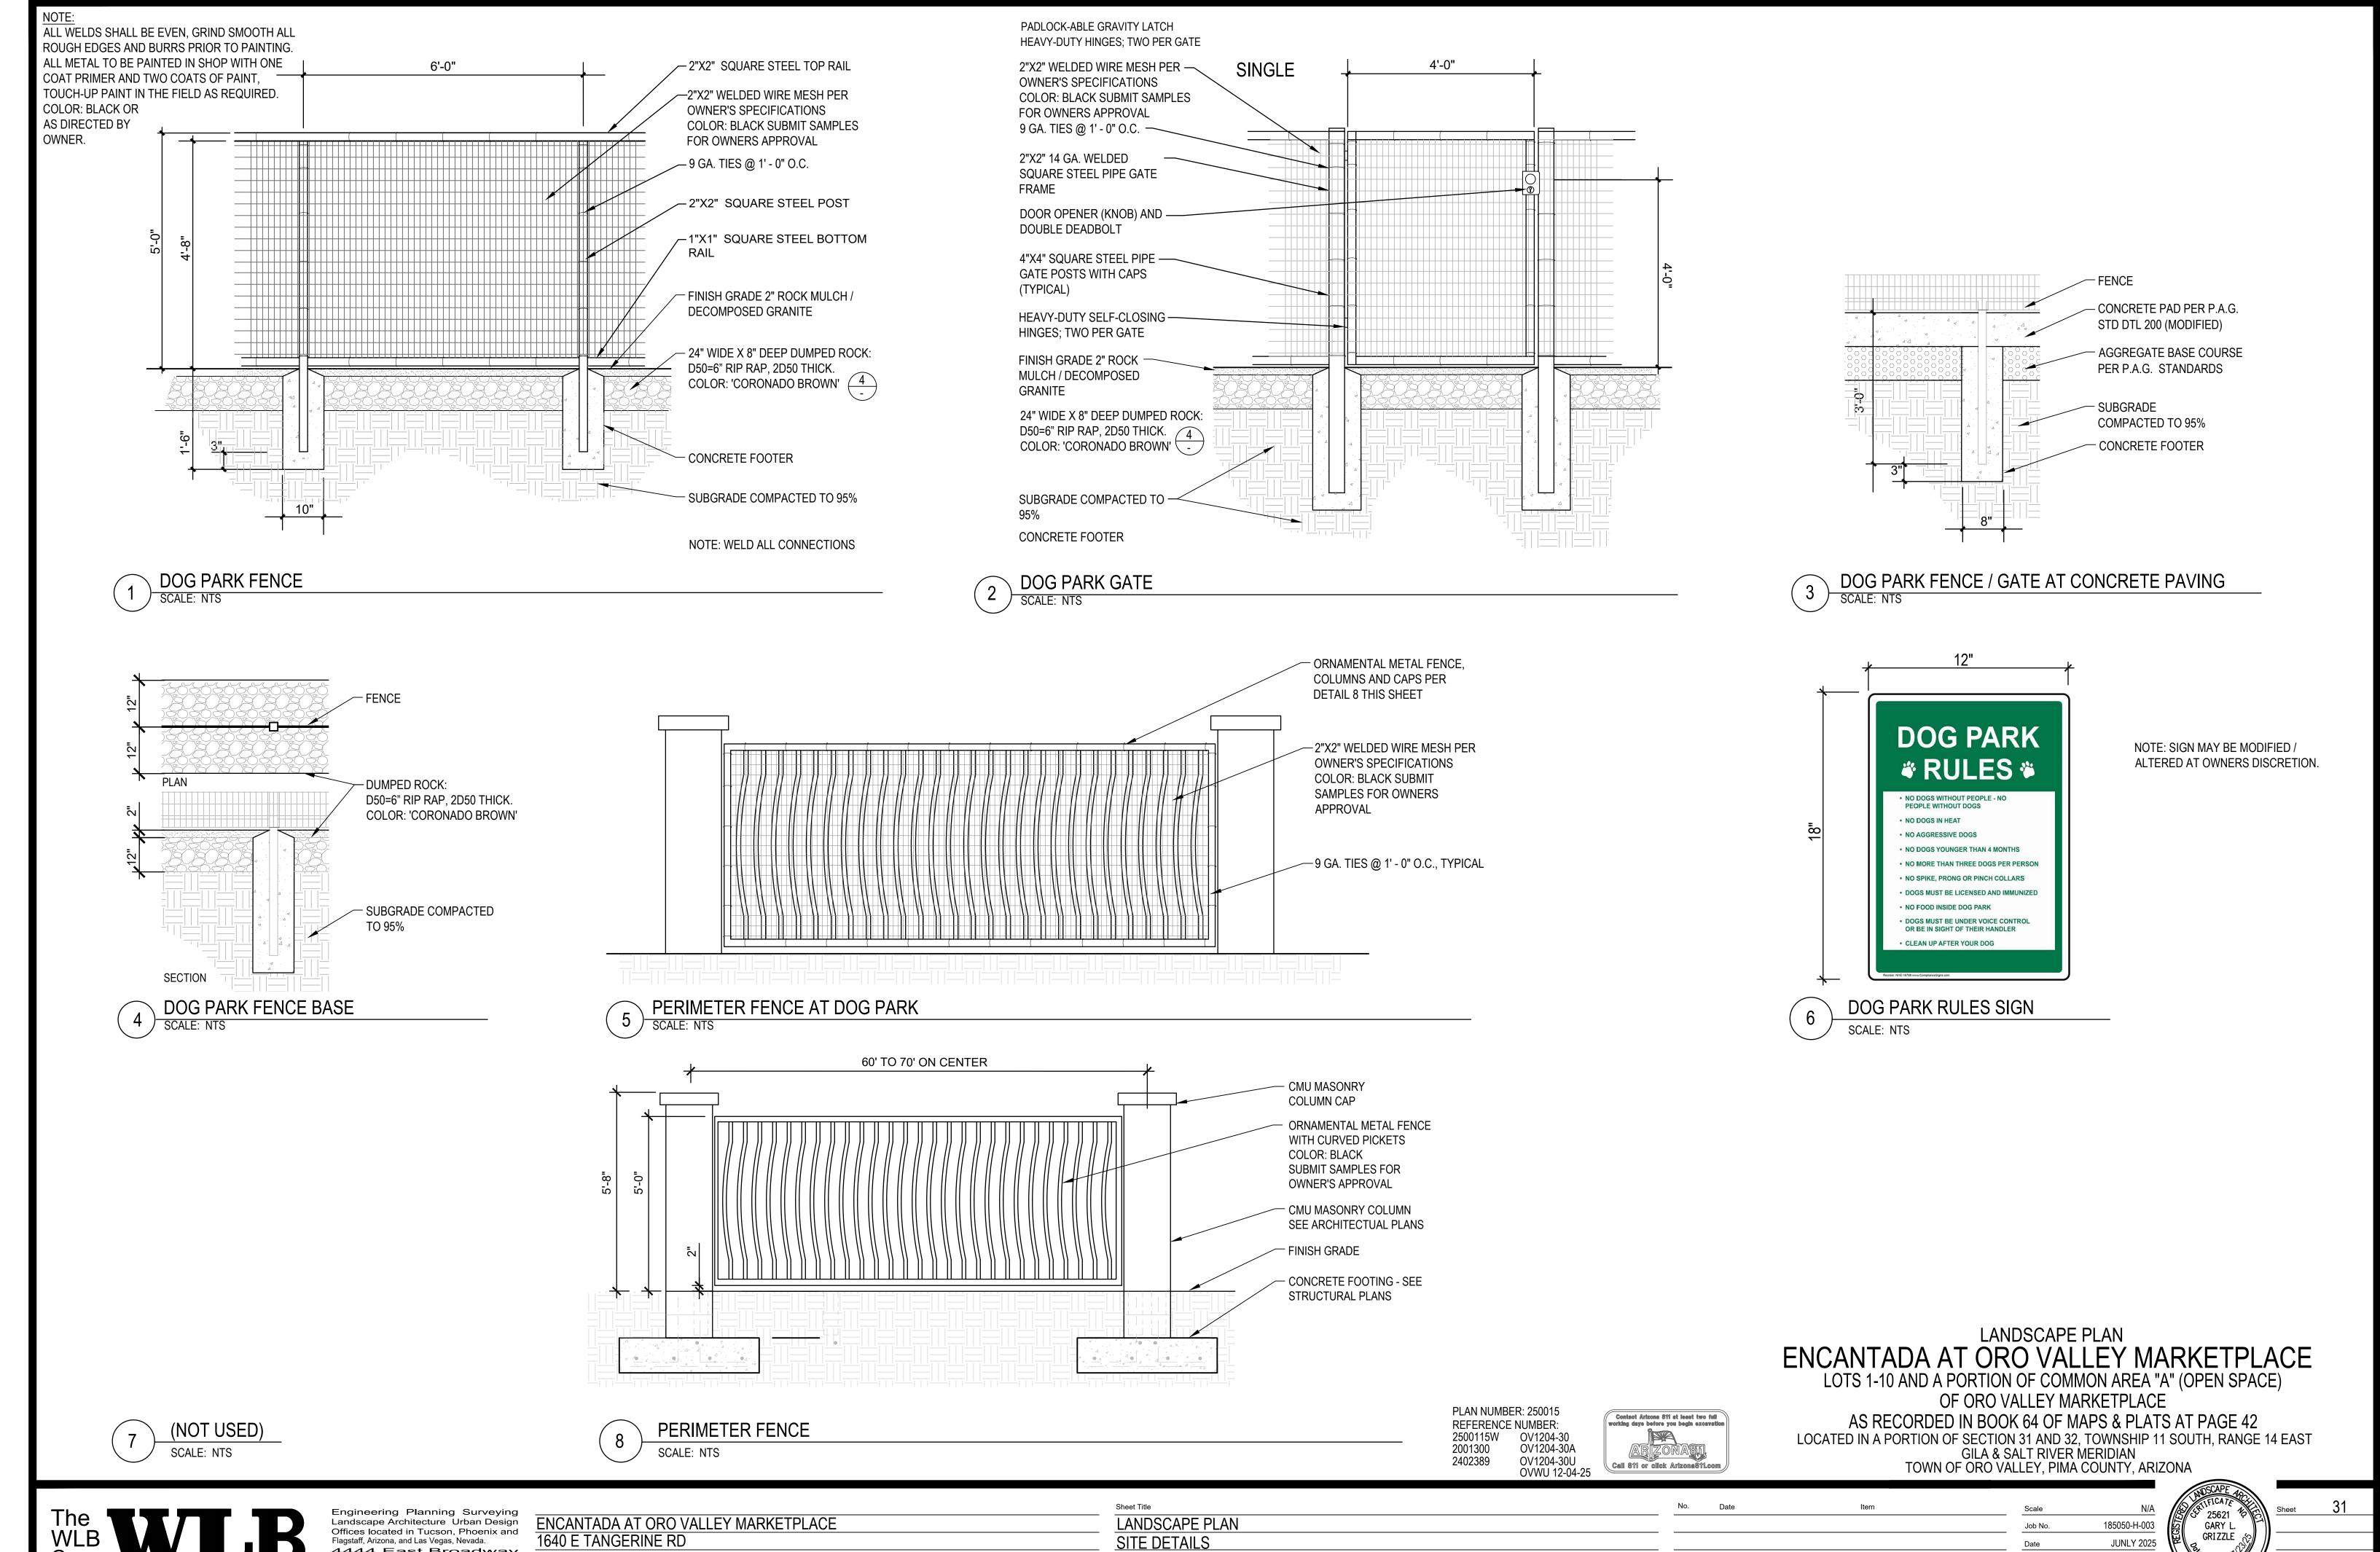


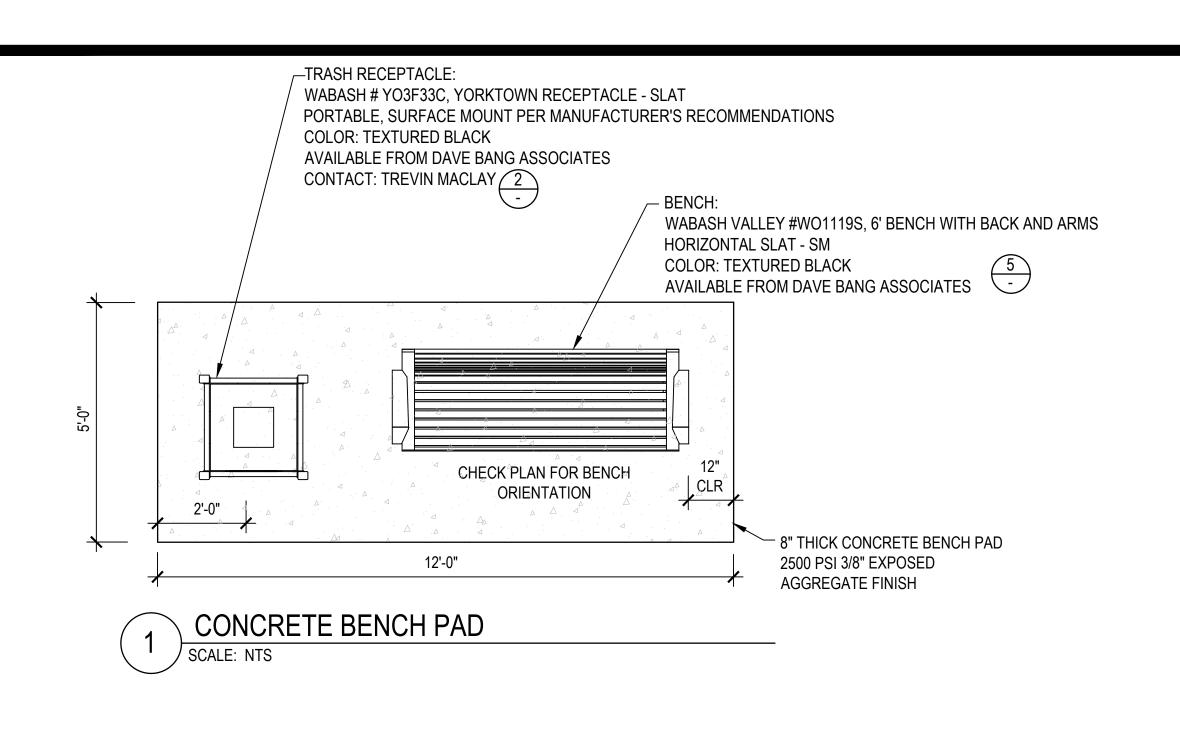NOTE: INSTALL PER MANUFACTURER'S RECOMMENDATIONS

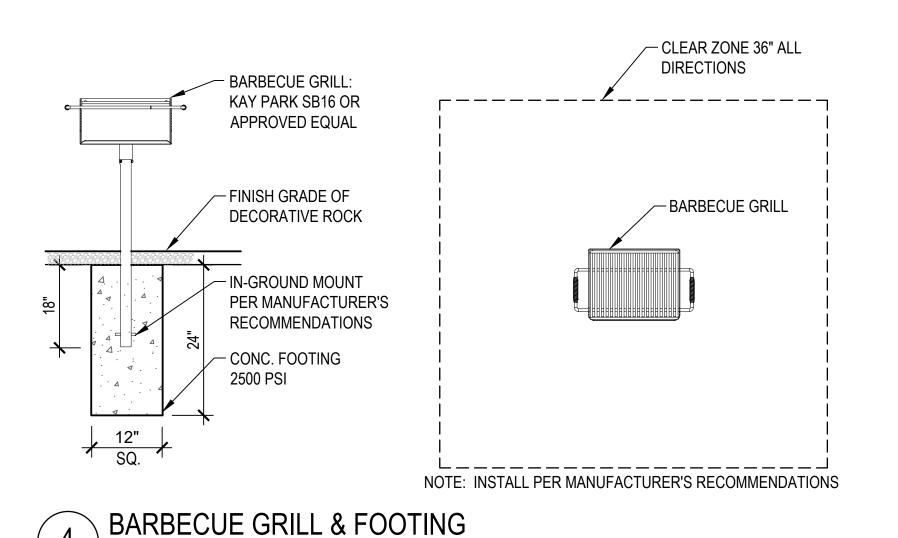TRASH RECEPTACLE ON BENCH PAD SCALE: NTS

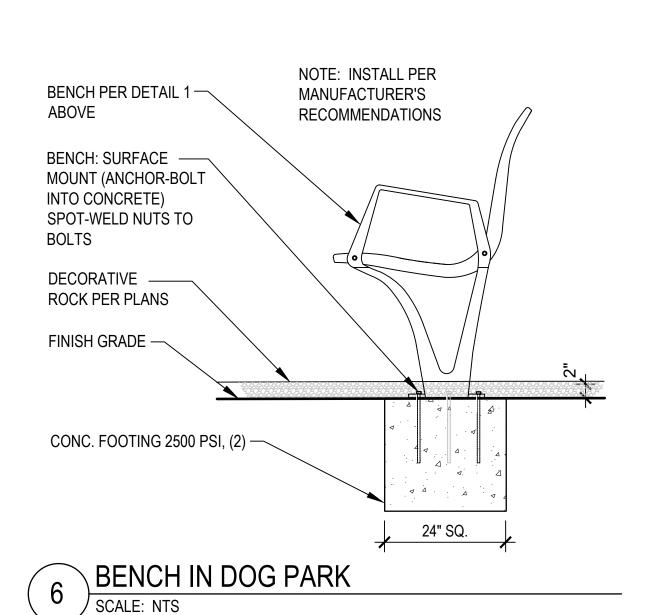


BENCH ON CONCRETE PAD SCALE: NTS

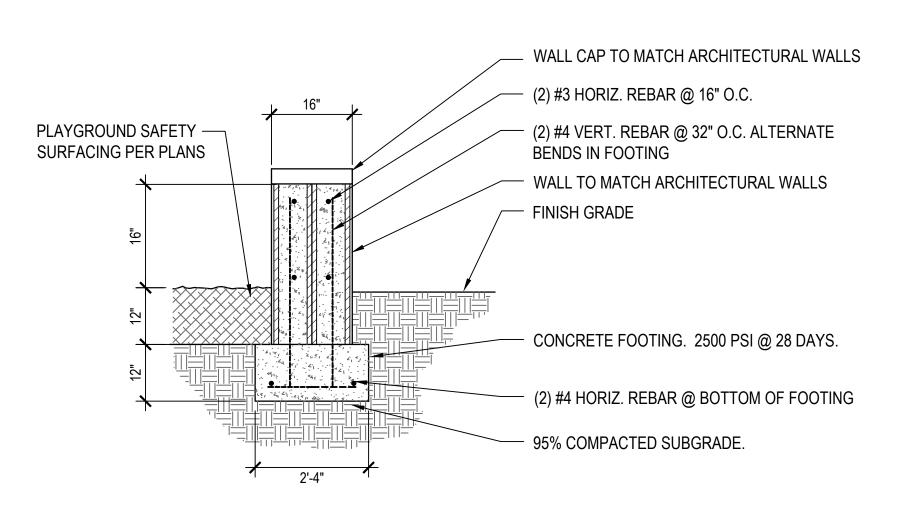


PLAYGROUND SEAT WALL SCALE: NTS PLAN NUMBER: 250015 REFERENCE NUMBER: OV1204-30 OV1204-30A 2500115W 2001300

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NOTE: INSTALL PER MANUFACTURER'S RECOMMENDATIONS

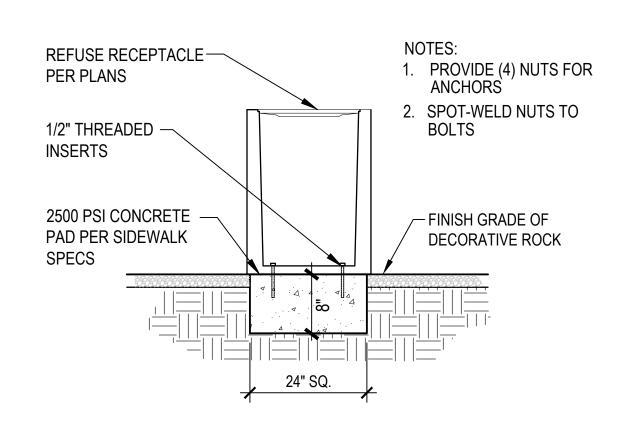

TRASH RECEPTACLE IN LANDSCAPE AREAS

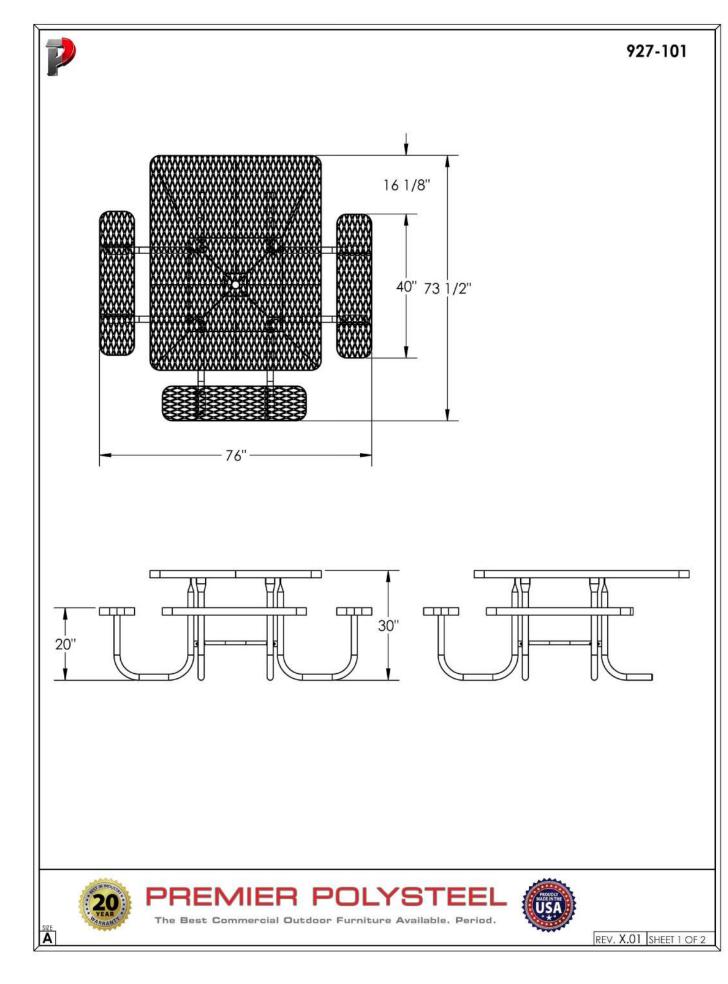

PICNIC TABLE

LANDSCAPE PLAN ENCANTADA AT ORO VALLEY MARKETPLACE LOTS 1-10 AND A PORTION OF COMMON AREA "A" (OPEN SPACE)

OF ORO VALLEY MARKETPLACE AS RECORDED IN BOOK 64 OF MAPS & PLATS AT PAGE 42

LOCATED IN A PORTION OF SECTION 31 AND 32, TOWNSHIP 11 SOUTH, RANGE 14 EAST GILA & SALT RIVER MERIDIAN TOWN OF ORO VALLEY, PIMA COUNTY, ARIZONA



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ENCANTADA AT ORO VALLEY MARKETPLACE 1640 E TANGERINE RD ORO VALLEY, ARIZONA 85737


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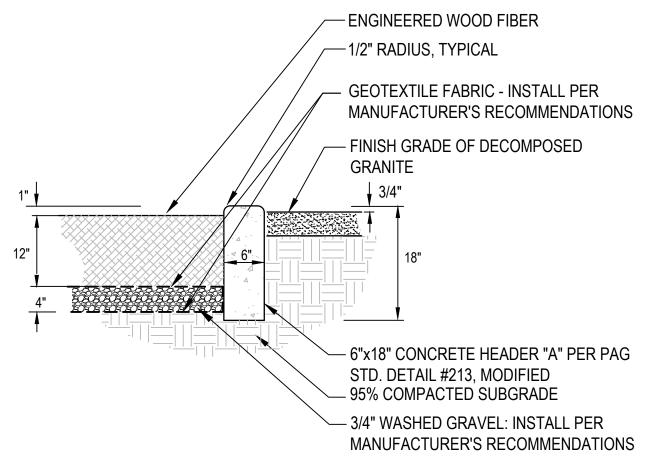
2402389

185050-H-003 Job No. **JUNLY 2025** DH/CB/PR Designed By GLG/PR Checked By







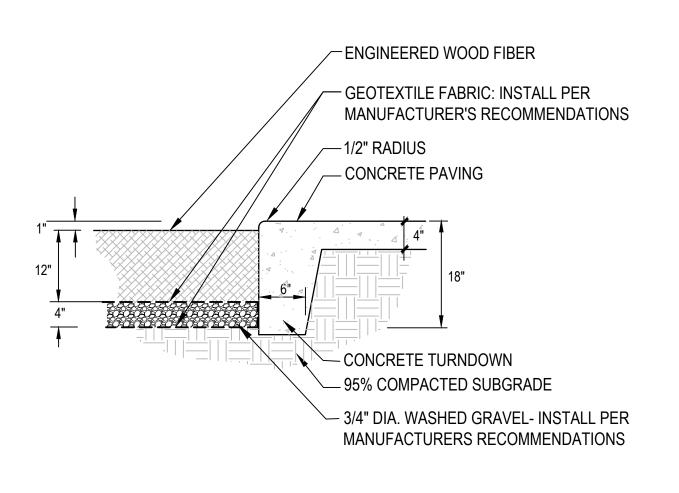

FINISH GRADE OF TURF AREA OR DECORATIVE ROCK — 1/2" RADIUS - SIDEWALK PER P.A.G. STD DTL 200 (MODIFIED) - AGGREGATE BASE COURSE PER P.A.G. STANDARDS 95% COMPACTED SUBGRADE

1/2" THICK FIBER EXPANSION JOINT FILLER (NON-ASPHALTIC). EXTEND 1" MIN. BELOW BASE OF CONCRETE. USE **ELASTOMERIC SEALANT OVER** NOTE: 1. PROVIDE EXPANSION JOINTS @ ALL EXPANSION JOINT MATERIAL. COLOR CONSTRUCTION JOINTS. TO MATCH ADJACENT CONCRETE. 1/4" RADIUS AT EDGES. FORMED CONTROL JOINT, $1\frac{1}{2}$ " DEEP WITH 1/4" RADIUS AT EDGES.


- EXPANSION JOINT:

ENGINEERED WOOD FIBER AT CONCRETE TURNDOWN

ENGINEERED WOOD FIBER AT PLAYGROUND HEADER


CONCRETE PAVING

CONCRETE RAMP TO BE 6' LONG - ENGINEERED WOOD AS -CONCRETE BY 5' WIDE, MIN. SPECIFIED TURNDOWN PER DETAIL 1 THIS 1/2" RADIUS - CONCRETE ACCESS RAMP SHEET 5" THICK WASHED GRAVEL -95% COMPACTED SUBGRADE - INSTALL PER MANUFACTURERS SECTION

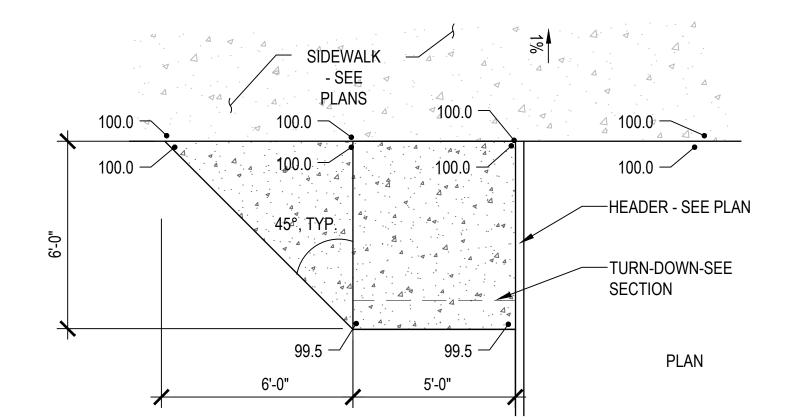

NOTE: GRADES SHOWN ARE RELATIVE: SEE GRADING PLAN FOR ACTUAL SPOT ELEVATIONS

ACCESS RAMP @ SAFETY SURFACE

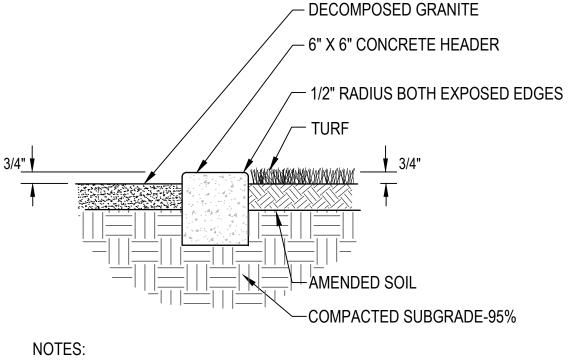


- 1. SMOOTH TROWEL FINISH ALL EXPOSED SURFACES.
- 2. 1/2" DEEP SCORED CONTROL JOINTS AT 5' ON CENTER.
- 3. EXPANSION JOINTS AND BITUMINOUS JOINT FILLER AT 40' ON CENTER.
- SCALE: NTS

CONCRETE HEADER


- EXPANSION JOINT PER DETAIL #4 THIS SHEET - CONCRETE PAVING NOTE: 1. PROVIDE EXPANSION JOINTS AT ALL CONSTRUCTION JOINTS.

EXPANSION / ISOLATION JOINT AT VERTICAL SURFACE SCALE: NTS

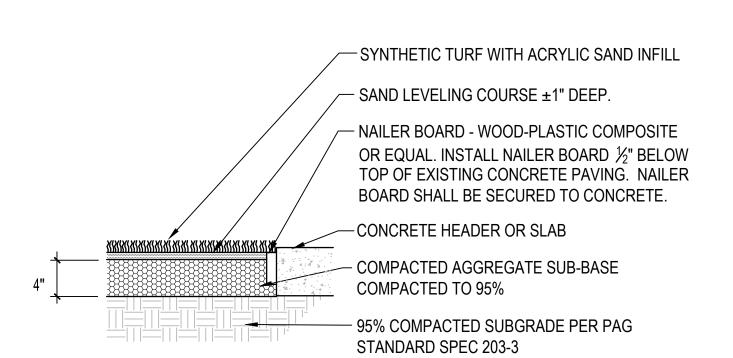

CONCRETE JOINTS


- 1. INSTALL SYNTHETIC GRASS PER MANUFACTURER'S RECOMMENDATIONS.
- 2. EDGE OF TURF SHALL BE SECURED TO NAILER BOARD WITH MECHANICAL FASTENERS AT 8" ON CENTER MINIMUM, PER MANUFACTURERS RECOMMENDATION.

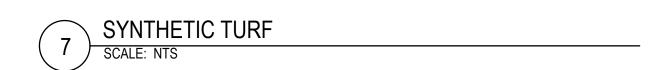

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- 1. APPLY PRE-EMERGENT HERBICIDE TO SUBGRADE SURFACE.
- 2. SEE PLANT LEGEND FOR DECOMPOSED GRANITE DESCRIPTIONS
- 3. FOLLOW STABILIZER MANUFACTURER'S RECOMMENDATIONS FOR INSTALLATION OF PATHWAY.
- 4. USE FORMWORK DURING INSTALLATION TO PRODUCE A REGULAR EDGE



STABILIZED DECOMPOSED GRANITE SCALE: NTS
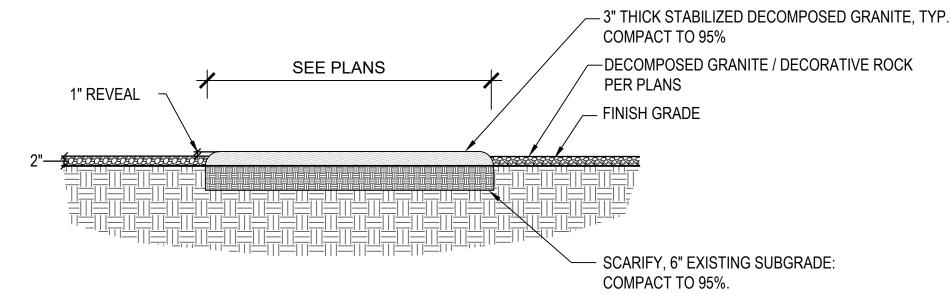
> LANDSCAPE PLAN ENCANTADA AT ORO VALLEY MARKETPLACE LOTS 1-10 AND A PORTION OF COMMON AREA "A" (OPEN SPACE)

OF ORO VALLEY MARKETPLACE

AS RECORDED IN BOOK 64 OF MAPS & PLATS AT PAGE 42 LOCATED IN A PORTION OF SECTION 31 AND 32, TOWNSHIP 11 SOUTH, RANGE 14 EAST GILA & SALT RIVER MERIDIAN TOWN OF ORO VALLEY, PIMA COUNTY, ARIZONA



RECOMMENDATIONS

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Sheet Title LANDSCAPE PLAN SITE DETAILS File:Q:\185050\H-003 OVVC Apartments\02 Landscape\06 LP\185050 ovvc encantada L33 Site Dets.dwg

PLAN NUMBER: 250015

REFERENCE NUMBER:

2500115W 2001300


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OV1204-30 OV1204-30A

OV1204-30U OVWU 12-04-25

No. Date 185050-H-003 Job No. **JUNLY 2025** DH/CB/PR GLG/PR Checked By



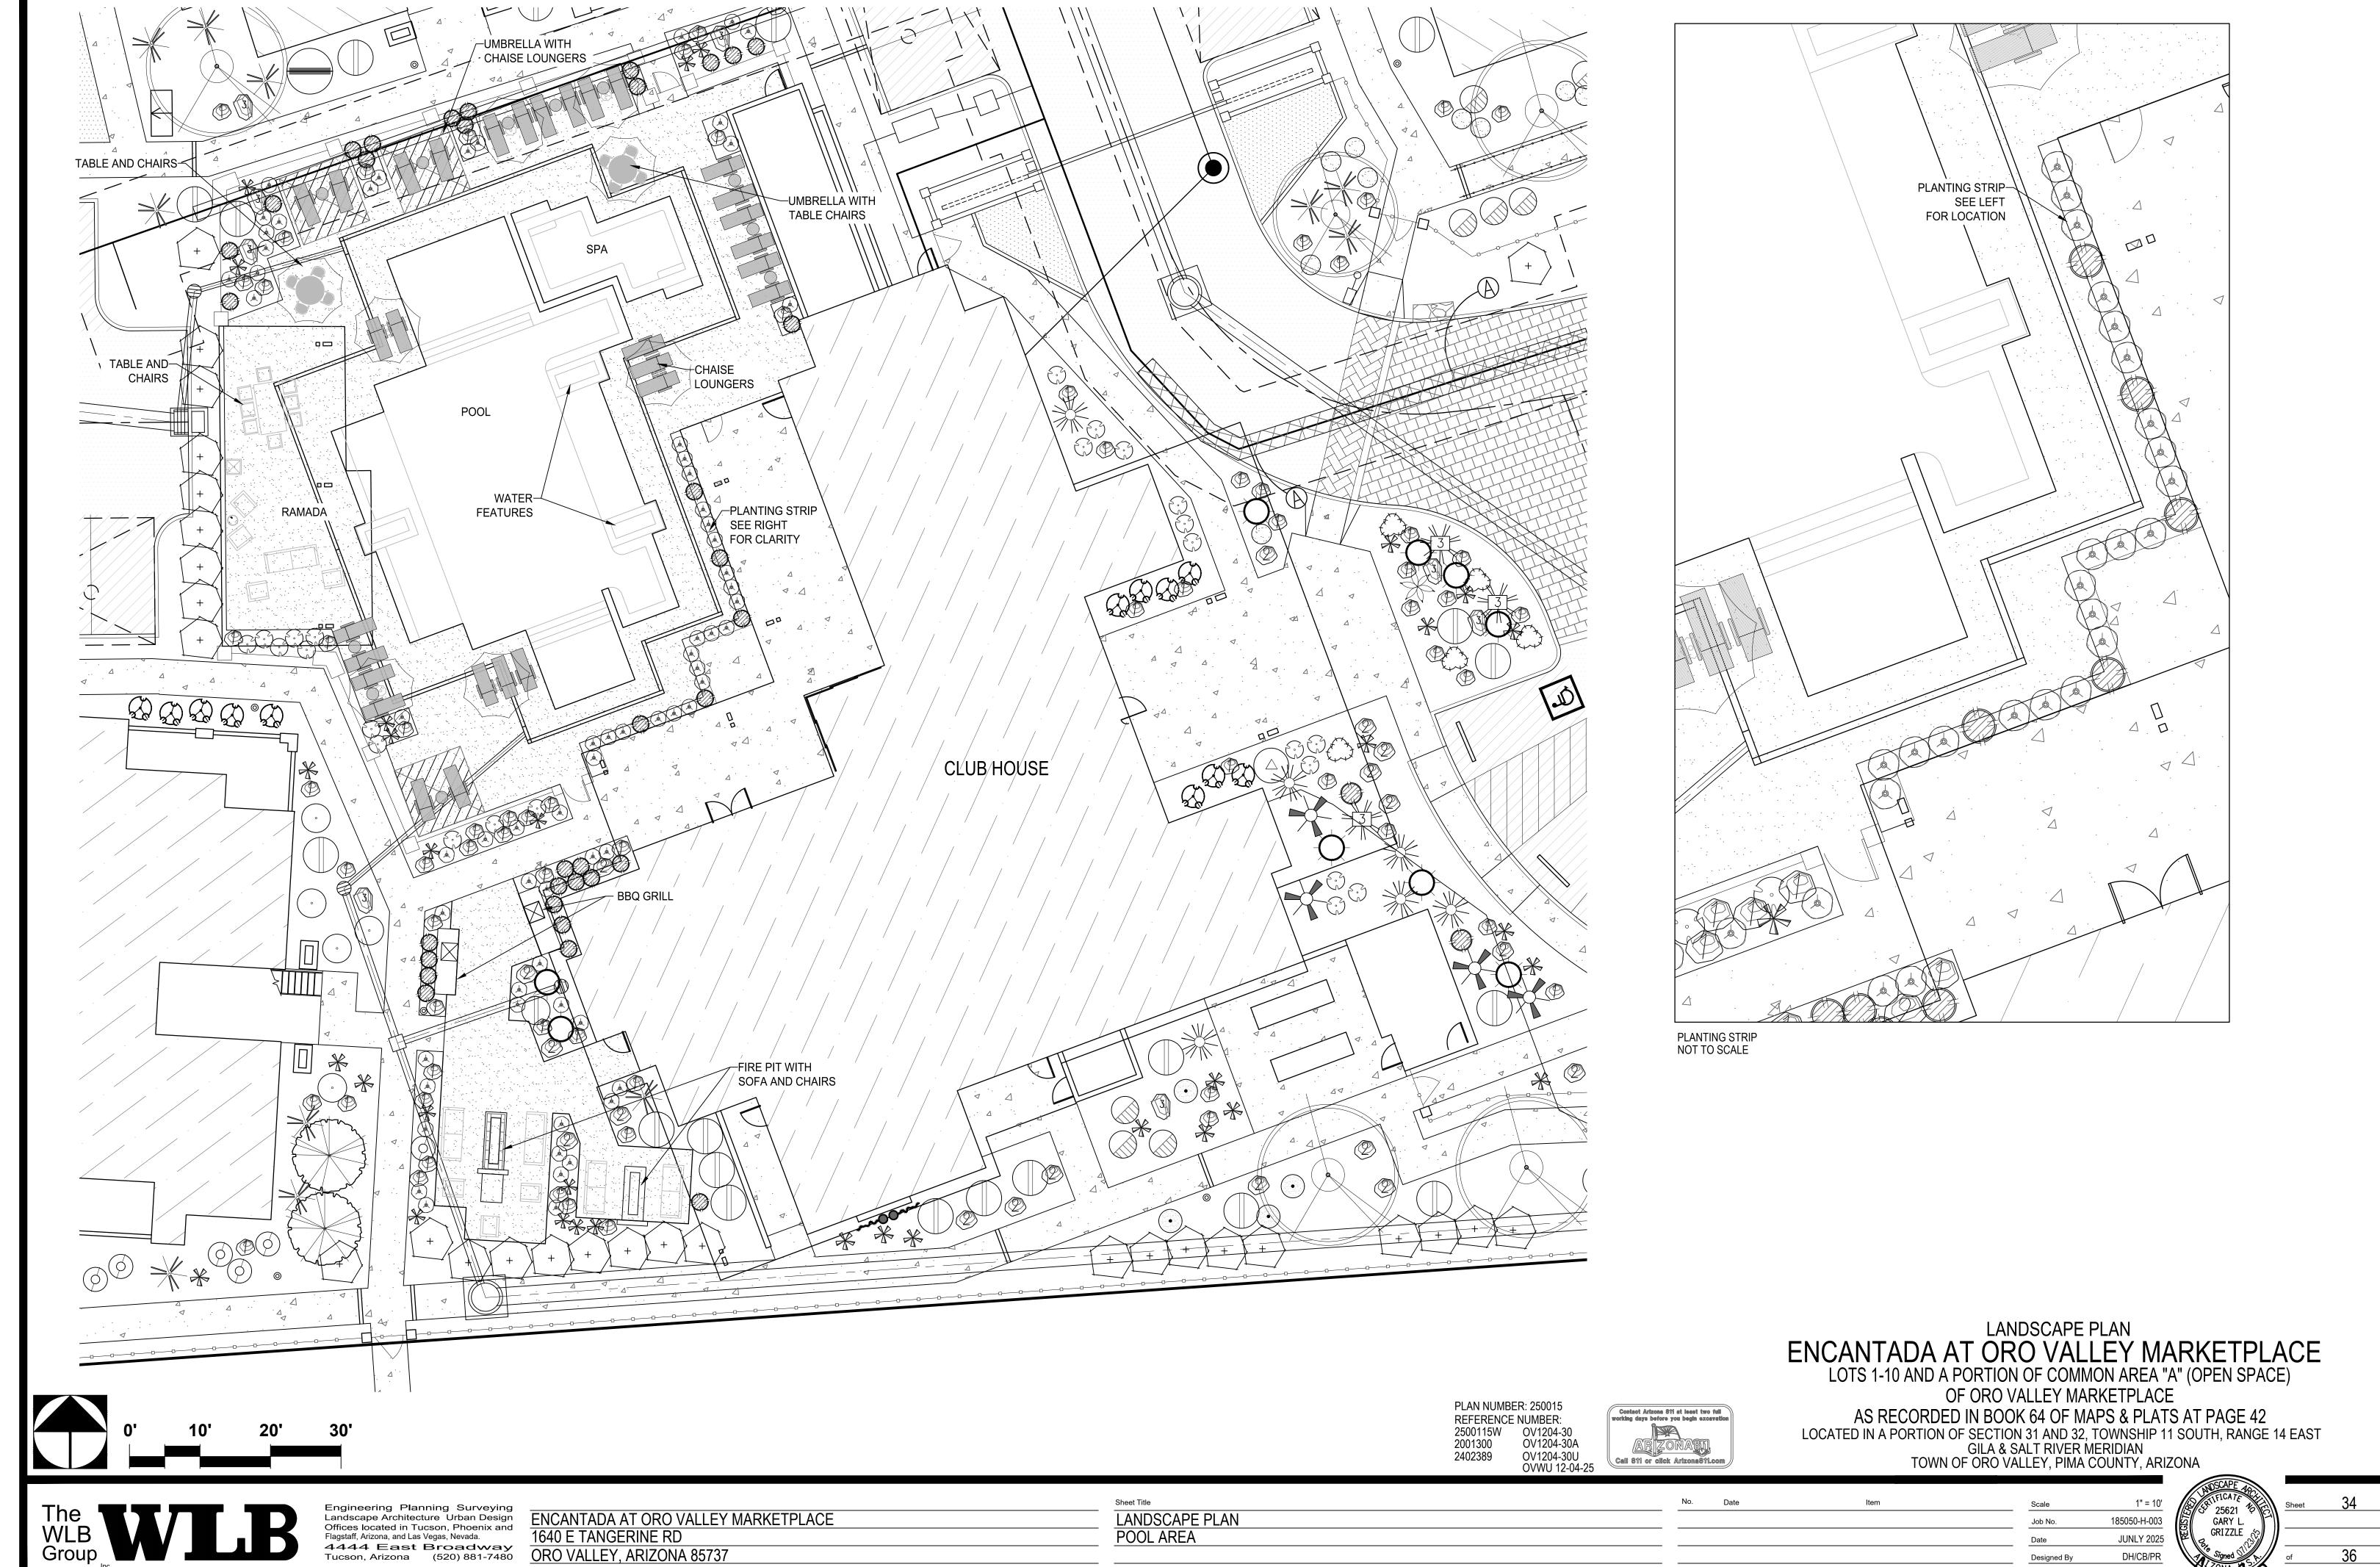

LANDSCAPE PLAN POOL AREA


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ENCANTADA AT ORO VALLEY MARKETPLACE 1640 E TANGERINE RD

ORO VALLEY, ARIZONA 85737

185050-H-003 **JUNLY 2025**

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ORO VALLEY, ARIZONA 85737


DH/CB/PR GLG/PR

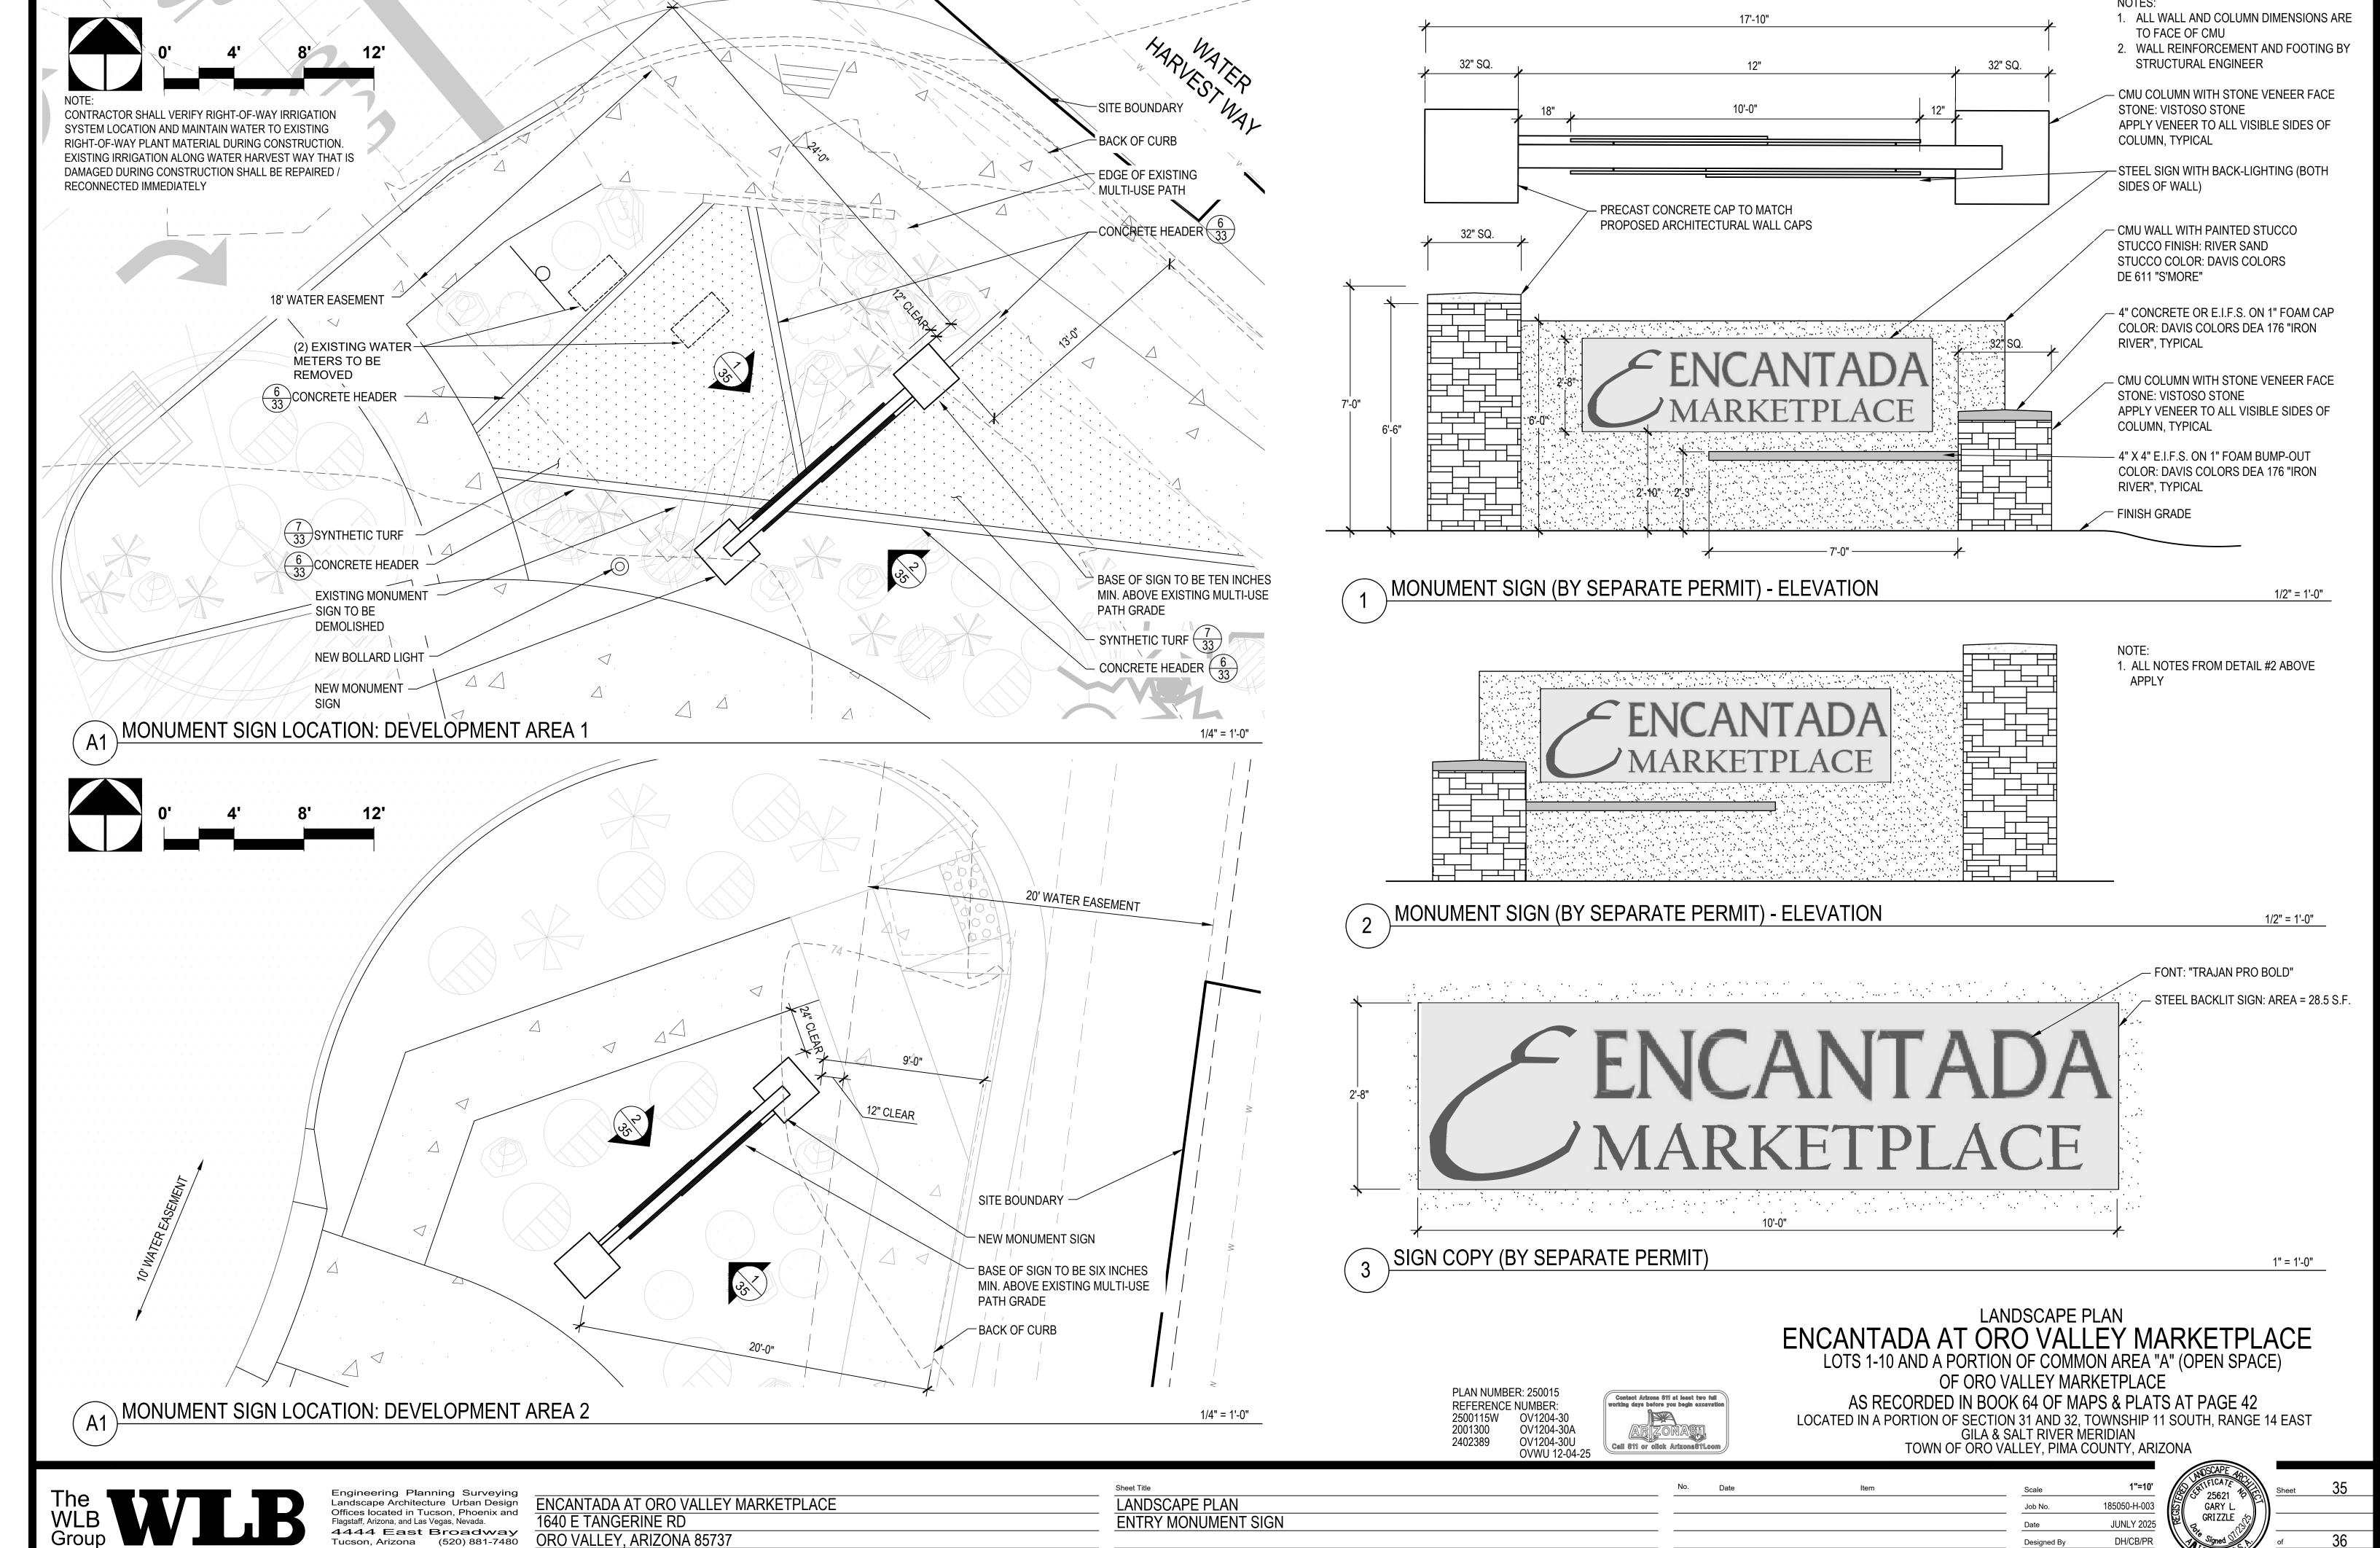





AGILITY BONE N.T.S.



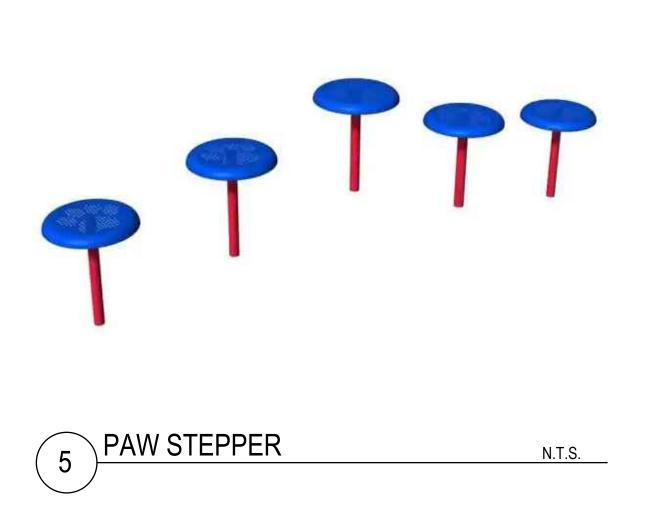

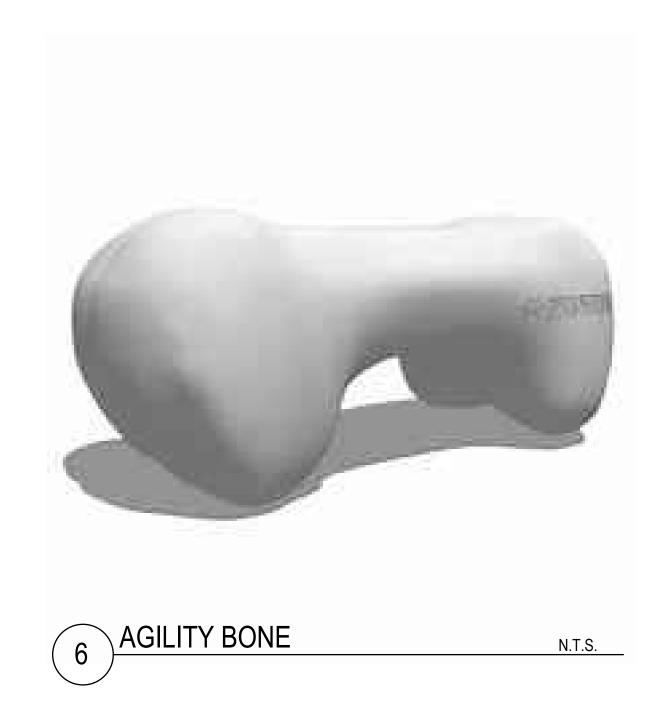

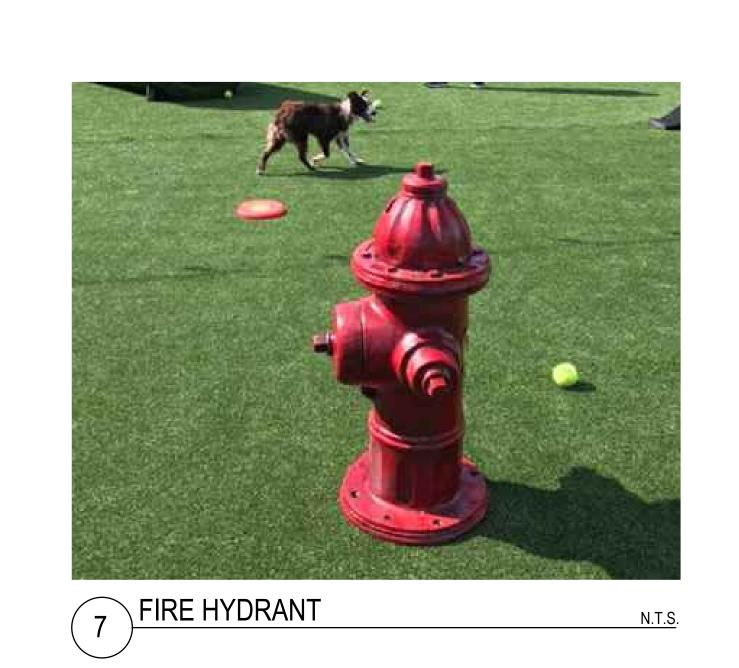

REFERENCE NUMBER: 250015
REFERENCE NUMBER: 2500115W OV1204-30 OV1204-30A OV1204-30U OVWU 12-04-25

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PLAN NUMBER: 250015

LANDSCAPE PLAN
ENCANTADA AT ORO VALLEY MARKETPLACE
LOTS 1-10 AND A PORTION OF COMMON AREA "A" (OPEN SPACE)
OF ORO VALLEY MARKETPLACE
AS RECORDED IN BOOK 64 OF MAPS & PLATS AT PAGE 42

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LANDSCAPE PLAN DOG PARK ELEMENTS File:Q:\185050\H-003 OVVC Apartments\02 Landscape\06 LP\185050 ovvc encantada L36 Dog Elements.dwg

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