GENERAL NOTES:


- A. Gross area of development in acres: 10.7 AC (including 3.9 AC offsite work)
- B. Total acres of graded area: 10.7 AC
- C. Total acres of undisturbed area: 0
- D. Total amount of open space required and provided (as defined in Chapter 31 Definitions) Open Space Required: 30% of the gross area of the site Open Space Provided: 37.7% (including landscape common areas; excluding
- trailhead use area) Total amount of Landscaped Common Areas: 99,952 SF. E. Landscape Bufferyard "A" Residential Street Frontage along Vistoso Highlands Dr. (Minimum 15 ft.) Landscaped buffer yards appropriately labeled per OVZCR Table
- F. The existing zoning for A.P.N. 219-19-1910 is Rancho Vistoso PAD 5 'HDR.' (See PAD document dated June 22, 1987 Ordinance # (O) 06-02 (latest amendment.) The existing zoning for A.P.N. 219-19-1840 is RV PAD 5 'Open Space.' The proposed zoning for A.P.N. 219-19-1840 is RV PAD 5 'Recreation.' (See Sheet 2 civil notes for 'Rezoning Conditions.'
- G. Classification of each perimeter street abutting the property and type and width of street buffer yards provided
- H. Landscape to conform to Oro Valley Landscape Code.
- Mitigation of surveyed plants in the Native Plant Preservation Plan will be incorporated in the landscape design.
- J. Assurances for landscaping and re-vegetation bonds must be posted prior to issuance of grading permits. A landscape bond in the amount of 10% of the original landscape bond shall remain in place for a period of one year from the complete installation of landscape materials and any replacement materials.
- K. Property owner shall maintain buffer yard plantings to ensure unobstructed visibility to motorists. All shrubs, accents, and groundcovers shall not exceed thirty (30") inches in height within site visibility triangles. Trees within site visibility triangles will be maintained to ensure that branches/foliage is not below a height of six (6') feet and the diameter should not exceed 1-foot when fully mature.
- Property owners, lessees, and occupants shall maintain required landscape, irrigation, buffering, screening, and rainwater harvesting system improvements per the approved
- M. In the event of abandonment of the site after grading/disturbance of natural areas, disturbed areas shall be re-vegetated with a non-irrigated hydro seed mix from the OVZCR Addendum D: Approved revegetation seed mix.
- N. All plant material shall meet the minimum standards contained in the current editions of the Arizona Nursery Association's Growers Committee Recommended Tree Specifications and the American Association of Nurserymen as to size, condition, and


O. Property owner is responsible for maintaining the temporary irrigation system as long


- as necessary in order to transition plants over to natural sources. Any plant materials that die in transition, for any reason, shall be replaced in accordance with Sec. 27.6.E.4, Maintenance.
- P. Any spaded or boxed tree transplanted on site that dies due to neglect or lack of maintenance shall be replaced with the same size and species of the original salvaged tree, as required by the salvage plan.
- Q. The limits of grading shall be staked in the field, in accordance with Section 27.6.B.7.c.ii of the Zoning Code. Disturbance outside the approved grading limits shall
- R. Property owner is responsible for maintaining the temporary irrigation system as long as necessary in order to transition plants over to natural sources. Irrigation shall be reduced three years after issuance of the first certificate of occupancy. Metered water use for landscape irrigation shall be reduced by fifty percent, five years from the date of the issuance of the certificate of occupancy.
- No salvage of plants regulated by the Endangered Species Act and/or the Arizona Native Plant Law may occur without the issuance of the appropriate permit by the State Department of Agriculture.
- Landscape materials shall not obstruct sight distances or vehicle turning movements.
- U. Landscaped areas that are susceptible to damage by pedestrian or auto traffic shall be protected by appropriate curbs, tree guards, or other devices.
- V. Landscape shall be designed to minimize sediment, sand, and gravel being carried into the streets from storm water or other runoff.
- W. Landscape plan enables adequate plant spacing to ensure survivability at plant
- X. Deep rooted vegetation and trees shall not be planted closer than 7.5' from a public water line. Exceptions for alternative design solutions such as root barriers shall be considered on a case-by-case basis.
- Curb-way consisting of inorganic groundcover or plants not to exceed type 2 water use shall be provided between curb and all sidewalks.
- Z. All landscaped areas to be finished with a natural topping material to a depth of at least two (2) inches.
- AA. There are no overlay zones applicable to the property.
- BB. Table for each buffer yard that indicates buffer yard type, width/length, and number of required and provided trees, shrubs, and accent plants. (See sheet LS-0)
- CC. The proposed development will have trails:
- i. All trail easements indicated are for use by the general public as permanent, non-motorized trail easements or for private use by residents as permanent, non-motorized trail easements.
- ii. All public trails and signage must be constructed by the developer to Pima Regional Trail System Master Plan standards in consultation with the Town Parks and Recreation department. The applicable cross-section is included within these plans. iii. Trail and sign locations, as indicated on this plan, must be field verified by Town staff prior to construction and are subject to adjustment.
- iv. Trails must be positioned in a manner to avoid vegetation and minimize potential
- v. For residential developments, construction of all recreational amenities and public or private trails within the project limits must be completed by the time 35% of building permits are issued per Section 26.5 of the Zoning Code.
- vi. Specify ownership and maintenance responsibility of all trails. Public trail easements must be dedicated to the Town as part of the final plat.

LANDSCAPE & NATIVE PLANT PACKAGE RULNEY VISTOSO RESIDENTIAL

CASE #

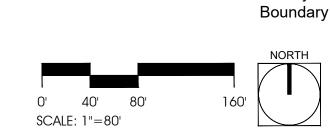

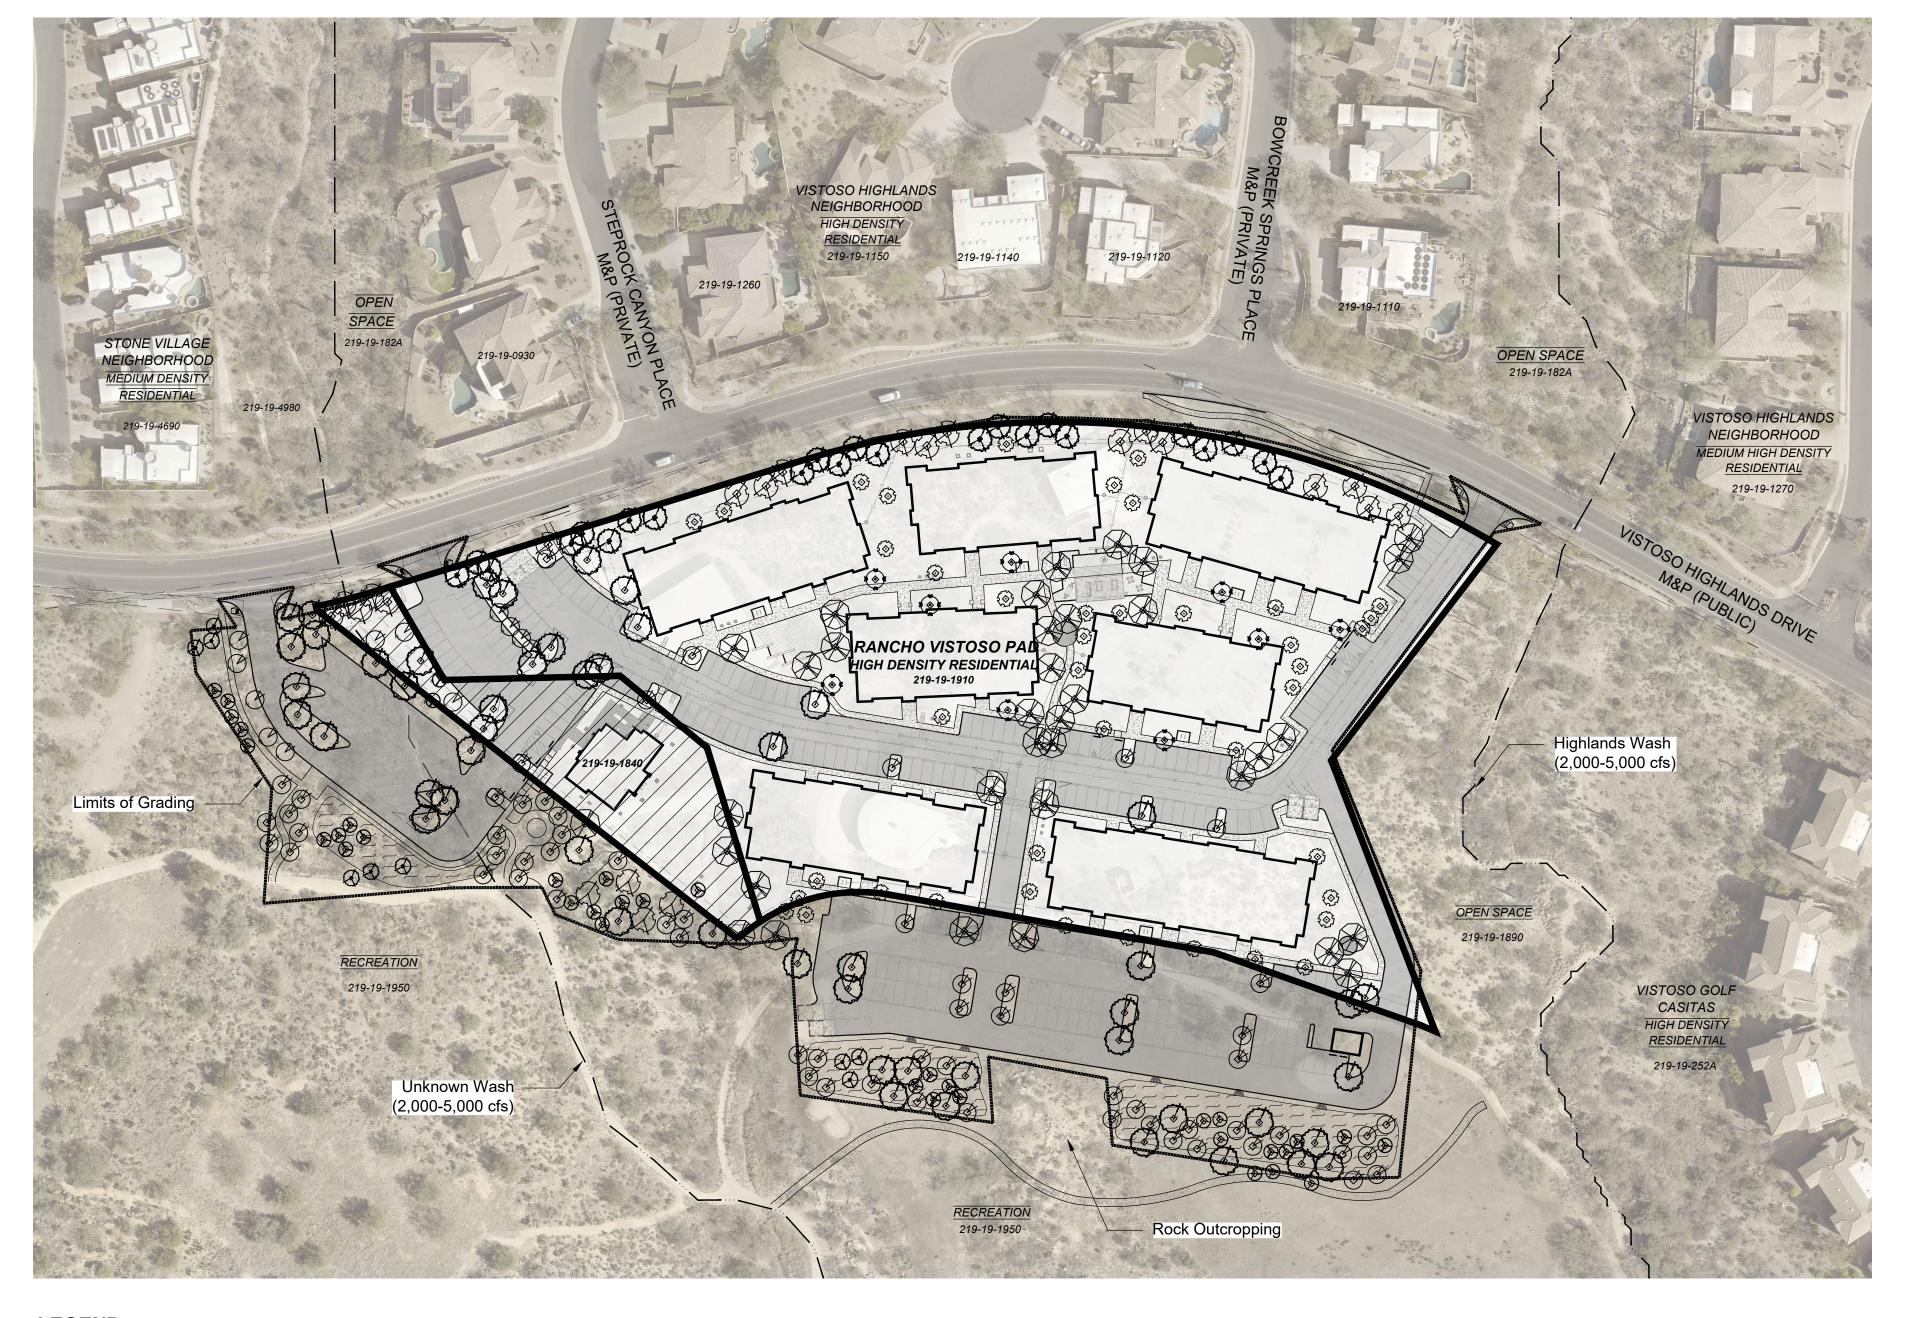

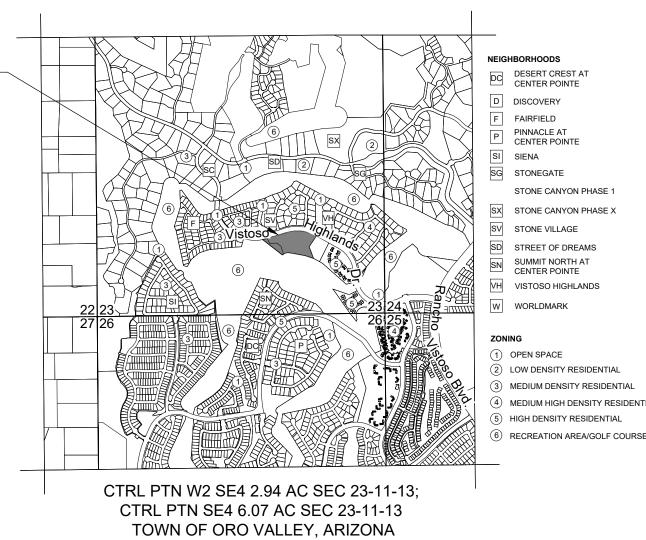

LOCATION MAP

SCALE: 3" = 1 MILE

SUMMIT NORTH AT

SHEET INDEX:

LANDSCAPE & NATIVE PLANT PACKAGE COVER THIS SHEET **EXISTING CONDITIONS PLAN** SR-0 SITE RESOURCE INVENTORY COVER SITE RESOURCE INVENTORY SR-1 NATIVE PLANT PRESERVATION PLAN COVER NATIVE PLANT PRESERVATION PLAN N-1 NATIVE PLANT PRESERVATION PLAN NATIVE PLANT PRESERVATION PLAN NATIVE PLANT PRESERVATION NOTES NATIVE PLANT INVENTORY NATIVE PLANT INVENTORY LS-0 LANDSCAPE PLAN COVER LS-1 LANDSCAPE PLAN LS-2 LANDSCAPE PLAN LANDSCAPE PLAN LANDSCAPE PLAN LANDSCAPE DETAILS RECREATION AREA & HARDSCAPE PLAN R-2 RECREATION AREA & HARDSCAPE PLAN NOTES R-3 **REC & HS PLAN RECREATION AREA #1** R-4 **REC & HS PLAN RECREATION AREA #2** R-5 REC & HS PLAN RECREATION AREA #3 R-6 REC & HS PLAN RECREATION AREA #4 & #5 R-7 HARDSCAPE & GROUNDCOVER HD-1 HARDSCAPE DETAILS HD-2 HARDSCAPE DETAILS HD-3 HARDSCAPE DETAILS HD-4 HARDSCAPE DETAILS

LEGEND

Project Boundary

SUBMITTAL HISTORY:

1ST SUBMITTAL 06/02/23 TOWN OF ORO VALLEY

PLANNING & ZONING ADMINISTRATOR

DATE

HEPLANNING CENTER e congress ste 600 tucson az 85701 520.623.6146 520.622.1950 azplanningcenter.com

PROJECT: CCD-15 DATE: 06/02/23 DRAWN BY: CJL/KDP CHECKED BY: DB

■ CALL TWO WORKING DAYS BEFORE YOU DIG 602-263-1100 1-800-STAKE-IT (OUTSIDE MARICOPA COUNTY)

| REVISIONS/SUBMITTALS

ENGINEER: RICK ENGINEERING COMPANY 3945 E. FORT LOWELL RD., SUITE 111 TUCSON, AZ 85712 ATTN: KEVIN HALL PH: (520) 795-1000


khall@rickengineering.com

DATE

ARCHITECT: a23 STUDIOS 711 EAST 9TH STREEET TUCSON, AZ 85719 ATTN: MR. BURAK BEKAT PH: (520) 903-2323

FOR AGENCY REVIEW AND APPROVAL ONLY. NOT FOR CONSTRUCTION. NOT FOR BIDDING

OWNER/DEVELOPER: OV 132, LLC 6340 N. CAMPBELL AV., SUITE 17 TUCSON, AZ 85718 ATTN: ROSS RULNEY PH: (520) 850-9300 E: info@a23studios.com E: rossrulney@gmail.com

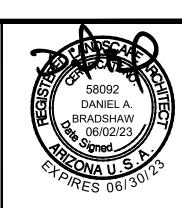


LANDSCAPE & NATIVE PLANT PACKAGE RULNEY VISTOSO RESIDENTIAL REFERENCE

A PORTION OF THE S.E. 1/4 OF SECTION 23, Township 11 South, Range 13 East G.&S.R.M., TOWN OF ORO VALLEY, PIMA COUNTY, ARIZONA

COVER


CASE NO:


CASE #

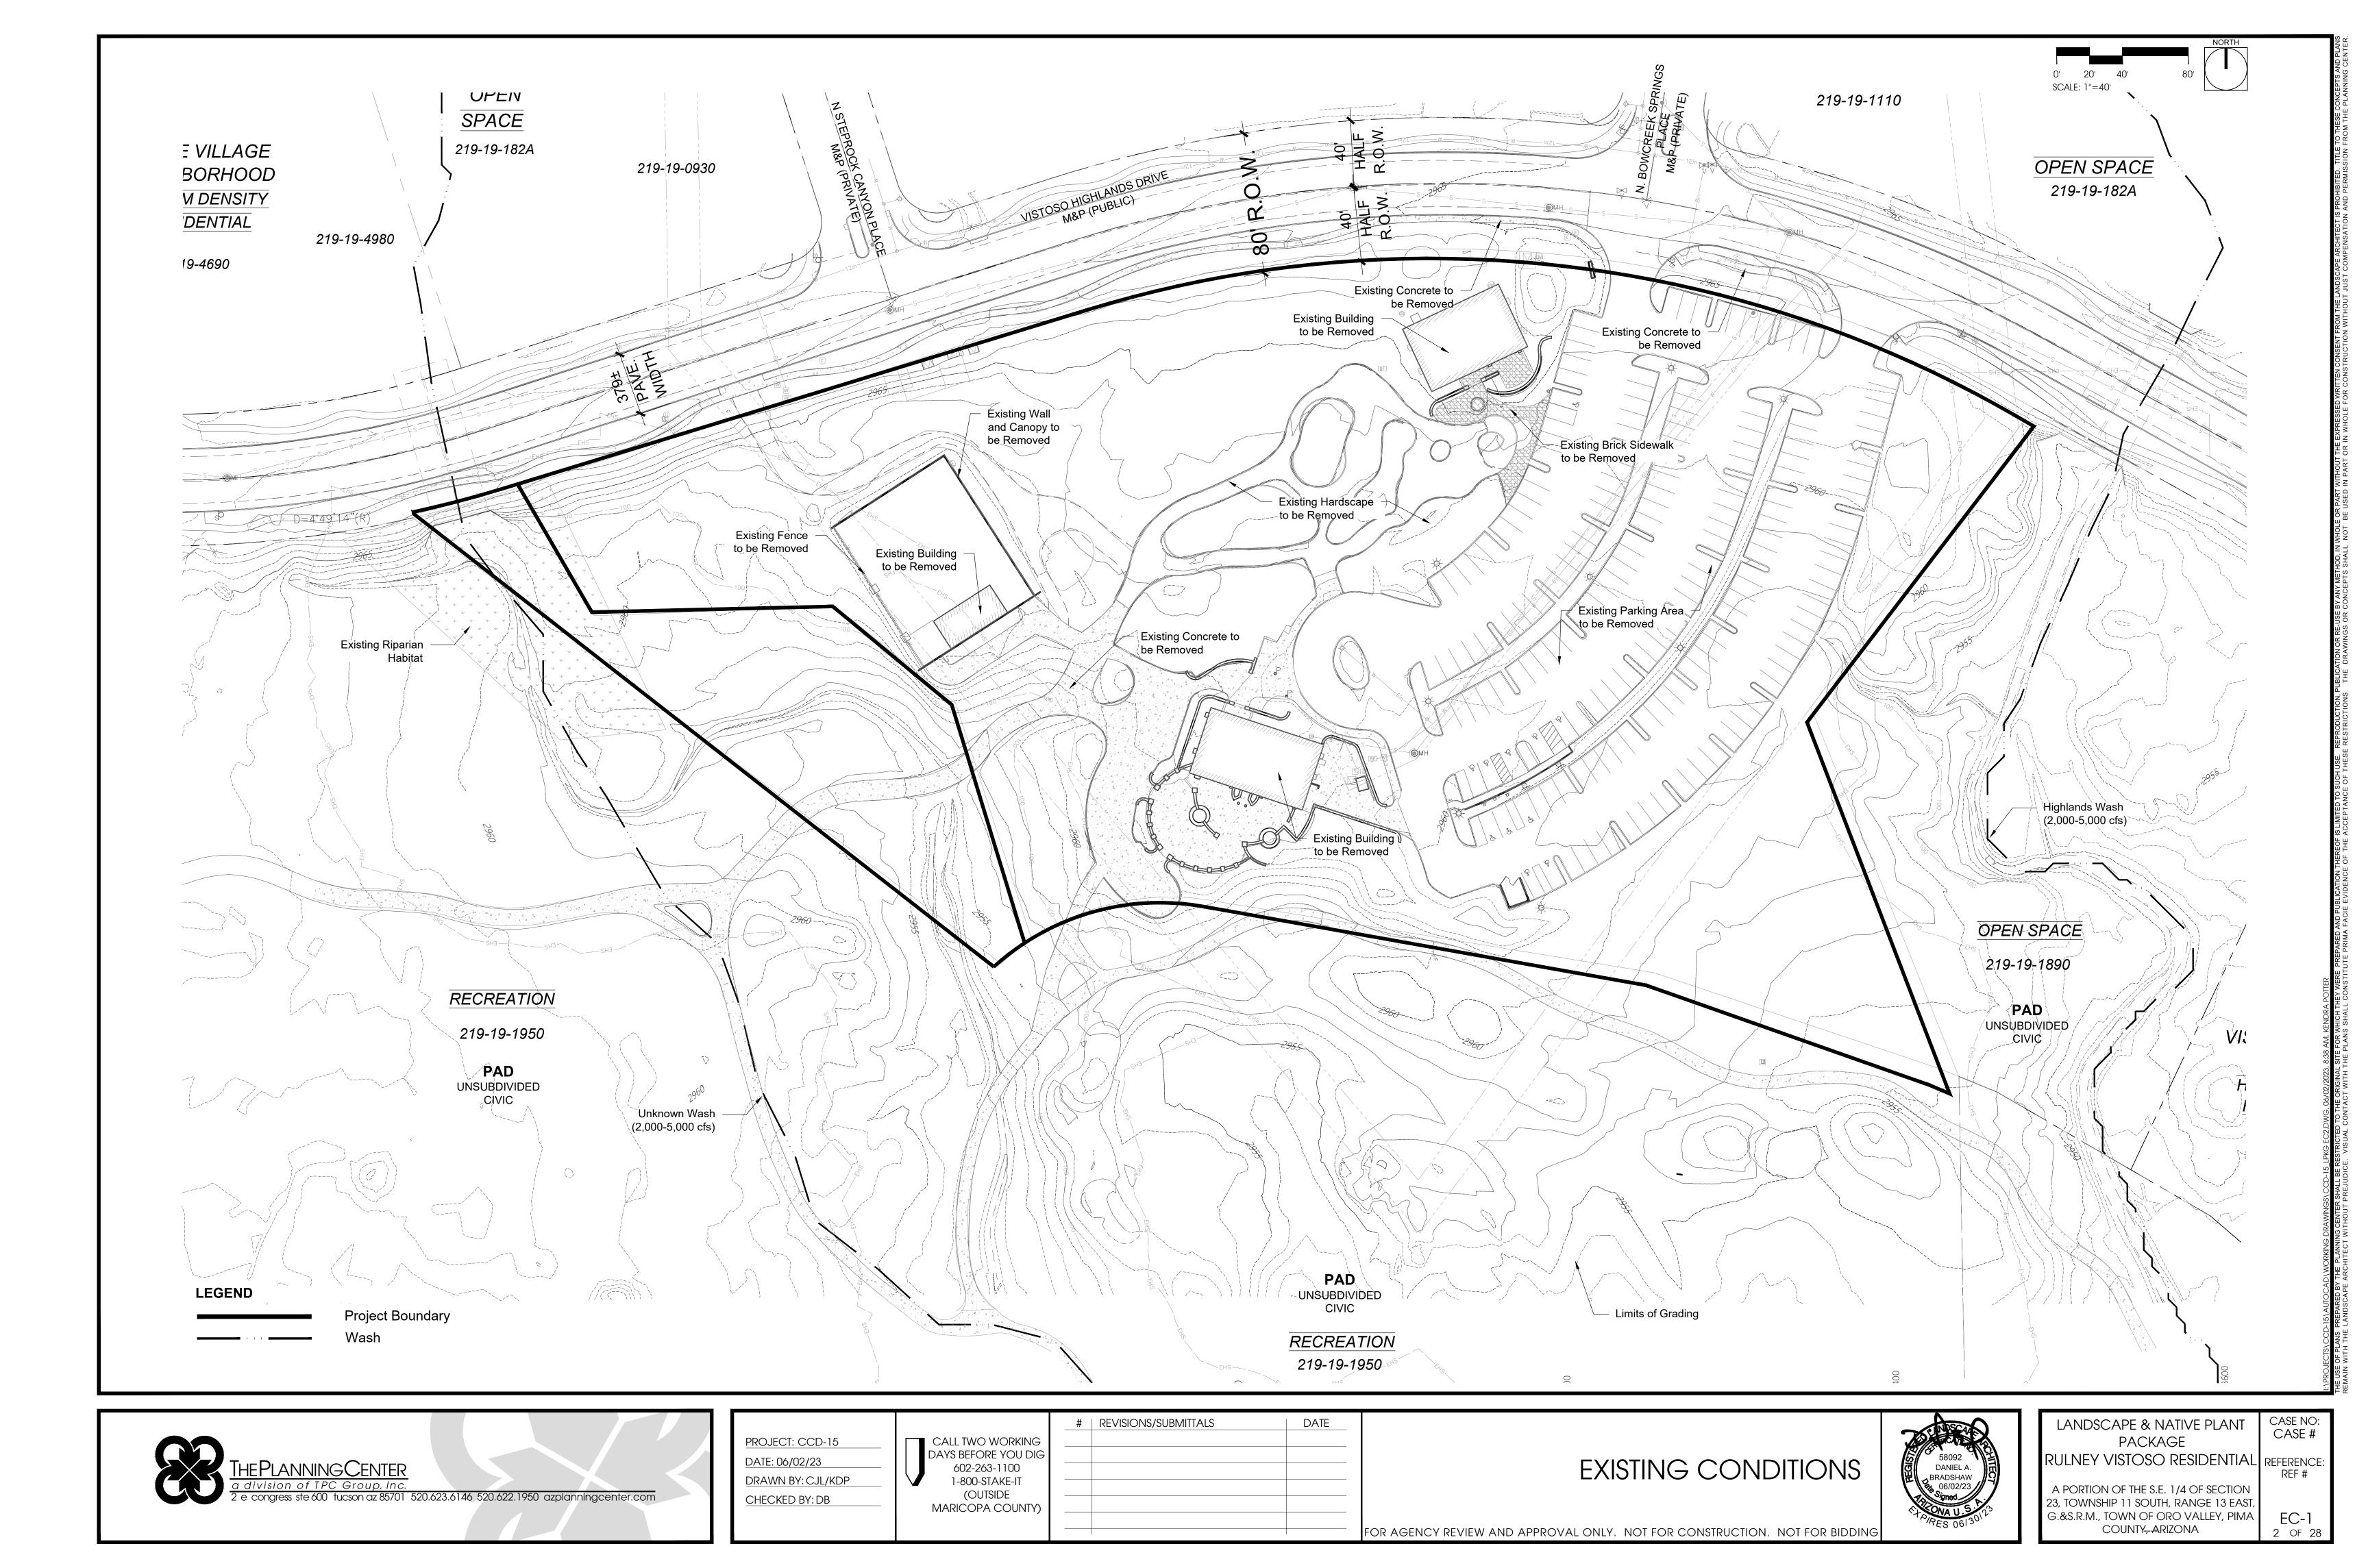


SITE RESOURCE INVENTORY RULNEY VISTOSO RESIDENTIAL


CASE #

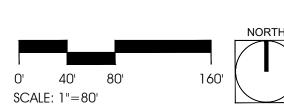

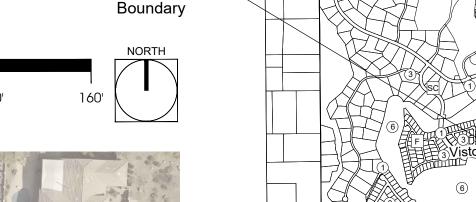

Project

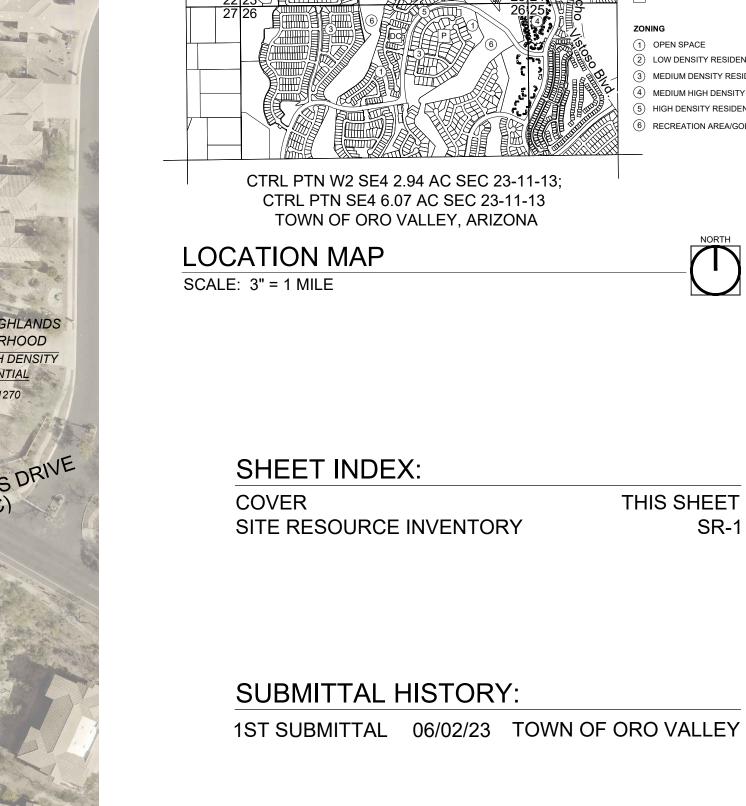

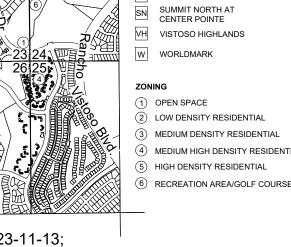

CTRL PTN W2 SE4 2.94 AC SEC 23-11-13; CTRL PTN SE4 6.07 AC SEC 23-11-13 TOWN OF ORO VALLEY, ARIZONA

LOCATION MAP

SCALE: 3" = 1 MILE



THIS SHEET

GENERAL NOTES:


- A. Gross area of development in acres: 10.7 AC (including 3.9 AC offsite work)
- B. Total acres of graded area: 10.7 AC C. Total acres of undisturbed area: none
- D. List the tag colors representing plants scheduled to be: WHITE: Preserved in Place

BLUE: Transplanted on-site YELLOW: Removed from site

- E. Any spaded or boxed tree transplanted on site that dies due to neglect or lack of maintenance shall be replaced with the same size and species of the original salvaged tree, as required by the salvage plan.
- No salvage of plants regulated by the Endangered Species Act and/or the Arizona Native Plant Law may occur without the issuance of the appropriate permit by the State Department of Agriculture.
- G. Salvage of operations shall not commence until the Zoning inspector has performed an inspection and given approval to be salvaged.
- H. A temporary nursery will not be used. Plants will be transplanted to their
- Mitigation of Significant Vegetation shall be in accordance with Table 27-1 Mitigation of Significant Vegetation. Any plant that meets the salvage criteria in Section 27.6.B.4 shall be preserved in place or transplanted on-site. Any plants that meet the salvage
- criteria that are destroyed shall be replaced on a one-to-one ratio of the same species and size as that destroyed. Five understory plants from the supplemental Arizona Department of Water Quality native plant list will be planted for every mitigated tree. K. The limits of grading shall be staked in the field, in accordance with Section
- 27.6.B.7.c.ii Disturbance outside the approved grading limits shall not be permitted.
- L. Significant Vegetation Information:
- i. Total amount present on-site (square feet): 3,518 SF
- ii. Total amount being disturbed (square feet): 3,518 SF
- iii. Total percentage disturbed 100% N. Significant Vegetation Mitigation Table

Number Removed	Botanical Name	Common Name	Mitigation Ratio	Replacement Plants	Qty	Understory Required
3	ACACIA GREGGII	CATCLAW ACACIA	2:1	48" Box	3	15
				36"Box	3	
2	CERCIDIUM FLORIDUM	BLUE PALO VERDE	2:1	48" Box	2	10
				36"Box	2	
12	CERCIDIUM MICROPHYLLUM	FOOTHILLS PALO VERDE	2:1	48" Box	12	60
				36"Box	12	
6	PROSOPIS VELUTINA	VELVET MESQUITE	2:1	48" Box	6	30
				36"Box	6	
			Total		46	115

NEIGHBORHOOD HIGH DENSITY NEIGHBORHOOD MEDIUM HIGH DENSITY RANCHO VISTOSO PAD IIGH DENSITY RESIDENTIA HIGHLANDS WASH (2,000-5,000 CFS) GRADING RECREATION 219-19-1950 VISTOSO GOLF CASITAS HIGH DENSITY **UNKNOWN WASH** (2,000-5,000 CFS) CONNECTION Pima County Pictometry 2022

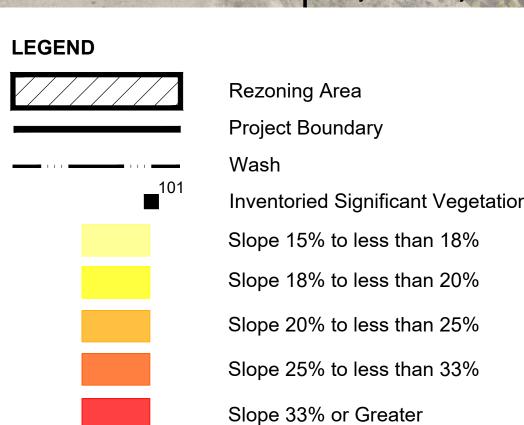

Inventoried Significant Vegetation

PLANNING & ZONING ADMINISTRATOR

DATE



PROJECT: CCD-15 DATE: 06/02/23 DRAWN BY: CJL/KDP CHECKED BY: DB

■ CALL TWO WORKING DAYS BEFORE YOU DIG 602-263-1100 1-800-STAKE-IT (OUTSIDE MARICOPA COUNTY)

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		,

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DANIEL A. FOR AGENCY REVIEW AND APPROVAL ONLY. NOT FOR CONSTRUCTION. NOT FOR BIDDING

SITE RESOURCE INVENTORY

RULNEY VISTOSO REFERENCE RESIDENTIAL A PORTION OF THE S.E. 1/4 OF SECTION 23, TOWNSHIP 11 SOUTH, RANGE 13 EAST G.&S.R.M., TOWN OF ORO VALLEY, PIMA COUNTY, ARIZONA

3 OF 28

CASE NO:

CASE #

SRI NOTES:

- 1. The extents of this SRI include APNs: 219-19-1910; APN 219-19-1840; and APN 219-19-1950 (including trailhead area.)
- 2. There are no Distinct Native Plant Stands on-site.
- 3. This aerial photo is less than two years old.
- 4. The site features a combination of constructed and native landscape. Areas of constructed landscape are excluded from this inventory.
- 5. Native Plant species present include: Whitethorn Acacia (Acacia constricta,) Catclaw Acacia (Acacia greggii,) Saguaros (Carnegia gigantea,) Desert Hackberry (Celtis pallida,) Blue Palo Verde (Cercidium Floridum,) Foothills Palo Verde Trees (Cercidium microphyllum,) Fishhook Barrel Cactus (Ferocactus wislizenii,) Ocotillo (Fouquieria splendens,) Ironwood Trees (Olneya Tesota,) Velvet Mesquite Trees (Prosopis velutina.)
- 6. The significant species are identified on the map.
- 7. Disposition of vegetation is subject to change based on final improvement plans and engineering.

SIGNIFICANT VEGETATION INVENTORY

ID#	BOTANICAL NAME	COMMON NAME	HEIGHT(FT)	CALIPER(IN)	TAG	TREATMENT	REASONS	
509	PROSOPIS VELUTINA	VELVET MESQUITE	12	18	YELLOW	RFS	NOT SALVAGEABLE	LG SIZE/POOR SOIL CONDITIONS
510	PROSOPIS VELUTINA	VELVET MESQUITE	15	22	YELLOW	RFS	NOT SALVAGEABLE	LG SIZE/POOR SOIL CONDITIONS
516	CERCIDIUM FLORIDUM	BLUE PALO VERDE	15	12	YELLOW	RFS	NOT SALVAGEABLE	LG SIZE/POOR SOIL CONDITIONS
522	PROSOPIS VELUTINA	VELVET MESQUITE	12	14	YELLOW	RFS	NOT SALVAGEABLE	LG SIZE/POOR SOIL CONDITIONS
605	CERCIDIUM MICROPHYLLUM	FOOTHILLS PALO VERDE	15	12	YELLOW	RFS	DEAD TRUNK	DEAD LIMB
606	PROSOPIS VELUTINA	VELVET MESQUITE	12	12	YELLOW	RFS	DIEBACK	DEAD TRUNK
607	CERCIDIUM MICROPHYLLUM	FOOTHILLS PALO VERDE	12	12	YELLOW	RFS	NOT SALVAGEABLE	LG SIZE/POOR SOIL CONDITIONS
608	CERCIDIUM MICROPHYLLUM	FOOTHILLS PALO VERDE	12	12	YELLOW	RFS	NOT SALVAGEABLE	LG SIZE/POOR SOIL CONDITIONS
609	CERCIDIUM MICROPHYLLUM	FOOTHILLS PALO VERDE	12	16	YELLOW	RFS	DEAD TRUNK	DEAD LIMB
610	CERCIDIUM MICROPHYLLUM	FOOTHILLS PALO VERDE	14	12	YELLOW	RFS	DEAD TRUNK	DEAD LIMB
611	ACACIA GREGGII	CATCLAW ACACIA	15	12	YELLOW	RFS	NOT SALVAGEABLE	LG SIZE/POOR SOIL CONDITIONS
612	CERCIDIUM MICROPHYLLUM	FOOTHILLS PALO VERDE	16	15	YELLOW	RFS	NOT SALVAGEABLE	LG SIZE/POOR SOIL CONDITIONS
613	CERCIDIUM MICROPHYLLUM	FOOTHILLS PALO VERDE	17	14	YELLOW	RFS	NOT SALVAGEABLE	LG SIZE/POOR SOIL CONDITIONS
614	CERCIDIUM MICROPHYLLUM	FOOTHILLS PALO VERDE	15	14	YELLOW	RFS	NOT SALVAGEABLE	LG SIZE/POOR SOIL CONDITIONS
615	ACACIA GREGGII	CATCLAW ACACIA	16	14	YELLOW	RFS	NOT SALVAGEABLE	LG SIZE/POOR SOIL CONDITIONS
616	CERCIDIUM MICROPHYLLUM	FOOTHILLS PALO VERDE	15	14	YELLOW	RFS	NOT SALVAGEABLE	LG SIZE/POOR SOIL CONDITIONS
617	CERCIDIUM FLORIDUM	BLUE PALO VERDE	16	14	YELLOW	RFS	NOT SALVAGEABLE	LG SIZE/POOR SOIL CONDITIONS
618	PROSOPIS VELUTINA	VELVET MESQUITE	19	17	YELLOW	RFS	NOT SALVAGEABLE	LG SIZE/POOR SOIL CONDITIONS
619	CERCIDIUM MICROPHYLLUM	FOOTHILLS PALO VERDE	15	20	YELLOW	RFS	DEAD TRUNK	DEAD LIMB
620	ACACIA GREGGII	CATCLAW ACACIA	18	15	YELLOW	RFS	NOT SALVAGEABLE	LG SIZE/POOR SOIL CONDITIONS
621	CERCIDIUM MICROPHYLLUM	FOOTHILLS PALO VERDE	14	12	YELLOW	RFS	NOT SALVAGEABLE	LG SIZE/POOR SOIL CONDITIONS
S101	PROSOPIS VELUTINA	VELVET MESQUITE	12	14	YELLOW	RFS	DIEBACK	PRIMARY BRANCH DEAD
S102	CERCIDIUM MICROPHYLLUM	FOOTHILLS PALO VERDE	18	30	YELLOW	RFS	DIEBACK	BAD BASE

NOTE: A SIGNIFICANT VEGETATION ID# PREFIXED WITH "S" IS A TAG DISTINGUISHING A PLANT FROM ONE ON THE NATIVE PLANT INVENTORY WITH A SIMILAR ID#.

TREATMENT LEGEND

PIP: Preserved in Place (White Tag) TOS: Transplanted on-site (Blue Tag) RFS: Removed from site (Yellow Tag)



PROJECT: CCD-15 DATE: 06/02/23 DRAWN BY: CJL/KDP CHECKED BY: DB

CALL TWO WORKING DAYS BEFORE YOU DIG 602-263-1100 1-800-STAKE-IT (OUTSIDE MARICOPA COUNTY)

| REVISIONS/SUBMITTALS DATE



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SITE RESOURCE INVENTORY RULNEY VISTOSO REFERENCE: REF # RESIDENTIAL


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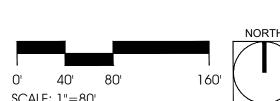
SR-1 4 OF 28


CASE NO: CASE #

NATIVE PLANT PRESERVATION PLAN RULNEY VISTOSO RESIDENTIAL

CASE #



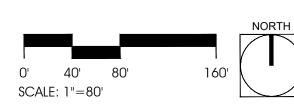

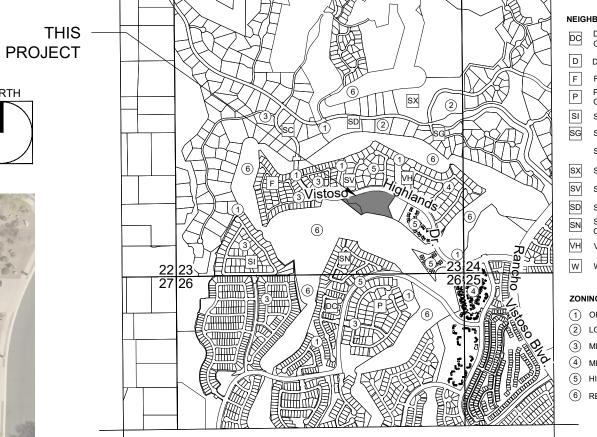

CTRL PTN W2 SE4 2.94 AC SEC 23-11-13; CTRL PTN SE4 6.07 AC SEC 23-11-13 TOWN OF ORO VALLEY, ARIZONA

LOCATION MAP


SCALE: 3" = 1 MILE



GENERAL NOTES:

- A. Gross area of development in acres: 10.7 AC (including 3.9 AC offsite
- B. Total acres of graded area: 10.7 AC
- C. Total acres of undisturbed area: none D. List the tag colors representing plants scheduled to be:
- White Tag: Preserved in Place Blue Tag: Transplanted on-site
- E. Any spaded or boxed tree transplanted on site that dies due to neglect or lack of maintenance shall be replaced with the same size and species of the original salvaged tree, as required by the salvage plan. No salvage of plants regulated by the Endangered Species Act and/or
- the Arizona Native Plant Law may occur without the issuance of the appropriate permit by the State Department of Agriculture. G. Salvage of operations shall not commence until the Zoning inspector
- has performed an inspection and given approval to be salvaged. H. Temporary nursery shall be in conformance with Section 7.6.B.4.j.
- Mitigation of Significant Vegetation shall be in accordance with Table 27-1 Mitigation of Significant Vegetation.
- J. Any plant that meets the salvage criteria in Section 27.6.B.4 shall be preserved in place or transplanted on-site. Any plants that meet the salvage criteria that are destroyed shall be replaced on a one-to-one ratio of the same species and size as that destroyed. Five understory plants from the supplemental Arizona Department of Water Quality native plant list will be planted for every mitigated tree.
- K. The limits of grading shall be staked in the field, in accordance with Section 27.6.B.7.c.ii Disturbance outside the approved grading limits
- shall not be permitted. L. Significant Vegetation Information:
 - i. Total amount present on-site (square feet): 3,518 SF
 - ii. Total amount being disturbed (square feet): 3,518 SF iii. Total percentage disturbed 100%
- Native Plant Summary Table

Botanical	Common		Remove	Preserve	Total
Name	Name	Transplant	from Site	in Place	per Plant
ACACIA CONTRICTA	WHITETHORN ACACIA	1	11	0	12
ACACIA GREGGII	CATCLAW ACACIA	2	26	0	28
CARNEGIEA GIGANTEA	SAGUARO	14	1	0	15
CELTIS PALLIDA	DESERT HACKBERRY	1	5	0	6
CERCIDIUM FLORIDUM	BLUE PALO VERDE	2	3	0	5
CERCIDIUM	FOOTHILLS PALO				
MICROPHYLLUM	VERDE	12	66	0	78
FEROCACTUS WISLIZENII	FISHHOOK BARREL	65	32	0	97
FOUQUIERIA SPLENDENS	OCOTILLO	18	2	0	20
OLNEYA TESOTA	IRONWOOD	2	7	0	9
PROSOPIS VELUTINA	VELVET MESQUITE	2	30	0	32
YUCCA ELATA	SOAPTREE YUCCA	1	0	0	1
ZIZIPHUS OBTUSIFOLIA	GRAYTHORN	0	3	0	3
	Total	120	186	0	306

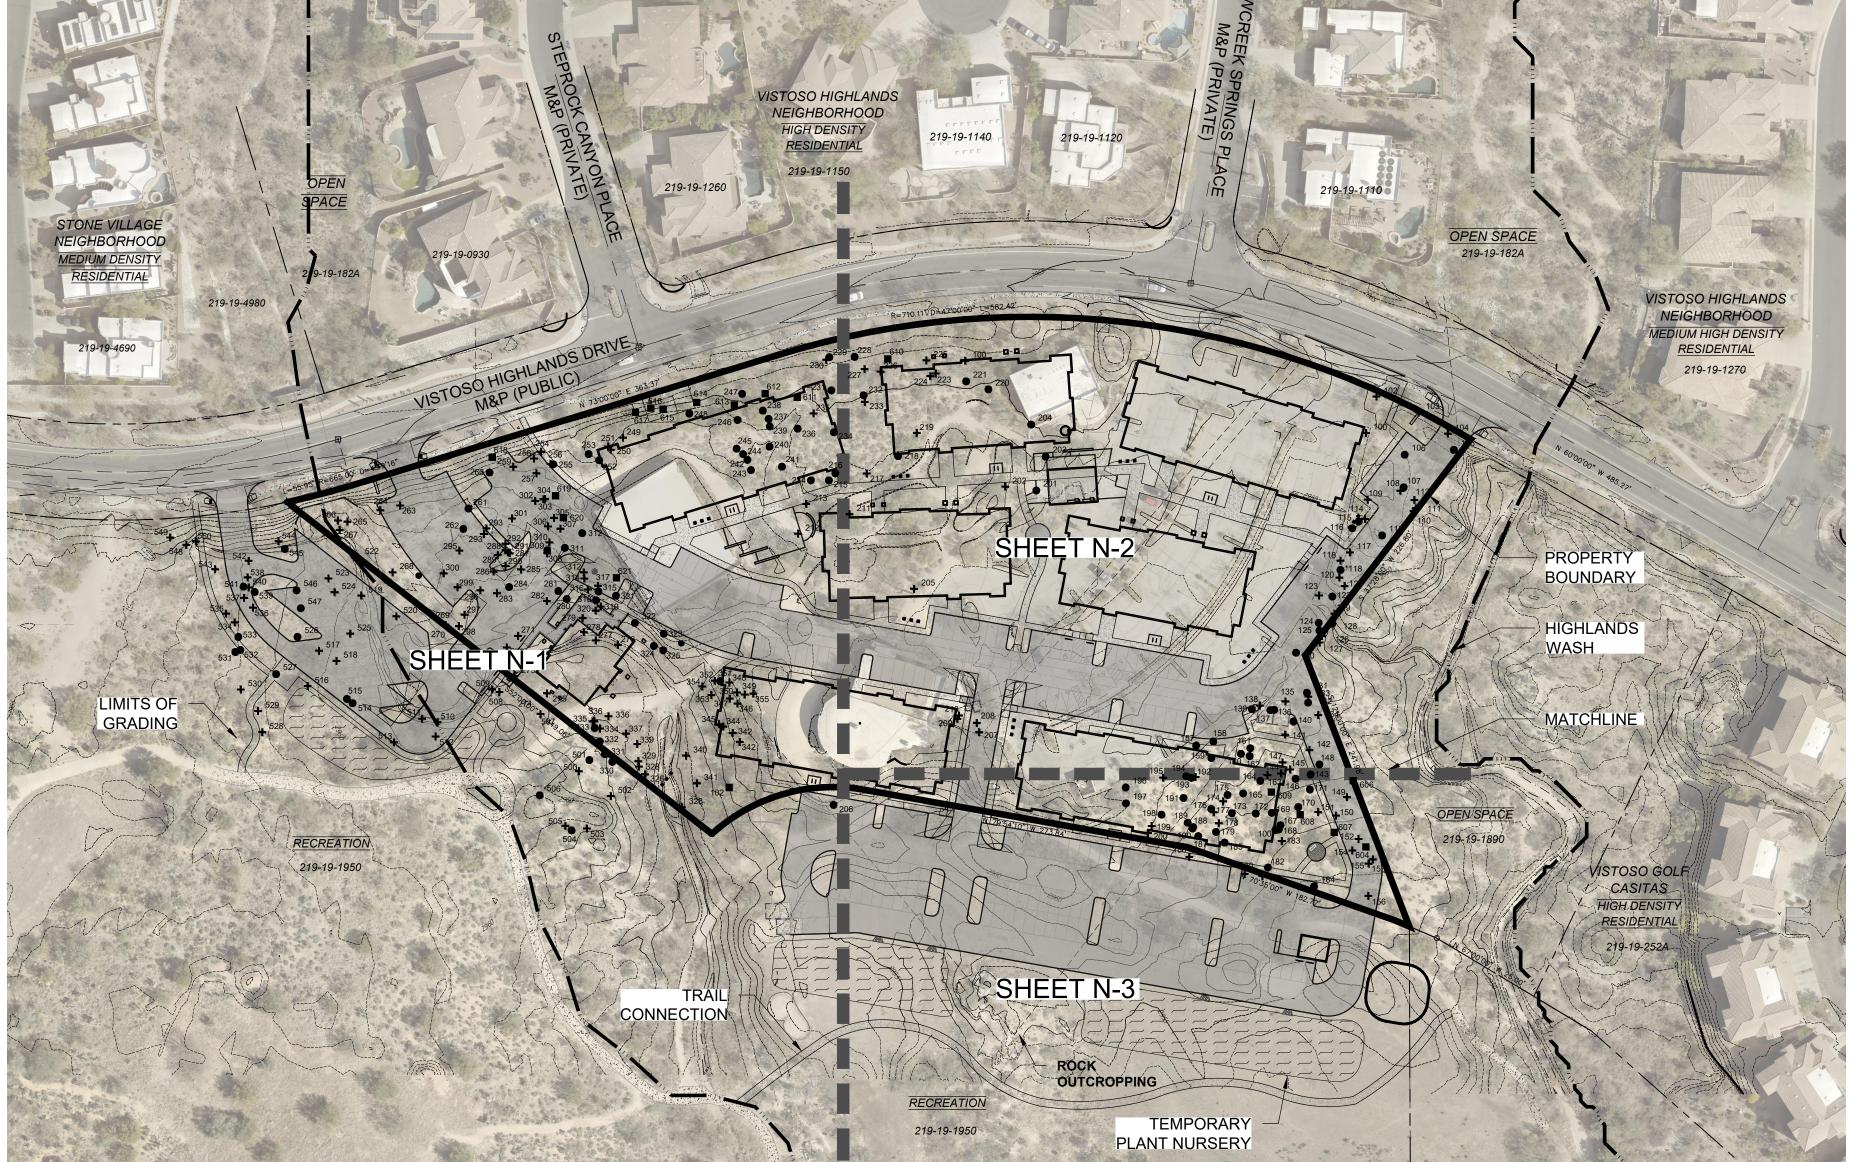

LEGEND Project Boundary Plant Preserved in Place Transplant on Site Remove from Site 2' Contour Interval

SHEET INDEX:

COVER	THIS SHEE
NATIVE PLANT PRESERVATION PLAN	N-
NATIVE PLANT PRESERVATION PLAN	N-
NATIVE PLANT PRESERVATION PLAN	N-
NPPO NOTES	N-
NATIVE PLANT INVENTORY	N-:
NATIVE PLANT INVENTORY	N-

SUBMITTAL HISTORY:

1ST SUBMITTAL 06/02/23 TOWN OF ORO VALLEY

PLANNING & ZONING ADMINISTRATOR



PROJECT: CCD-15 DATE: 06/02/23 DRAWN BY: CJL/KDP CHECKED BY: DB

■ CALL TWO WORKING DAYS BEFORE YOU DIG 602-263-1100 1-800-STAKE-IT (OUTSIDE MARICOPA COUNTY)

_	#	REVISIONS/SUBMITTALS	DATE
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ENGINEER: RICK ENGINEERING COMPANY 3945 E. FORT LOWELL RD., SUITE 111 TUCSON, AZ 85712 ATTN: KEVIN HALL PH: (520) 795-1000 khall@rickengineering.com

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NATIVE PLANT PRESERVATION RULNEY VISTOSO RESIDENTIAL


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CASE NO:

CASE #

REFERENCE

DATE



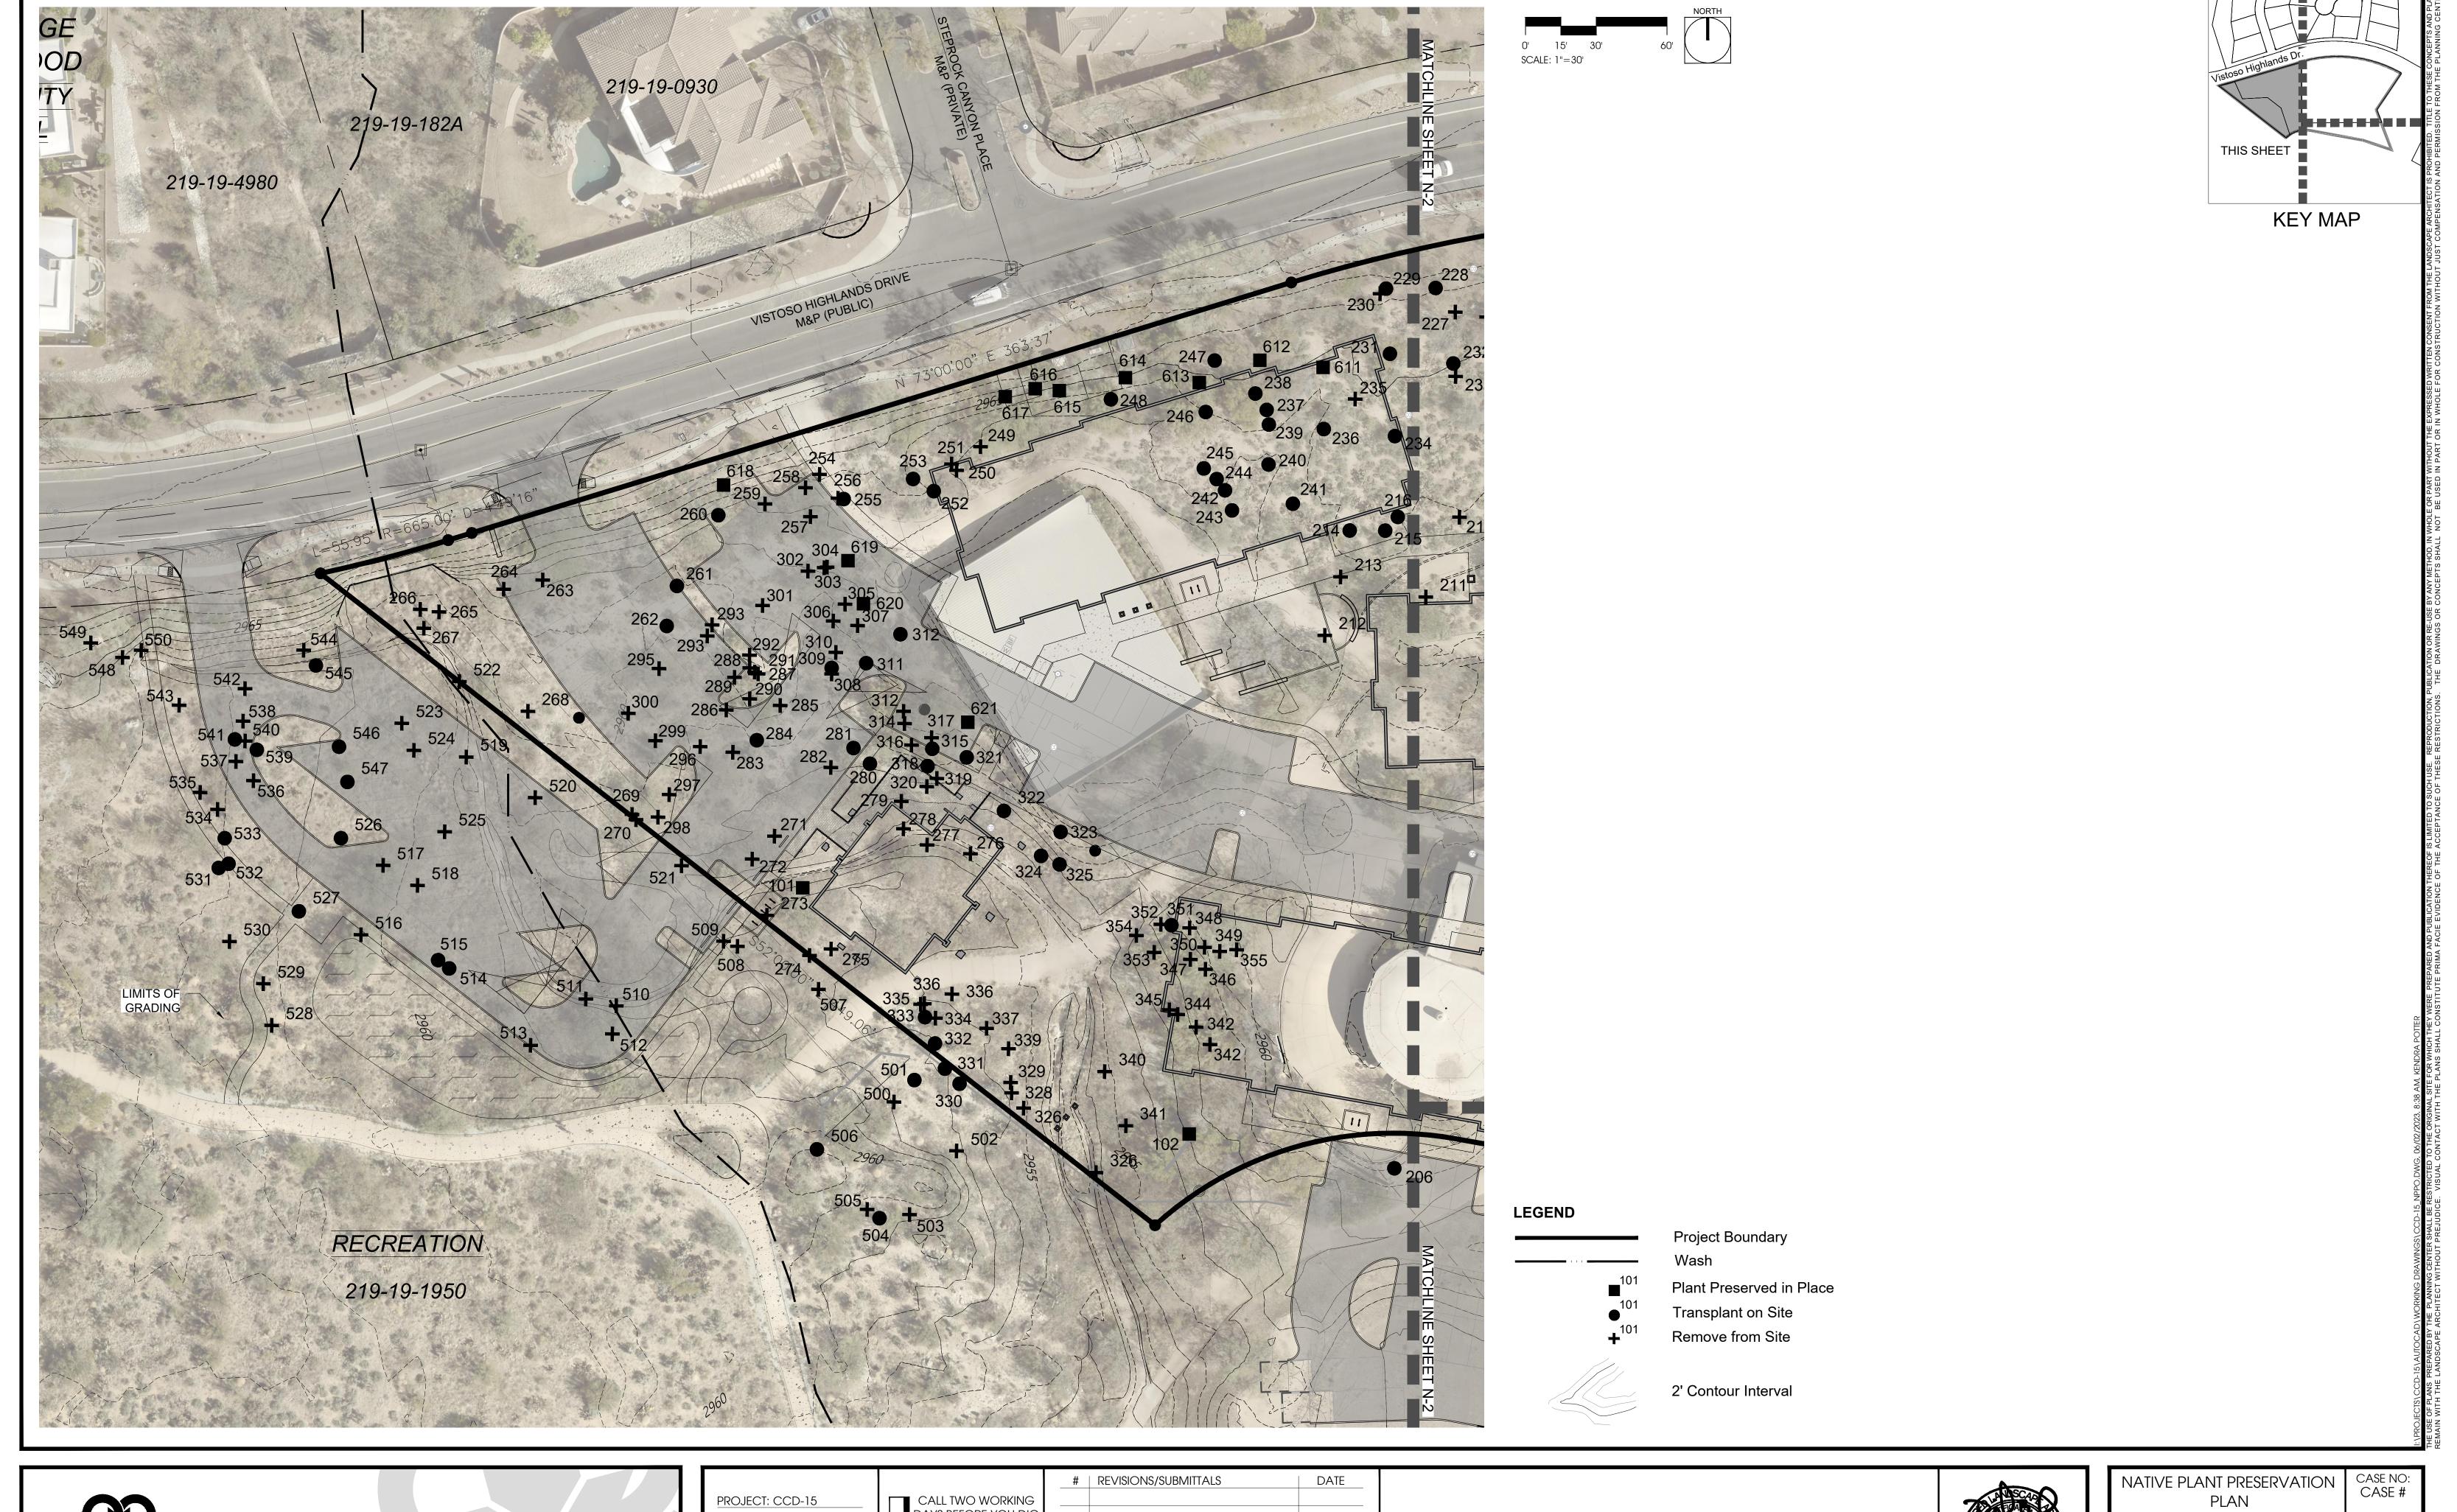

DATE: 06/02/23 DRAWN BY: CJL/KDP CHECKED BY: DB

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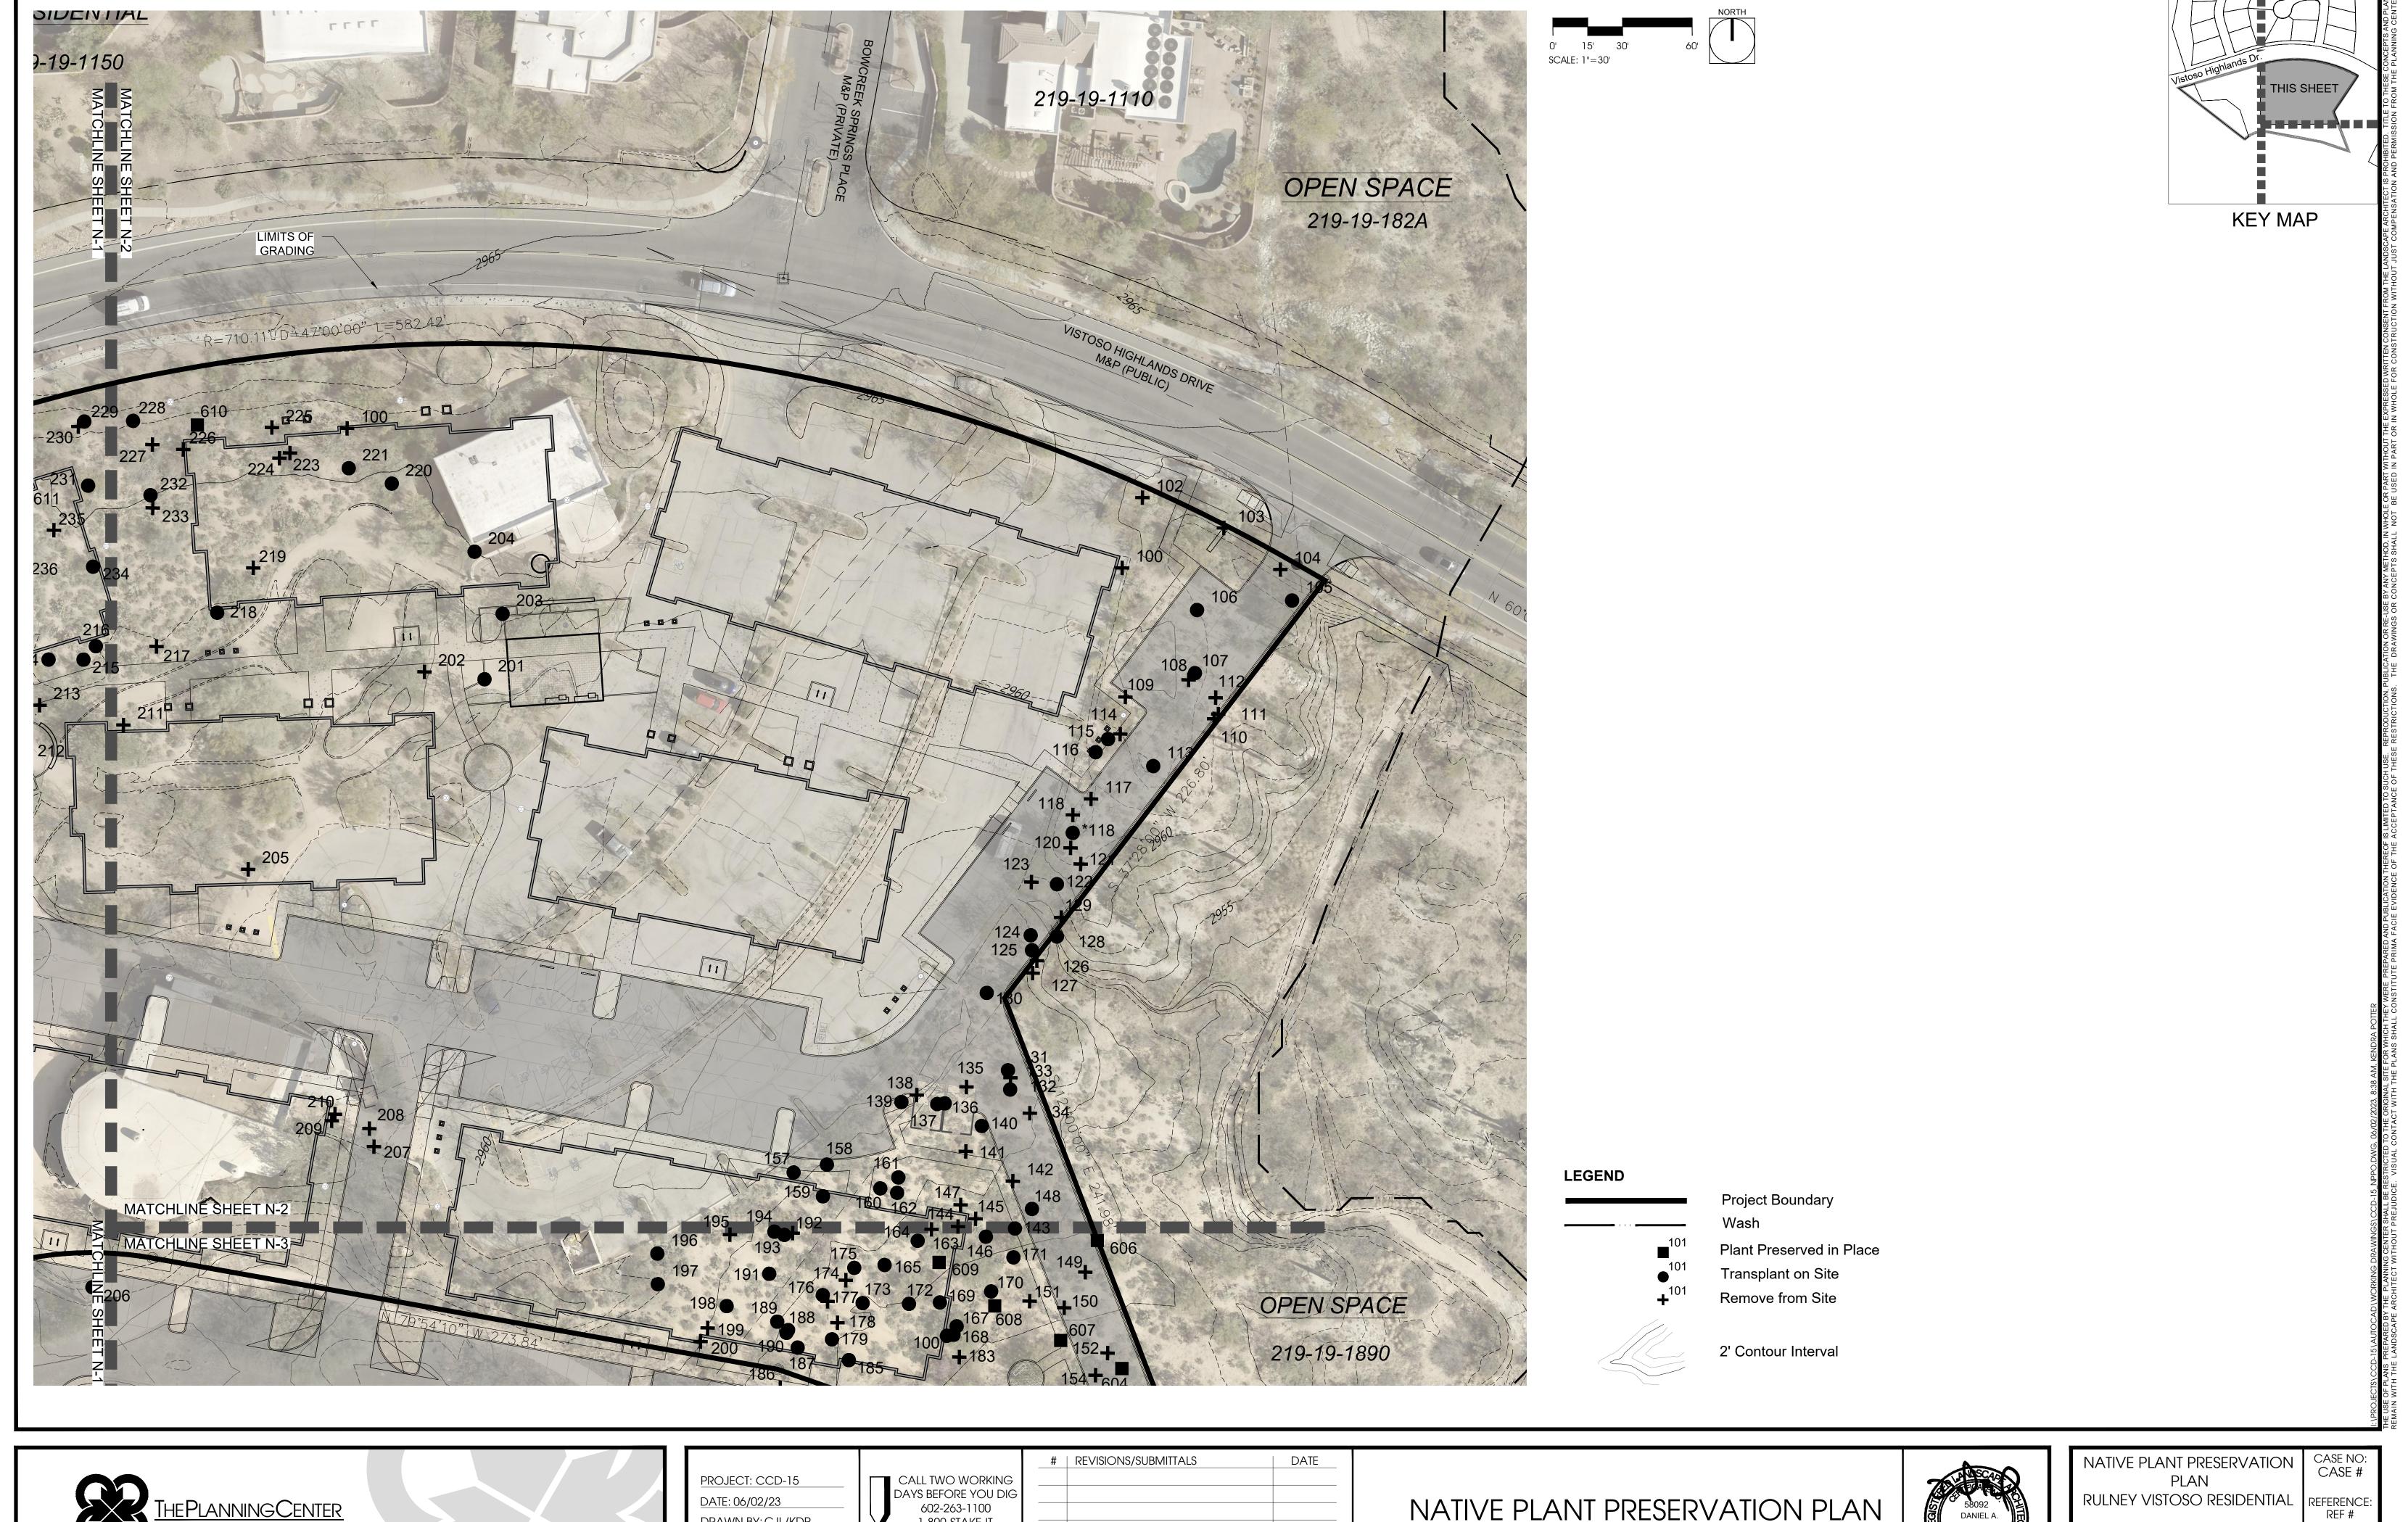


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NATIVE PLANT PRESERVATION PLAN RULNEY VISTOSO RESIDENTIAL REFERENCE: REF #

A PORTION OF THE S.E. 1/4 OF SECTION 23, TOWNSHIP 11 SOUTH, RANGE 13 EAST, G.&S.R.M., TOWN OF ORO VALLEY, PIMA COUNTY, ARIZONA






DATE: 06/02/23 602-263-1100 1-800-STAKE-IT DRAWN BY: CJL/KDP (OUTSIDE MARICOPA COUNTY) CHECKED BY: DB

NATIVE PLANT PRESERVATION PLAN

FOR AGENCY REVIEW AND APPROVAL ONLY. NOT FOR CONSTRUCTION. NOT FOR BIDDING

RULNEY VISTOSO RESIDENTIAL

A PORTION OF THE S.E. 1/4 OF SECTION 23, TOWNSHIP 11 SOUTH, RANGE 13 EAST, G.&S.R.M., TOWN OF ORO VALLEY, PIMA COUNTY, ARIZONA

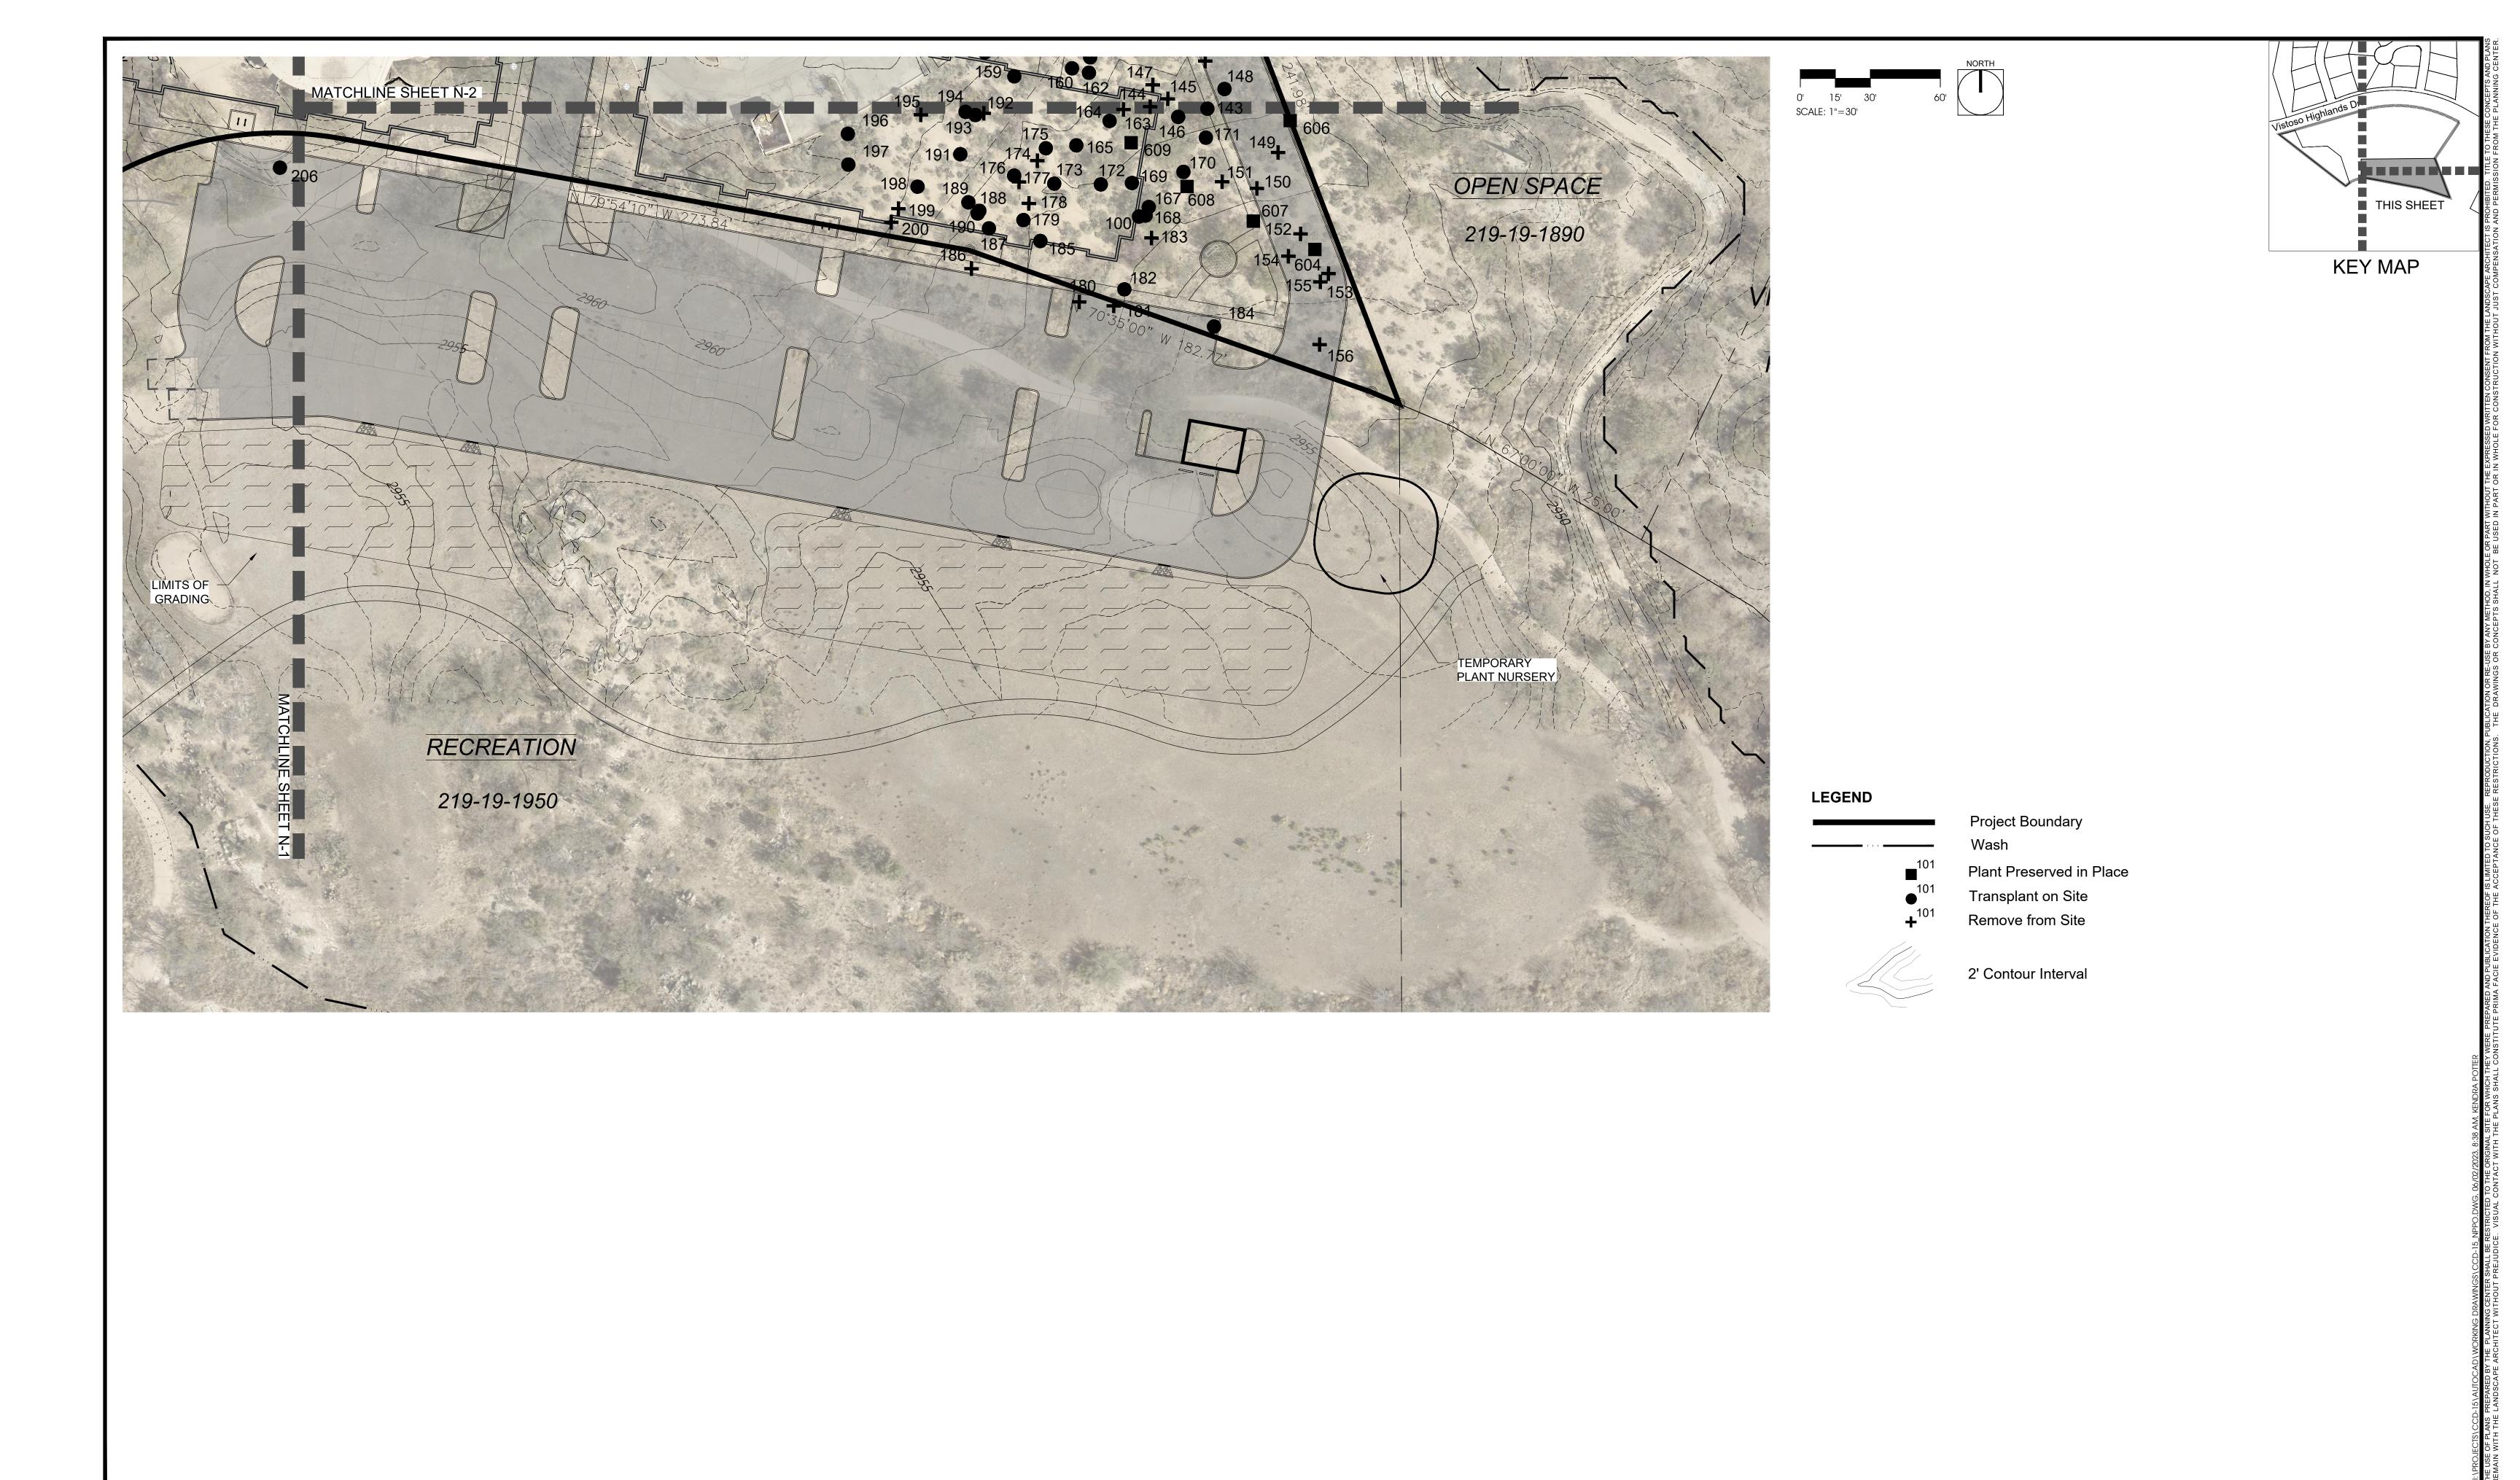



PROJECT: CCD-15	CALL TWO WC
PATE: 06/02/23	DAYS BEFORE Y
PATE: 00/02/23	602-263-11
DRAWN BY: CJL/KDP	1-800-STAKI
CHECKED BY: DB	(OUTSIDE
CHECKED BY. DB	MARICOPA CO

	#	REVISIONS/SUBMITTALS	DATE	
ORKING YOU DIG				
1100				NATIVE PLANT PRESERVATION PLAN
KE-IT				
COUNTY)				
				FOR AGENCY REVIEW AND APPROVAL ONLY. NOT FOR CONSTRUCTION. NOT FOR BIDDING





NATIVE PLANT PRESERVATION PLAN RULNEY VISTOSO RESIDENTIAL REFERENCE: 'REF #

A PORTION OF THE S.E. 1/4 OF SECTION 23, TOWNSHIP 11 SOUTH, RANGE 13 EAST, G.&S.R.M., TOWN OF ORO VALLEY, PIMA COUNTY, ARIZONA

CASE NO: CASE #

1. MITIGATION MEASURES AND PROCEDURES

ALL SPECIES THAT ARE IDENTIFIED AS SALVAGEABLE WILL BE SALVAGED DURING THE COURSE OF THIS PROJECT AND UTILIZED ON SITE. THE PREFERRED METHOD OF TREE SALVAGE IS THE SPADE SALVAGE TECHNIQUE TO BE USED FOR THIS PROJECT.

ALL TREES WHOSE CALIPER IS LESS THAN 6 INCHES MAY BE SALVAGED WITH A TREE SPADE. THIS ASSUMES THAT AN 60 INCH SPADE WILL BE USED FOR THE OPERATION AND THAT SOIL CONDITIONS ON THE SITE ARE AMENABLE TO SPADING. SPECIES SALVAGED WITH THE SPADE WILL BE MOVED ONLY ONE TIME - TO THEIR FINAL PLANTING LOCATION. THIS WILL REQUIRE CAREFUL COORDINATION BETWEEN THE PROJECT MANAGER, GRADING CONTRACTOR AND SPADE CONTRACTOR. THIS INCREASED EFFORT IS WARRANTED BY SIGNIFICANT COST SAVINGS OF A ONE MOVE SPADE OPERATION AND INCREASED SURVIVAL RATES ASSOCIATED WITH MOVING TREES ONLY ONCE WITH A SPADE AS OPPOSED TO MOVING THEM TWICE - ONCE TO A TEMPORARY HOLDING YARD AND THEN A SECOND TIME TO THE FINAL PLANTED LOCATION.

ALL SALVAGED SPECIES WILL BE PROVIDED WITH TEMPORARY IRRIGATION AT THE HOLDING NURSERY AND PERMANENT IRRIGATION WHEN TRANSPLANTED TO THEIR FINAL LOCATION. AREAS WHERE SALVAGED SPECIES WILL BE TRANSPLANTED INCLUDE LANDSCAPED BUFFERYARDS, ENTRY MONUMENTATION, AND OTHER HIGHLY VISIBLE LANDSCAPED AREA. SALVAGE CONTRACTORS WILL BE RESPONSIBLE FOR GUARANTEEING ALL SALVAGED PLANT MATERIAL FOR A MINIMUM OF ONE YEAR IN THE HOLDING NURSERY AND FOR 90 DAYS ONCE TRANSPLANTED.


ALL SALVAGEABLE PLANT SPECIES THAT ARE DAMAGED THROUGH CONSTRUCTION OR TRANSPLANTING OPERATION WILL BE REPLACED WITH CONTAINERIZED NURSERY STOCK MATERIALS OF THE SAME SIZE, GENUS AND SPECIES AT A RATIO OF 1:1 EXISTING SPECIMEN TO NURSERY STOCK PER CHAPTER 18.72. ALL NURSERY STOCK MATERIALS WILL BE PLACED ON A TEMPORARY IRRIGATION SYSTEM UNTIL ESTABLISHED (APPROXIMATELY 5 YEARS). ALL SALVAGED MATERIAL WILL REQUIRE PERMANENT IRRIGATION.

2. PRUNING

LIMIT PRUNING TO LESS THAN 15% OF THE TOTAL TREE CANOPY. THE OBJECTIVE IS TO PROVIDE AN AESTHETIC FRAMEWORK OF BRANCHES THAT PRESERVES THE ORIGINAL NATURAL FEATURES OF THE TREE BEING SALVAGED. RESTRICT PRUNING TO THE SMALLEST POSSIBLE CUT JUST OUTSIDE OF THE BRANCH COLLAR. DO NOT PRUNE INTERIOR FOLIAGE. USE CLEAN TOOLS ONLY. PRUNE OUT ALL DEAD WOOD AND MISTLETOE.

3. IRRIGATION OF SALVAGED PLANTS

IRRIGATION IN THE TEMPORARY HOLDING AREA WILL BE BY PVC / POLYETHYLENE DRIP SYSTEM CONFORMING TO PIMA COUNTY CODE, WITH A MANUAL OR AUTOMATIC CONTROL VALVE. THE SYSTEM WILL LATER BE ABANDONED / REMOVED.

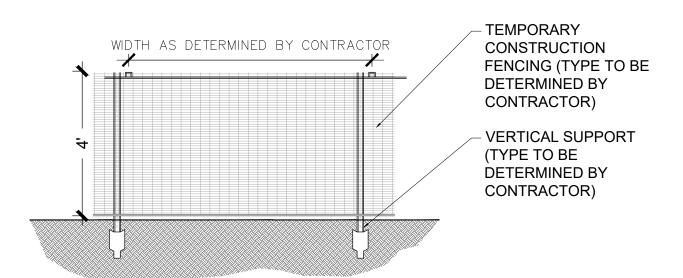

NOTES:

1. TEMPORARY CONSTRUCTION FENCING TO BE PLACED AT LIMITS OF GRADING TO PROTECT EXISTING VEGETATION.

SCALE: NTS



SIGNIFICANT VEGETATION INVENTORY

ID#	BOTANICAL NAME	COMMON NAME	HEIGHT(FT)	CALIPER(IN)	TAG	TREATMENT	REASONS	
509	PROSOPIS VELUTINA	VELVET MESQUITE	12	18	YELLOW	RFS	NOT SALVAGEABLE	LG SIZE/POOR SOIL CONDITIONS
510	PROSOPIS VELUTINA	VELVET MESQUITE	15	22	YELLOW	RFS	NOT SALVAGEABLE	LG SIZE/POOR SOIL CONDITIONS
516	CERCIDIUM FLORIDUM	BLUE PALO VERDE	15	12	YELLOW	RFS	NOT SALVAGEABLE	LG SIZE/POOR SOIL CONDITIONS
522	PROSOPIS VELUTINA	VELVET MESQUITE	12	14	YELLOW	RFS	NOT SALVAGEABLE	LG SIZE/POOR SOIL CONDITIONS
605	CERCIDIUM MICROPHYLLUM	FOOTHILLS PALO VERDE	15	12	YELLOW	RFS	DEAD TRUNK	DEAD LIMB
606	PROSOPIS VELUTINA	VELVET MESQUITE	12	12	YELLOW	RFS	DIEBACK	DEAD TRUNK
607	CERCIDIUM MICROPHYLLUM	FOOTHILLS PALO VERDE	12	12	YELLOW	RFS	NOT SALVAGEABLE	LG SIZE/POOR SOIL CONDITIONS
608	CERCIDIUM MICROPHYLLUM	FOOTHILLS PALO VERDE	12	12	YELLOW	RFS	NOT SALVAGEABLE	LG SIZE/POOR SOIL CONDITIONS
609	CERCIDIUM MICROPHYLLUM	FOOTHILLS PALO VERDE	12	16	YELLOW	RFS	DEAD TRUNK	DEAD LIMB
610	CERCIDIUM MICROPHYLLUM	FOOTHILLS PALO VERDE	14	12	YELLOW	RFS	DEAD TRUNK	DEAD LIMB
611	ACACIA GREGGII	CATCLAW ACACIA	15	12	YELLOW	RFS	NOT SALVAGEABLE	LG SIZE/POOR SOIL CONDITIONS
612	CERCIDIUM MICROPHYLLUM	FOOTHILLS PALO VERDE	16	15	YELLOW	RFS	NOT SALVAGEABLE	LG SIZE/POOR SOIL CONDITIONS
613	CERCIDIUM MICROPHYLLUM	FOOTHILLS PALO VERDE	17	14	YELLOW	RFS	NOT SALVAGEABLE	LG SIZE/POOR SOIL CONDITIONS
614	CERCIDIUM MICROPHYLLUM	FOOTHILLS PALO VERDE	15	14	YELLOW	RFS	NOT SALVAGEABLE	LG SIZE/POOR SOIL CONDITIONS
615	ACACIA GREGGII	CATCLAW ACACIA	16	14	YELLOW	RFS	NOT SALVAGEABLE	LG SIZE/POOR SOIL CONDITIONS
616	CERCIDIUM MICROPHYLLUM	FOOTHILLS PALO VERDE	15	14	YELLOW	RFS	NOT SALVAGEABLE	LG SIZE/POOR SOIL CONDITIONS
617	CERCIDIUM FLORIDUM	BLUE PALO VERDE	16	14	YELLOW	RFS	NOT SALVAGEABLE	LG SIZE/POOR SOIL CONDITIONS
618	PROSOPIS VELUTINA	VELVET MESQUITE	19	17	YELLOW	RFS	NOT SALVAGEABLE	LG SIZE/POOR SOIL CONDITIONS
619	CERCIDIUM MICROPHYLLUM	FOOTHILLS PALO VERDE	15	20	YELLOW	RFS	DEAD TRUNK	DEAD LIMB
620	ACACIA GREGGII	CATCLAW ACACIA	18	15	YELLOW	RFS	NOT SALVAGEABLE	LG SIZE/POOR SOIL CONDITIONS
621	CERCIDIUM MICROPHYLLUM	FOOTHILLS PALO VERDE	14	12	YELLOW	RFS	NOT SALVAGEABLE	LG SIZE/POOR SOIL CONDITIONS
5101	PROSOPIS VELUTINA	VELVET MESQUITE	12	14	YELLOW	RFS	DIEBACK	PRIMARY BRANCH DEAD
S102	CERCIDIUM MICROPHYLLUM	FOOTHILLS PALO VERDE	18	30	YELLOW	RFS	DIEBACK	BAD BASE

NOTE: A SIGNIFICANT VEGETATION ID# PREFIXED WITH "S" IS A TAG DISTINGUISHING A PLANT FROM ONE ON THE NATIVE PLANT INVENTORY WITH A SIMILAR ID#.

TREATMENT LEGEND

PIP: Preserved in Place (White Tag)
TOS: Transplanted on-site (Blue Tag)
RFS: Removed from site (Yellow Tag)



PROJECT: CCD-15

DATE: 06/02/23

DRAWN BY: CJL/KDP


CHECKED BY: DB

CALL TO DAYS BE 602
1-80

REVISIONS/SUBMITTALS DATE

CALL TWO WORKING
DAYS BEFORE YOU DIG
602-263-1100
1-800-STAKE-IT
(OUTSIDE
MARICOPA COUNTY)

NATIVE PLANT PRESERVATION NOTES

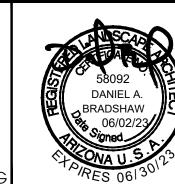

NATIVE PLANT PRESERVATION
PLAN
RULNEY VISTOSO RESIDENTIAL

A PORTION OF THE S.E. 1/4 OF SECTION 23, TOWNSHIP 11 SOUTH, RANGE 13 EAST, G.&S.R.M., TOWN OF ORO VALLEY, PIMA COUNTY, ARIZONA CASE NO:

CASE #

REFERENCE

FOR AGENCY REVIEW AND APPROVAL ONLY. NOT FOR CONSTRUCTION. NOT FOR BIDDING

00			
	THE PLANNING CENTER		
CO	a division of TPC Group, Inc. 2 e congress ste 600 tucson az 85701	520.623.6146 520.622.1950	azplanningcenter.com

FISHHOOK BARREL

OCOTILLO

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17 0

SINGLE

SINGLE

SINGLE

HIGH

HIGH

LOW

BLUE

BLUE

YELLOW

175 FOUQUIERIA SPLENDENS OCOTILLO

FEROCACTUS WISLIZENII

177 FOUQUIERIA SPLENDENS

CALL TWO WORKIN PROJECT: CCD-15 DAYS BEFORE YOU D DATE: 06/02/23 602-263-1100 DRAWN BY: CJL/KDP 1-800-STAKE-IT (OUTSIDE CHECKED BY: DB MARICOPA COUNT

TOS

TOS

RFS

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ITY)			
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15+- canes

LARGE SIZE

IN DECLINE

0

FEROCACTUS WISLIZENII

ACACIA GREGGII



NATIVE PLANT PRESERVATION RULNEY VISTOSO RESIDENTIAL

CASE NO: CASE # REFERENCE REF#

10 OF 28

tag in tree

tag in tree. barrel in tree

A PORTION OF THE S.E. 1/4 OF SECTION 23, TOWNSHIP 11 SOUTH, RANGE 13 EAST G.&S.R.M., TOWN OF ORO VALLEY, PIMA COUNTY, ARIZONA

E SIZE			254	CERCIDIUM I	MICROPHYLLUM	FOOTHILLS PALO VE	RDE	9	4	MULTI	MEDIUM	MEDIUM	YELLOW	R
#	REVISIONS/SUBMITT	ΓALS		DATE										
							NATIV	/E P	LAN	IT IN\	/ENTO	RY	IAT II	8092 NIEL A. DSHAW 06/02/23
					FOR AGENC	Y REVIEW AND AP	PROVAL OI	nly. no	T FOR CC	ONSTRUCTION	ON. NOT FOR	BIDDING	PIRES	10.5 06130

FISHHOOK BARREL

CATCLAW ACACIA

SIG. | HEIGHT | CALIPER (FT)

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LARGE SIZE

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BROKEN LIMB

REGROWTH

DIEBACK

WIDE BASE

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LOW BRANCHING

WIDE BASE

DEAD LIMB

DIEBACK

POOR FORM

POOR FORM

LOW BRANCHING

LOW BRANCHING

LOW BRANCHING

10 +- canes

10+- canes

10+- canes

20 +- canes

double

triple

10 +- canes

split near bottom

perfect tree

POOR FORM | LOW BRANCHING

NATIVE	PLANT INVENTORY															
	LANT HAVEIATORT	0.0.	-	ALIPER												
NUMBER	BOTANICAL NAME COMMON NAME	VEG.	(FT)	(IN)	TRUNK	VIABILITY	TRANSPLANT	TAG	TREATMENT	ARM					BOTANICAL NAME	COMMON NAME V
100	CERCIDIUM MICROPHYLLUM FOOTHILLS PALO VERDE		8	3	MULTI	MEDIUM	LOW	YELLOW	RFS	0	INTERFERENCE	LOW BRANCHING		178	CERCIDIUM MICROPHYLLUM	FOOTHILLS PALO VERDE
102	CERCIDIUM MICROPHYLLUM FOOTHILLS PALO VERDE		7	3	MULTI	MEDIUM	LOW	YELLOW	RFS	0	LOW BRANCHING			179	FEROCACTUS WISLIZENII	FISHHOOK BARREL
103	CERCIDIUM MICROPHYLLUM FOOTHILLS PALO VERDE		13	11	MULTI	MEDIUM	LOW	YELLOW	RFS	0	DIEBACK	LOW BRANCHING	in rocks	180	PROSOPIS VELUTINA	VELVET MESQUITE
104	CERCIDIUM MICROPHYLLUM FOOTHILLS PALO VERDE		14	9	MULTI	MEDIUM	LOW	YELLOW	RFS	0	DIEBACK	SOILS ROCKY	in rocks tag in tree	181	CERCIDIUM MICROPHYLLUM FOUQUIERIA SPLENDENS	FOOTHILLS PALO VERDE
105	CARNEGIEA GIGANTEA SAGUARO		11	0	SINGLE	MEDIUM	LOW	BLUE	TOS	0	YELLOWING	SOILS ROCKY	in rocks tag in tree	182	CERCIDIUM MICROPHYLLUM	OCOTILLO FOOTHILLS PALO VERDE
106	CARNEGIEA GIGANTEA SAGUARO		2	0	SINGLE	HIGH	MEDIUM	BLUE	TOS	0	SOILS ROCKY			183		
107	CARNEGIEA GIGANTEA SAGUARO		2	0	SINGLE	HIGH	MEDIUM	BLUE	TOS	0	SOILS ROCKY	INTERFERENCE	in rooks	184	FOUQUIERIA SPLENDENS	OCOTILLO
108	CERCIDIUM MICROPHYLLUM FOOTHILLS PALO VERDE		10	0	MULTI	MEDIUM	LOW	YELLOW	RFS	0	INTERFERENCE	DIEBACK	in rocks	185	FEROCACTUS WISLIZENII	FISHHOOK BARREL
109	CERCIDIUM MICROPHYLLUM FOOTHILLS PALO VERDE		8	5	MULTI	MEDIUM	LOW	YELLOW	RFS	0	DIEBACK	LOW BRANCHING		186	FEROCACTUS WISLIZENII	FISHHOOK BARREL
110	CERCIDIUM MICROPHYLLUM FOOTHILLS PALO VERDE		7	5	MULTI	LOW	LOW	YELLOW	RFS	0	DIEBACK	DEAD LIMB		187	FOUQUIERIA SPLENDENS	OCOTILLO
111	FEROCACTUS WISLIZENII FISHHOOK BARREL		1	0	SINGLE	LOW	LOW	YELLOW	RFS	0	DIEBACK			188	FOUQUIERIA SPLENDENS	OCOTILLO
112	FEROCACTUS WISLIZENII FISHHOOK BARREL		1	0	SINGLE	LOW	LOW	YELLOW	RFS	0	YELLOWING			189	CERCIDIUM MICROPHYLLUM	FOOTHILLS PALO VERDE
113	CARNEGIEA GIGANTEA SAGUARO		3	0	SINGLE	HIGH	LOW	BLUE	TOS	0	SOILS ROCKY			190	FEROCACTUS WISLIZENII	FISHHOOK BARREL
114	ACACIA CONSTRICTA WHITETHORN ACACIA		9	0	MULTI	MEDIUM	LOW	YELLOW	RFS	0	POOR FORM	LOW BRANCHING		191	FEROCACTUS WISLIZENII	FISHHOOK BARREL
115	FEROCACTUS WISLIZENII FISHHOOK BARREL		1	0	MULTI	HIGH	HIGH	BLUE	TOS	0				192	FEROCACTUS WISLIZENII	FISHHOOK BARREL
116	FEROCACTUS WISLIZENII FISHHOOK BARREL		1	0	SINGLE	HIGH	HIGH	BLUE	TOS	0				193	FOUQUIERIA SPLENDENS	OCOTILLO
117	FEROCACTUS WISLIZENII FISHHOOK BARREL		1	0	SINGLE	LOW	LOW	YELLOW	RFS	0	DIEBACK	SOILS ROCKY		194	FEROCACTUS WISLIZENII	FISHHOOK BARREL
*118	CARNEGIEA GIGANTEA SAGUARO		12	0	SINGLE	HIGH	LOW	BLUE	TOS	0	SOILS ROCKY			195	FEROCACTUS WISLIZENII	FISHHOOK BARREL
118	CERCIDIUM MICROPHYLLUM FOOTHILLS PALO VERDE		9	8	MULTI	MEDIUM	LOW	YELLOW	RFS	0	LOW BRANCHING			196	FEROCACTUS WISLIZENII	FISHHOOK BARREL
120	ACACIA GREGGII CATCLAW ACACIA		5	5	MULTI	MEDIUM	LOW	YELLOW	RFS	0	INTERFERENCE	SOILS ROCKY		197	FEROCACTUS WISLIZENII	FISHHOOK BARREL
121	ACACIA GREGGII CATCLAW ACACIA		4	3	MULTI	MEDIUM	LOW	YELLOW	RFS	0	LOW BRANCHING			198	FOUQUIERIA SPLENDENS	OCOTILLO
122	ACACIA CONSTRICTA WHITETHORN ACACIA		14	6	MULTI	MEDIUM	LOW	BLUE	TOS	0	LARGE SIZE	DEAD LIMB		199	CERCIDIUM MICROPHYLLUM	
123	ACACIA CONSTRICTA WHITETHORN ACACIA		13	6	MULTI	MEDIUM	LOW	YELLOW	RFS	0	DAMAGED	DIEBACK		200	FEROCACTUS WISLIZENII	FISHHOOK BARREL
124	CARNEGIEA GIGANTEA SAGUARO		9	0	SINGLE	HIGH	HIGH	BLUE	TOS	0				201	OLNEYA TESOTA	IRONWOOD
125	CARNEGIEA GIGANTEA SAGUARO		3	0	SINGLE	HIGH	HIGH	BLUE	TOS	0				202	OLNEYA TESOTA	IRONWOOD
126	CERCIDIUM MICROPHYLLUM FOOTHILLS PALO VERDE		8	8	MULTI	LOW	LOW	YELLOW	RFS	0	DIEBACK	BROKEN LIMB		203	OLNEYA TESOTA	IRONWOOD
127	CERCIDIUM MICROPHYLLUM FOOTHILLS PALO VERDE		0	0	MULTI	MEDIUM	LOW	YELLOW	RFS	0	DIEBACK	IN DECLINE	in rocks	204	CARNEGIEA GIGANTEA	SAGUARO
128	FEROCACTUS WISLIZENII FISHHOOK BARREL		1	0	SINGLE	HIGH	HIGH	BLUE	TOS	0				205	CARNEGIEA GIGANTEA	SAGUARO
129	ACACIA CONSTRICTA WHITETHORN ACACIA		10	0	MULTI	MEDIUM	LOW	YELLOW	RFS	0	DIEBACK		in rocks	206	CARNEGIEA GIGANTEA	SAGUARO
130	FEROCACTUS WISLIZENII FISHHOOK BARREL		2	0	SINGLE	HIGH	HIGH	BLUE	TOS	0				207	OLNEYA TESOTA	IRONWOOD
131	CERCIDIUM MICROPHYLLUM FOOTHILLS PALO VERDE		7	5	SINGLE	MEDIUM	MEDIUM	BLUE	TOS	0	SOILS SANDY			208	OLNEYA TESOTA	IRONWOOD
132	YUCCA ELATA SOAPTREE YUCCA		2	0	SINGLE	HIGH	HIGH	BLUE	TOS	0				209	OLNEYA TESOTA	IRONWOOD
133	FEROCACTUS WISLIZENII FISHHOOK BARREL		1	0	SINGLE	MEDIUM	LOW	YELLOW	RFS	0	INTERFERENCE			210	OLNEYA TESOTA	IRONWOOD
134	CERCIDIUM MICROPHYLLUM FOOTHILLS PALO VERDE		7	8	MULTI	LOW	LOW	YELLOW	RFS	0	DEAD TRUNK	REGROWTH		211	OLNEYA TESOTA	IRONWOOD
135	FEROCACTUS WISLIZENII FISHHOOK BARREL		3	0	SINGLE	LOW	LOW	YELLOW	RFS	0	IN DECLINE	YELLOWING		212	OLNEYA TESOTA	IRONWOOD
136	FEROCACTUS WISLIZENII FISHHOOK BARREL		1	0	SINGLE	HIGH	HIGH	BLUE	TOS	0				213	ACACIA GREGGII	CATCLAW ACACIA
137	FEROCACTUS WISLIZENII FISHHOOK BARREL		1	0	SINGLE	HIGH	HIGH	BLUE	TOS	0				214	FEROCACTUS WISLIZENII	FISHHOOK BARREL
138	FEROCACTUS WISLIZENII FISHHOOK BARREL		2	0	SINGLE	LOW	LOW	YELLOW	RFS	0	IN DECLINE	YELLOWING		215	PROSOPIS VELUTINA	VELVET MESQUITE
139	FOUQUIERIA SPLENDENS OCOTILLO		14	0	MULTI	HIGH	MEDIUM	BLUE	TOS	0			20 +- canes	216	CERCIDIUM MICROPHYLLUM	FOOTHILLS PALO VERDE
140	FEROCACTUS WISLIZENII FISHHOOK BARREL		1	0	SINGLE	HIGH	HIGH	BLUE	TOS	0				217	FEROCACTUS WISLIZENII	FISHHOOK BARREL
141	CERCIDIUM MICROPHYLLUM FOOTHILLS PALO VERDE		9	8	MULTI	HIGH	LOW	YELLOW	RFS	0	POOR FORM	WIDE BASE		218	FEROCACTUS WISLIZENII	FISHHOOK BARREL
142	ACACIA CONSTRICTA WHITETHORN ACACIA		6	3	MULTI	LOW	LOW	YELLOW	RFS	0	DIEBACK	DAMAGED		219	CELTIS PALLIDA	DESERT HACKBERRY
143	CERCIDIUM MICROPHYLLUM FOOTHILLS PALO VERDE		9	5	SINGLE	HIGH	MEDIUM	BLUE	TOS	0				220	CARNEGIEA GIGANTEA	SAGUARO
144	CERCIDIUM MICROPHYLLUM FOOTHILLS PALO VERDE		13	15	MULTI	LOW	LOW	YELLOW	RFS	0	YELLOWING	DIEBACK		221	FEROCACTUS WISLIZENII	FISHHOOK BARREL
145	FEROCACTUS WISLIZENII FISHHOOK BARREL		3	0	SINGLE	LOW	LOW	YELLOW	RFS	0	YELLOWING			100	PROSOPIS VELUTINA	VELVET MESQUITE
146	CERCIDIUM MICROPHYLLUM FOOTHILLS PALO VERDE		14	8	MULTI	MEDIUM	LOW	BLUE	TOS	0	DIEBACK	WIDE BASE		223	FEROCACTUS WISLIZENII	FISHHOOK BARREL
147	FEROCACTUS WISLIZENII FISHHOOK BARREL		2	0	SINGLE	LOW	LOW	YELLOW	RFS	0	IN DECLINE	YELLOWING		224	ZIZIPHUS OBTUSIFOLIA	GRAYTHORN
148	FEROCACTUS WISLIZENII FISHHOOK BARREL		1	0	SINGLE	MEDIUM	HIGH	BLUE	TOS	0				225	ACACIA GREGGII	CATCLAW ACACIA
149	FEROCACTUS WISLIZENII FISHHOOK BARREL		3	0	SINGLE	LOW	LOW	YELLOW	RFS	0	YELLOWING	IN DECLINE		226	ACACIA CONSTRICTA	WHITETHORN ACACIA
150	FEROCACTUS WISLIZENII FISHHOOK BARREL		3	0	SINGLE	LOW	LOW	YELLOW	RFS	0	IN DECLINE	BAD BASE		227	ACACIA CONSTRICTA	WHITETHORN ACACIA
151	ACACIA GREGGII CATCLAW ACACIA		6	3	MULTI	MEDIUM	LOW	YELLOW	RFS	0	WIDE BASE	LOW BRANCHING		228	CARNEGIEA GIGANTEA	SAGUARO
152	ACACIA GREGGII CATCLAW ACACIA		6	7	MULTI	MEDIUM	LOW	YELLOW	RFS	0	DAMAGED	LOW BRANCHING		229	FEROCACTUS WISLIZENII	FISHHOOK BARREL
153	FEROCACTUS WISLIZENII FISHHOOK BARREL		3	0	SINGLE	MEDIUM	LOW	YELLOW	RFS	0	BAD BASE	YELLOWING		230	ACACIA CONSTRICTA	WHITETHORN ACACIA
154	CERCIDIUM MICROPHYLLUM FOOTHILLS PALO VERDE		8	7	MULTI	MEDIUM	LOW	YELLOW	RFS	0	DIEBACK	LOW BRANCHING		231	FEROCACTUS WISLIZENII	FISHHOOK BARREL
155	ACACIA GREGGII CATCLAW ACACIA		4	3	MULTI	MEDIUM	LOW	YELLOW	RFS	0	POOR FORM			232	FEROCACTUS WISLIZENII	FISHHOOK BARREL
156	FOUQUIERIA SPLENDENS OCOTILLO		7	0	SINGLE	LOW	LOW	YELLOW	RFS	0			10 canes in rat nest	233	ZIZIPHUS OBTUSIFOLIA	GRAYTHORN
157	FEROCACTUS WISLIZENII FISHHOOK BARREL		1	0	SINGLE	HIGH	HIGH	BLUE	TOS	0				234	CERCIDIUM MICROPHYLLUM	FOOTHILLS PALO VERDE
158	FOUQUIERIA SPLENDENS OCOTILLO		10	0	SINGLE	HIGH	HIGH	BLUE	TOS	0			15 +- canes	235	ZIZIPHUS OBTUSIFOLIA	GRAYTHORN
159	FOUQUIERIA SPLENDENS OCOTILLO		10	0	SINGLE	HIGH	HIGH	BLUE	TOS	0			10 +-canes	236	FEROCACTUS WISLIZENII	FISHHOOK BARREL
160	FOUQUIERIA SPLENDENS OCOTILLO		12	0	SINGLE	HIGH	HIGH	BLUE	TOS	0			15+- canes	237	FEROCACTUS WISLIZENII	FISHHOOK BARREL
161	FEROCACTUS WISLIZENII FISHHOOK BARREL		0	0	SINGLE	HIGH	HIGH	BLUE	TOS	0				238	CERCIDIUM MICROPHYLLUM	FOOTHILLS PALO VERDE
162	FEROCACTUS WISLIZENII FISHHOOK BARREL		1	0	SINGLE	HIGH	HIGH	BLUE	TOS	0				239	FEROCACTUS WISLIZENII	FISHHOOK BARREL
163	FEROCACTUS WISLIZENII FISHHOOK BARREL		2	0	SINGLE	MEDIUM	MEDIUM	YELLOW	RFS	0	YELLOWING			240	FEROCACTUS WISLIZENII	FISHHOOK BARREL
164	FOUQUIERIA SPLENDENS OCOTILLO		7	0	SINGLE	HIGH	HIGH	BLUE	TOS	0			7 +- canes	241	CERCIDIUM MICROPHYLLUM	FOOTHILLS PALO VERDE
165	FEROCACTUS WISLIZENII FISHHOOK BARREL		1	0	SINGLE	HIGH	HIGH	BLUE	TOS	0				242	CERCIDIUM MICROPHYLLUM	FOOTHILLS PALO VERDE
100	FOUQUIERIA SPLENDENS OCOTILLO		13	0	SINGLE	HIGH	HIGH	BLUE	TOS	0			25+- canes	243	CERCIDIUM FLORIDUM	BLUE PALO VERDE
167	FEROCACTUS WISLIZENII FISHHOOK BARREL		2	0	SINGLE	HIGH	HIGH	BLUE	TOS	0				244	FEROCACTUS WISLIZENII	FISHHOOK BARREL
168	FEROCACTUS WISLIZENII FISHHOOK BARREL		2	0	SINGLE	HIGH	HIGH	BLUE	TOS	0				245	FEROCACTUS WISLIZENII	FISHHOOK BARREL
169	FOUQUIERIA SPLENDENS OCOTILLO		11	0	SINGLE	HIGH	HIGH	BLUE	TOS	0			20 +- canes	246	CARNEGIEA GIGANTEA	SAGUARO
170	FEROCACTUS WISLIZENII FISHHOOK BARREL		1	0	SINGLE	HIGH	HIGH	BLUE	TOS	0				247	CERCIDIUM MICROPHYLLUM	FOOTHILLS PALO VERDE
171	FEROCACTUS WISLIZENII FISHHOOK BARREL		2	0	SINGLE	HIGH	HIGH	BLUE	TOS	0				248	CERCIDIUM MICROPHYLLUM	FOOTHILLS PALO VERDE
172	FEROCACTUS WISLIZENII FISHHOOK BARREL		1	0	SINGLE	HIGH	HIGH	BLUE	TOS	0				249	ACACIA GREGGII	CATCLAW ACACIA
173	FOUQUIERIA SPLENDENS OCOTILLO		6	0	SINGLE	HIGH	HIGH	BLUE	TOS	0			10+- canes	250	ACACIA GREGGII	CATCLAW ACACIA
174	FEROCACTUS WISLIZENII FISHHOOK BARREL		1	0	SINGLE	MEDIUM	LOW	YELLOW	RFS	0	BAD BASE	YELLOWING		251	FEROCACTUS WISLIZENII	FISHHOOK BARREL
175	FOUQUIERIA SPLENDENS OCOTILLO		7	0	SINGLE	HIGH	HIGH	BLUE	TOS	0			15+- canes	252	FEROCACTUS WISLIZENII	FISHHOOK BARREL

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	THE PLANNING CENTER a division of TPC Group, Inc. 2 e congress ste 600 tucson az 85701			X	
	2 e congress ste 600 tucson az 85701	520.623.614	46 520.622.1950	azplanningcent	er.com

CALL TWO WORKIN PROJECT: CCD-15 DAYS BEFORE YOU D DATE: 06/02/23 602-263-1100 DRAWN BY: CJL/KDP 1-800-STAKE-IT (OUTSIDE CHECKED BY: DB MARICOPA COUNT

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COMMON NAME

CERCIDIUM MICROPHYLLUM FOOTHILLS PALO VERDE

CERCIDIUM MICROPHYLLUM | FOOTHILLS PALO VERDE

| CERCIDIUM MICROPHYLLUM | FOOTHILLS PALO VERDE

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CERCIDIUM MICROPHYLLUM | FOOTHILLS PALO VERDE

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342 | CERCIDIUM MICROPHYLLUM | FOOTHILLS PALO VERDE

345 | CERCIDIUM MICROPHYLLUM | FOOTHILLS PALO VERDE

FISHHOOK BARREL

FISHHOOK BARREL

FISHHOOK BARREL

CATCLAW ACACIA

VELVET MESQUITE

FISHHOOK BARREL

FISHHOOK BARREL

VELVET MESQUITE

FISHHOOK BARREL

OCOTILLO

CATCLAW ACACIA

VELVET MESQUITE

VELVET MESQUITE

DESERT HACKBERRY

VELVET MESQUITE

CATCLAW ACACIA

BLUE PALO VERDE

VELVET MESQUITE

VELVET MESQUITE

VELVET MESQUITE

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VELVET MESQUITE

CATCLAW ACACIA

FISHHOOK BARREL

CATCLAW ACACIA

FISHHOOK BARREL

OCOTILLO

VELVET MESQUITE

VELVET MESQUITE

FISHHOOK BARREL

FISHHOOK BARREL

OCOTILLO

FOOTHILLS PALO VERDE

CATCLAW ACACIA

CATCLAW ACACIA

CATCLAW ACACIA

CATCLAW ACACIA

FISHHOOK BARREL

FISHHOOK BARREL

FISHHOOK BARREL

FISHHOOK BARREL

CATCLAW ACACIA

VELVET MESQUITE

FISHHOOK BARREL

FISHHOOK BARREL

FISHHOOK BARREL

BLUE PALO VERDE

WHITETHORN ACACIA

WHITETHORN ACACIA

NUMBER | BOTANICAL NAME

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FEROCACTUS WISLIZENII

FEROCACTUS WISLIZENII

FEROCACTUS WISLIZENII

ACACIA GREGGII

PROSOPIS VELUTINA

FEROCACTUS WISLIZENII

FEROCACTUS WISLIZENII

PROSOPIS VELUTINA

FEROCACTUS WISLIZENII

FOUQUIERIA SPLENDENS

ACACIA GREGGII

PROSOPIS VELUTINA

PROSOPIS VELUTINA

CELTIS PALLIDA

PROSOPIS VELUTINA

ACACIA GREGGII

CERCIDIUM FLORIDUM

PROSOPIS VELUTINA

PROSOPIS VELUTINA

PROSOPIS VELUTINA

PROSOPIS VELUTINA

PROSOPIS VELUTINA

ACACIA GREGGII

FEROCACTUS WISLIZENII

ACACIA GREGGII

FEROCACTUS WISLIZENII

FOUQUIERIA SPLENDENS

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FEROCACTUS WISLIZENII

FEROCACTUS WISLIZENII

FOUQUIERIA SPLENDENS

CERCIDIUM MICROPHYLLUM

ACACIA GREGGII

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FEROCACTUS WISLIZENII

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CERCIDIUM FLORIDUM

ACACIA CONSTRICTA

ACACIA CONSTRICTA

CERCIDIUM MICROPHYLLUM | FOOTHILLS PALO VERDE



NATIVE PLANT PRESERVATION


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NATIVE	PLANT	INVENTORY

/	58092 DANIEL A.	PLAN RULNEY VISTOSO
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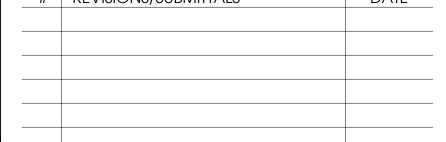
NATIVE PLANT INVENTORY	58092 DANIEL A. BRADSHAW	RULNEY VISTOSO RESIDENTIAL	REFEREN REF #
	BRADSHAW 06/02/23 Signed ONA 11.5:00	A PORTION OF THE S.E. 1/4 OF SECTION 23, TOWNSHIP 11 SOUTH, RANGE 13 EAST, G.&S.R.M., TOWN OF ORO VALLEY, PIMA	N-6
FOR AGENCY REVIEW AND APPROVAL ONLY. NOT FOR CONSTRUCTION. NOT FOR BIDDING	TAIRES 061301	COUNTY, ARIZONA	11 OF

NATIVE I	PLANT INVENTORY					1		ı			T			
	BOTANICAL NAME	COMMON NAME	SIG. VEG.	HEIGHT (FT)	CALIPER (IN)	TRUNK	VIABILITY	TRANSPLANT	TAG	TREATMENT	ARMS	REASONS		
255 256	FEROCACTUS WISLIZENII CERCIDIUM MICROPHYLLUM	FISHHOOK BARREL FOOTHILLS PALO VERDE		1 12	5	SINGLE	HIGH LOW	HIGH	BLUE YELLOW	TOS RFS	0	DIEBACK	INTERFERENCE	
257	CERCIDIUM MICROPHYLLUM	FOOTHILLS PALO VERDE		10	4	MULTI	LOW	LOW	YELLOW	RFS	0	DIEBACK	YELLOWING	
258	CERCIDIUM MICROPHYLLUM	FOOTHILLS PALO VERDE		12	6	MULTI	MEDIUM	LOW	YELLOW	RFS	0	INTERFERENCE	YELLOWING	2 smaller trees intertwined
259	ACACIA GREGGII	CATCLAW ACACIA		12	7	MULTI	MEDIUM	LOW	YELLOW	RFS	0	INTERFERENCE	SOILS ROCKY	growing in rock
260	FEROCACTUS WISLIZENII CERCIDIUM MICROPHYLLUM	FISHHOOK BARREL FOOTHILLS PALO VERDE		1 9	5	SINGLE MULTI	HIGH MEDIUM	HIGH	BLUE BLUE	TOS	0	SOILS ROCKY		tag in tree
262	FEROCACTUS WISLIZENII	FISHHOOK BARREL		1	0	SINGLE	HIGH	MEDIUM	BLUE	TOS	0	SOILS ROCKY		
263	ACACIA GREGGII	CATCLAW ACACIA		8	5	MULTI	MEDIUM	LOW	YELLOW	RFS	0	SOILS ROCKY	POOR FORM	
264	PROSOPIS VELUTINA	VELVET MESQUITE		8	6	MULTI	MEDIUM	LOW	YELLOW	RFS	0	WIDE BASE	POOR FORM	
265	ACACIA CONSTRICTA	WHITETHORN ACACIA		10	3	MULTI	MEDIUM	LOW	YELLOW	RFS	0	SOILS SANDY	BAD BASE BAD BASE	concrete drainage
266	PROSOPIS VELUTINA PROSOPIS VELUTINA	VELVET MESQUITE VELVET MESQUITE		7	5	MULTI MULTI	MEDIUM MEDIUM	LOW	YELLOW	RFS RFS	0	SOILS SANDY SOILS SANDY	BAD BASE	concrete drainage
268	CERCIDIUM FLORIDUM	BLUE PALO VERDE		8	6	MULTI	LOW	LOW	YELLOW	RFS	0	SOILS ROCKY	IN DECLINE	
269	ACACIA GREGGII	CATCLAW ACACIA		9	4	MULTI	MEDIUM	LOW	YELLOW	RFS	0	SOILS SANDY	WIDE BASE	
270	CERCIDIUM MICROPHYLLUM	FOOTHILLS PALO VERDE		12	8	MULTI	LOW	LOW	YELLOW	RFS	0	DEAD LIMB	DIEBACK	
271	PROSOPIS VELUTINA PROSOPIS VELUTINA	VELVET MESQUITE VELVET MESQUITE		14 11	11	MULTI MULTI	MEDIUM LOW	LOW	YELLOW	RFS RFS	0	DEAD LIMB DEAD LIMB	SOILS SANDY DEAD LIMB	wash bank wash bank
273	ACACIA GREGGII	CATCLAW ACACIA		12	4	MULTI	LOW	LOW	YELLOW	RFS	0	DEAD LIMB	DEAD TRUNK	- Wash bank
274	ACACIA GREGGII	CATCLAW ACACIA		6	4	MULTI	LOW	LOW	YELLOW	RFS	0	LOW BRANCHING	MISTLETOE	
275	CELTIS PALLIDA	DESERT HACKBERRY		10	0	MULTI	HIGH	LOW	YELLOW	RFS	0	WIDE BASE		
276	PROSOPIS VELUTINA	VELVET MESQUITE		13	9	MULTI	MEDIUM	LOW	YELLOW	RFS	0	WIDE BASE	DIEBACK	on wash bank
277	PROSOPIS VELUTINA CELTIS PALLIDA	VELVET MESQUITE DESERT HACKBERRY		9	0	SINGLE	MEDIUM MEDIUM	LOW	YELLOW	RFS RFS	0	DEAD LIMB	DIEBACK DIEBACK	on wash bank on wash bank
278	PROSOPIS VELUTINA	VELVET MESQUITE		14	8	SINGLE	MEDIUM	LOW	YELLOW	RFS	0	LARGE SIZE	DIEBACK	on wash bank
280	FEROCACTUS WISLIZENII	FISHHOOK BARREL		1	0	SINGLE	HIGH	HIGH	BLUE	TOS	0			
281	CELTIS PALLIDA	DESERT HACKBERRY		7	0	SINGLE	HIGH	LOW	BLUE	TOS	0	LARGE SIZE	·	
282	ACACIA GREGGII	CATCLAW ACACIA		9	6	MULTI	LOW	LOW	YELLOW	RFS	0	DEAD TRUNK	LOW BRANCHING	
283	PROSOPIS VELUTINA FEROCACTUS WISLIZENII	VELVET MESQUITE FISHHOOK BARREL		12 2	0	MULTI	MEDIUM HIGH	HIGH	YELLOW BLUE	RFS TOS	0	DIEBACK	LOW BRANCHING	
285	CELTIS PALLIDA	DESERT HACKBERRY		7	0	MULTI	HIGH	LOW	YELLOW	RFS	0	LOW BRANCHING	WIDE BASE	
286	CERCIDIUM MICROPHYLLUM	FOOTHILLS PALO VERDE		8	5	MULTI	LOW	LOW	YELLOW	RFS	0	DEAD LIMB	IN DECLINE	in rock
287	CERCIDIUM MICROPHYLLUM	FOOTHILLS PALO VERDE		9	11	MULTI	LOW	LOW	YELLOW	RFS	0	DEAD TRUNK	DEAD LIMB	in rock
288	CERCIDIUM MICROPHYLLUM	FOOTHILLS PALO VERDE		7	3	MULTI	LOW	LOW	YELLOW	RFS	0	DIEBACK	DEAD LIMB	in rock
289	CERCIDIUM MICROPHYLLUM CERCIDIUM MICROPHYLLUM			7 12	6	MULTI MULTI	LOW	LOW	YELLOW	RFS RFS	0	DIEBACK	IN DECLINE DEAD LIMB	in rock in rock
290	FEROCACTUS WISLIZENII	FISHHOOK BARREL		2	0	SINGLE	HIGH	LOW	YELLOW	RFS	0	. DIEBACK		in rock
292	FEROCACTUS WISLIZENII	FISHHOOK BARREL		1	0	SINGLE	HIGH	LOW	YELLOW	RFS	0			in rock
293	FEROCACTUS WISLIZENII	FISHHOOK BARREL		2	0	MULTI	MEDIUM	MEDIUM	YELLOW	RFS	0		YELLOWING	in rock
293	FEROCACTUS WISLIZENII	FISHHOOK BARREL		2	0	MULTI	HIGH	MEDIUM	YELLOW	RFS	0		SOILS ROCKY	double
295 296	CERCIDIUM MICROPHYLLUM CERCIDIUM MICROPHYLLUM	FOOTHILLS PALO VERDE FOOTHILLS PALO VERDE		13 8	9	MULTI MULTI	MEDIUM MEDIUM	LOW	YELLOW	RFS RFS	0	DIEBACK	IN DECLINE SOILS SANDY	dieback
297	PROSOPIS VELUTINA	VELVET MESQUITE		12	10	SINGLE	LOW	LOW	YELLOW	RFS	0	DEAD LIMB	POOR FORM	
298	PROSOPIS VELUTINA	VELVET MESQUITE		9	9	MULTI	MEDIUM	LOW	YELLOW	RFS	0	DEAD LIMB	WIDE BASE	
299	CERCIDIUM MICROPHYLLUM	FOOTHILLS PALO VERDE		11	8	MULTI	MEDIUM	LOW	YELLOW	RFS	0	DEAD LIMB	IN DECLINE	
300	CERCIDIUM MICROPHYLLUM			8	3	MULTI	MEDIUM	LOW	YELLOW	RFS	0	YELLOWING	IN DECLINE	hun daman
301	FEROCACTUS WISLIZENII CERCIDIUM MICROPHYLLUM	FISHHOOK BARREL FOOTHILLS PALO VERDE		10	5	SINGLE MULTI	MEDIUM LOW	LOW	YELLOW	RFS RFS	0	YELLOWING BAD BASE	DEAD LIMB	bug damage bug damage
303	CERCIDIUM MICROPHYLLUM			7	3	MULTI	LOW	LOW	YELLOW	RFS	0	IN DECLINE	DEAD LIMB	
304	CERCIDIUM MICROPHYLLUM	FOOTHILLS PALO VERDE		7	3	MULTI	LOW	LOW	YELLOW	RFS	0	IN DECLINE	DIEBACK	
305	CERCIDIUM MICROPHYLLUM			9	3	MULTI	LOW	LOW	YELLOW	RFS	0	BAD BASE	DEAD LIMB	
306	CERCIDIUM MICROPHYLLUM	FOOTHILLS PALO VERDE		8	4	MULTI	LOW	LOW	YELLOW	RFS	0	DEAD TRUNK	DEAD LIMB	root minister
307	CERCIDIUM MICROPHYLLUM CERCIDIUM MICROPHYLLUM	FOOTHILLS PALO VERDE FOOTHILLS PALO VERDE		12 10	3	MULTI MULTI	LOW	LOW	YELLOW	RFS RFS	0	DEAD TRUNK DIEBACK	DEAD LIMB DEAD LIMB	root runner
309	FEROCACTUS WISLIZENII	FISHHOOK BARREL		1	0	SINGLE	HIGH	HIGH	BLUE	TOS	0		·	
310	ACACIA GREGGII	CATCLAW ACACIA		12	4	MULTI	MEDIUM	LOW	YELLOW	RFS	0	DAMAGED	DIEBACK	
311	FEROCACTUS WISLIZENII	FISHHOOK BARREL		2	0	SINGLE	HIGH	MEDIUM	BLUE	TOS	0	SOILS ROCKY	DIEBACK	
312	CARNEGIEA GIGANTEA	SAGUARO FOOTHILLS PALO VERDE		2	10	SINGLE	HIGH	MEDIUM	BLUE	TOS RFS	0	SOILS ROCKY	DIEBACK	tag in tree leaning
312	CERCIDIUM MICROPHYLLUM CERCIDIUM MICROPHYLLUM	FOOTHILLS PALO VERDE		11 12	19	SINGLE	LOW MEDIUM	LOW	YELLOW	RFS	0	DEAD LIMB DEAD LIMB	DIEBACK	root sucker
315	FEROCACTUS WISLIZENII	FISHHOOK BARREL		2	0	SINGLE	HIGH	HIGH	BLUE	TOS	0			
316	FEROCACTUS WISLIZENII	FISHHOOK BARREL		2	0	MULTI	MEDIUM	LOW	YELLOW	RFS	0			triple broken top
317	CERCIDIUM MICROPHYLLUM	FOOTHILLS PALO VERDE		12	9	MULTI	MEDIUM	LOW	YELLOW	RFS	0	LOW BRANCHING	DIEBACK	
318	FEROCACTUS WISLIZENII CERCIDIUM MICROPHYLLUM	FISHHOOK BARREL FOOTHILLS PALO VERDE		9	3	SINGLE	HIGH LOW	MEDIUM	BLUE YELLOW	TOS RFS	0	SOILS ROCKY IN DECLINE	LOW BRANCHING	
319	PROSOPIS VELUTINA	VELVET MESQUITE		9 13	6	MULTI	HIGH	LOW	YELLOW	RFS	0	SOILS SANDY		on wash bank
321	FEROCACTUS WISLIZENII	FISHHOOK BARREL		2	0	SINGLE	HIGH	HIGH	BLUE	TOS	0			
322	PROSOPIS VELUTINA	VELVET MESQUITE		12	4	SINGLE	MEDIUM	LOW	BLUE	TOS	0	SOILS SANDY	MISTLETOE	interference
323	CARNEGIEA GIGANTEA	SAGUARO		8	0	SINGLE	HIGH	MEDIUM	BLUE	TOS	0		SLOPE	flag in tree
324	FEROCACTUS WISLIZENII	FISHHOOK BARREL		1	0	SINGLE	HIGH	MEDIUM	BLUE	TOS	0		SLOPE SLOPE	
325	FEROCACTUS WISLIZENII ACACIA CONSTRICTA	FISHHOOK BARREL WHITETHORN ACACIA		0 13	7	SINGLE MULTI	HIGH MEDIUM	MEDIUM	BLUE YELLOW	TOS RFS	0	SOILS SANDY	SLOPE	on bank
326	FEROCACTUS WISLIZENII	FISHHOOK BARREL		2	0	SINGLE	MEDIUM	LOW	YELLOW	RFS	0	SOILS ROCKY	BAD BASE	rat nest
328	FEROCACTUS WISLIZENII	FISHHOOK BARREL		3	0	MULTI	LOW	LOW	YELLOW	RFS	0	SOILS ROCKY	BAD BASE	double
329	ACACIA GREGGII	CATCLAW ACACIA		10	5	MULTI	MEDIUM	LOW	YELLOW	RFS	0	SOILS ROCKY	LOW BRANCHING	die back
330	FEROCACTUS WISLIZENII	FISHHOOK BARREL		3	0	SINGLE	MEDIUM	MEDIUM	BLUE	TOS	0			flag in buch
331	FEROCACTUS WISLIZENII	FISHHOOK BARREL		1	0	SINGLE	HIGH	HIGH	BLUE	TOS	0	·	·	flag in bush





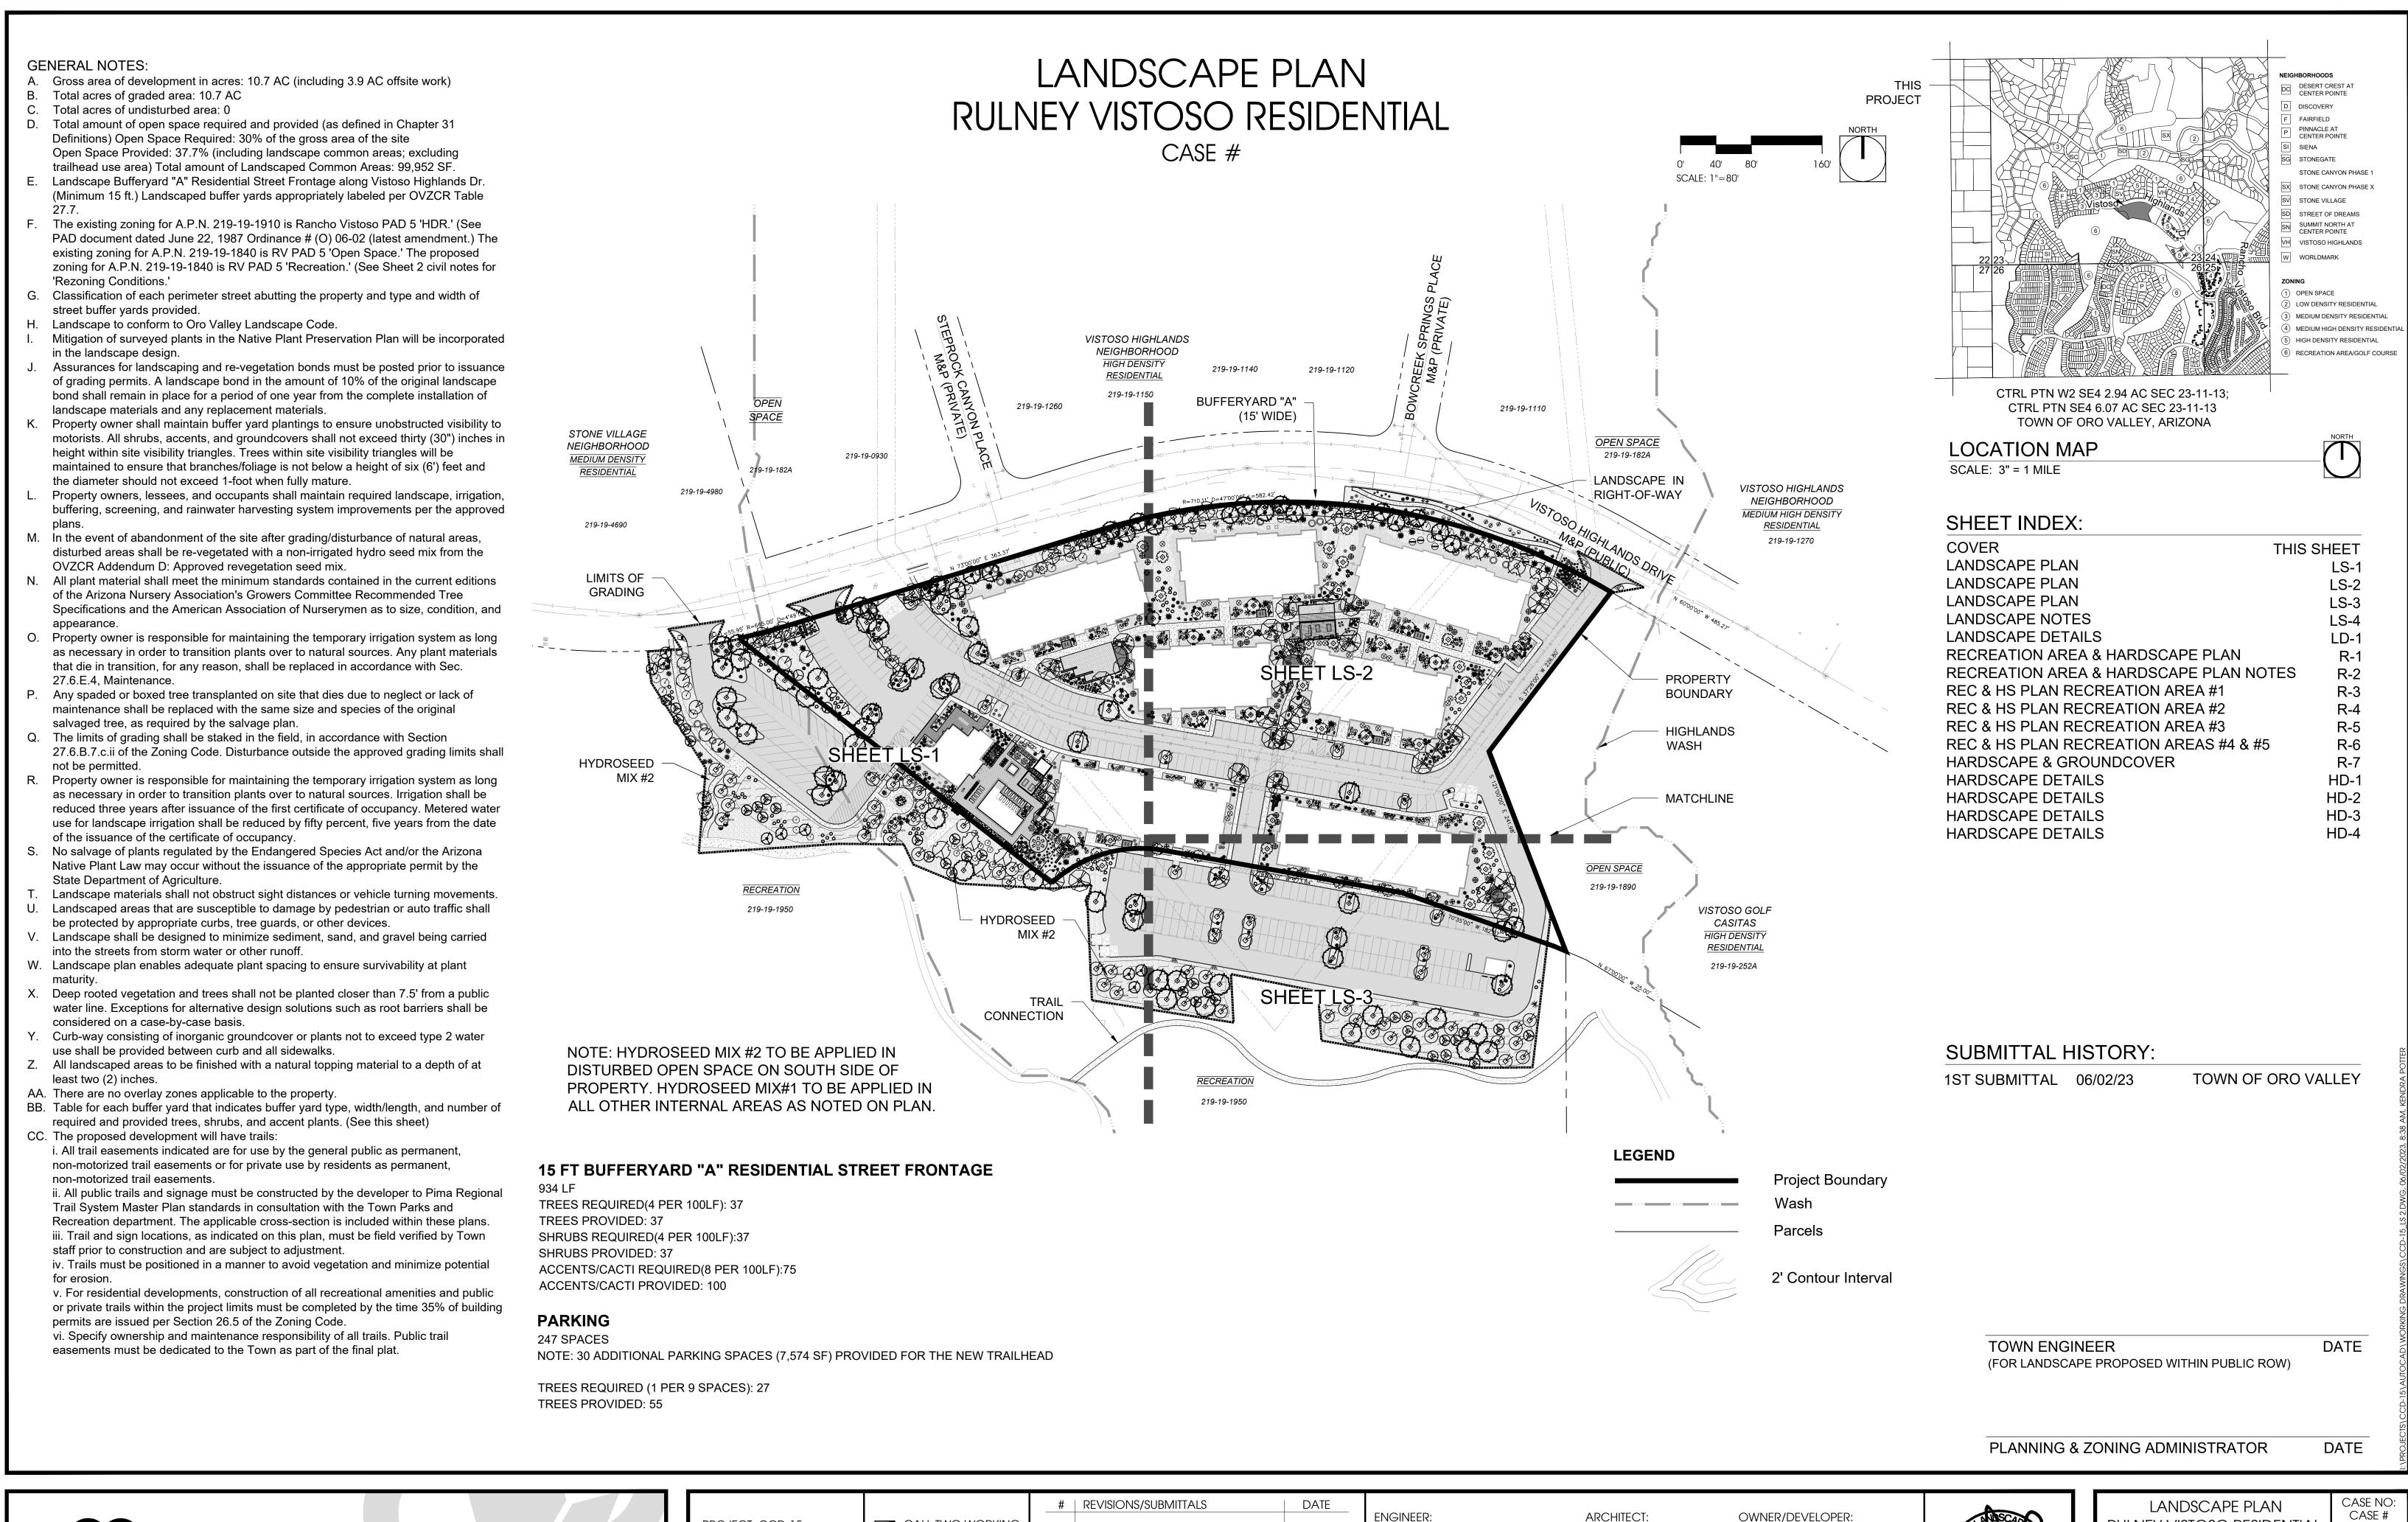



ENGINEER:
RICK ENGINEERING COMPANY
3945 E. FORT LOWELL RD., SUITE 111
TUCSON, AZ 85712
ATTN: KEVIN HALL
PH: (520) 795-1000
khall@rickengineering.com


ARCHITECT:
a23 STUDIOS
711 EAST 9TH STREEET
TUCSON, AZ 85719
ATTN: MR. BURAK BEK
PH: (520) 795-1000
E: info@a23studios.co

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ARCHITECT: OWNER/DEVELOPER: a23 STUDIOS OV 132, LLC
711 EAST 9TH STREEET 6340 N. CAMPBELL AV., SUITE 170 TUCSON, AZ 85719 TUCSON, AZ 85718
ATTN: MR. BURAK BEKAT ATTN: ROSS RULNEY
PH: (520) 903-2323 PH: (520) 850-9300
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LANDSCAPE PLAN RULNEY VISTOSO RESIDENTIAL	CASE NO: CASE #
	REFERENCE REF #
A PORTION OF THE S.E. 1/4 OF SECTION 23, TOWNSHIP 11 SOUTH, RANGE 13 EAST,	
G.&S.R.M., TOWN OF ORO VALLEY, PIMA COUNTY, ARIZONA	LS-0 12 OF 28





DRAWN BY: CJL/KDP 1-800-STAKE-IT (OUTSIDE CHECKED BY: DB MARICOPA COUNTY)

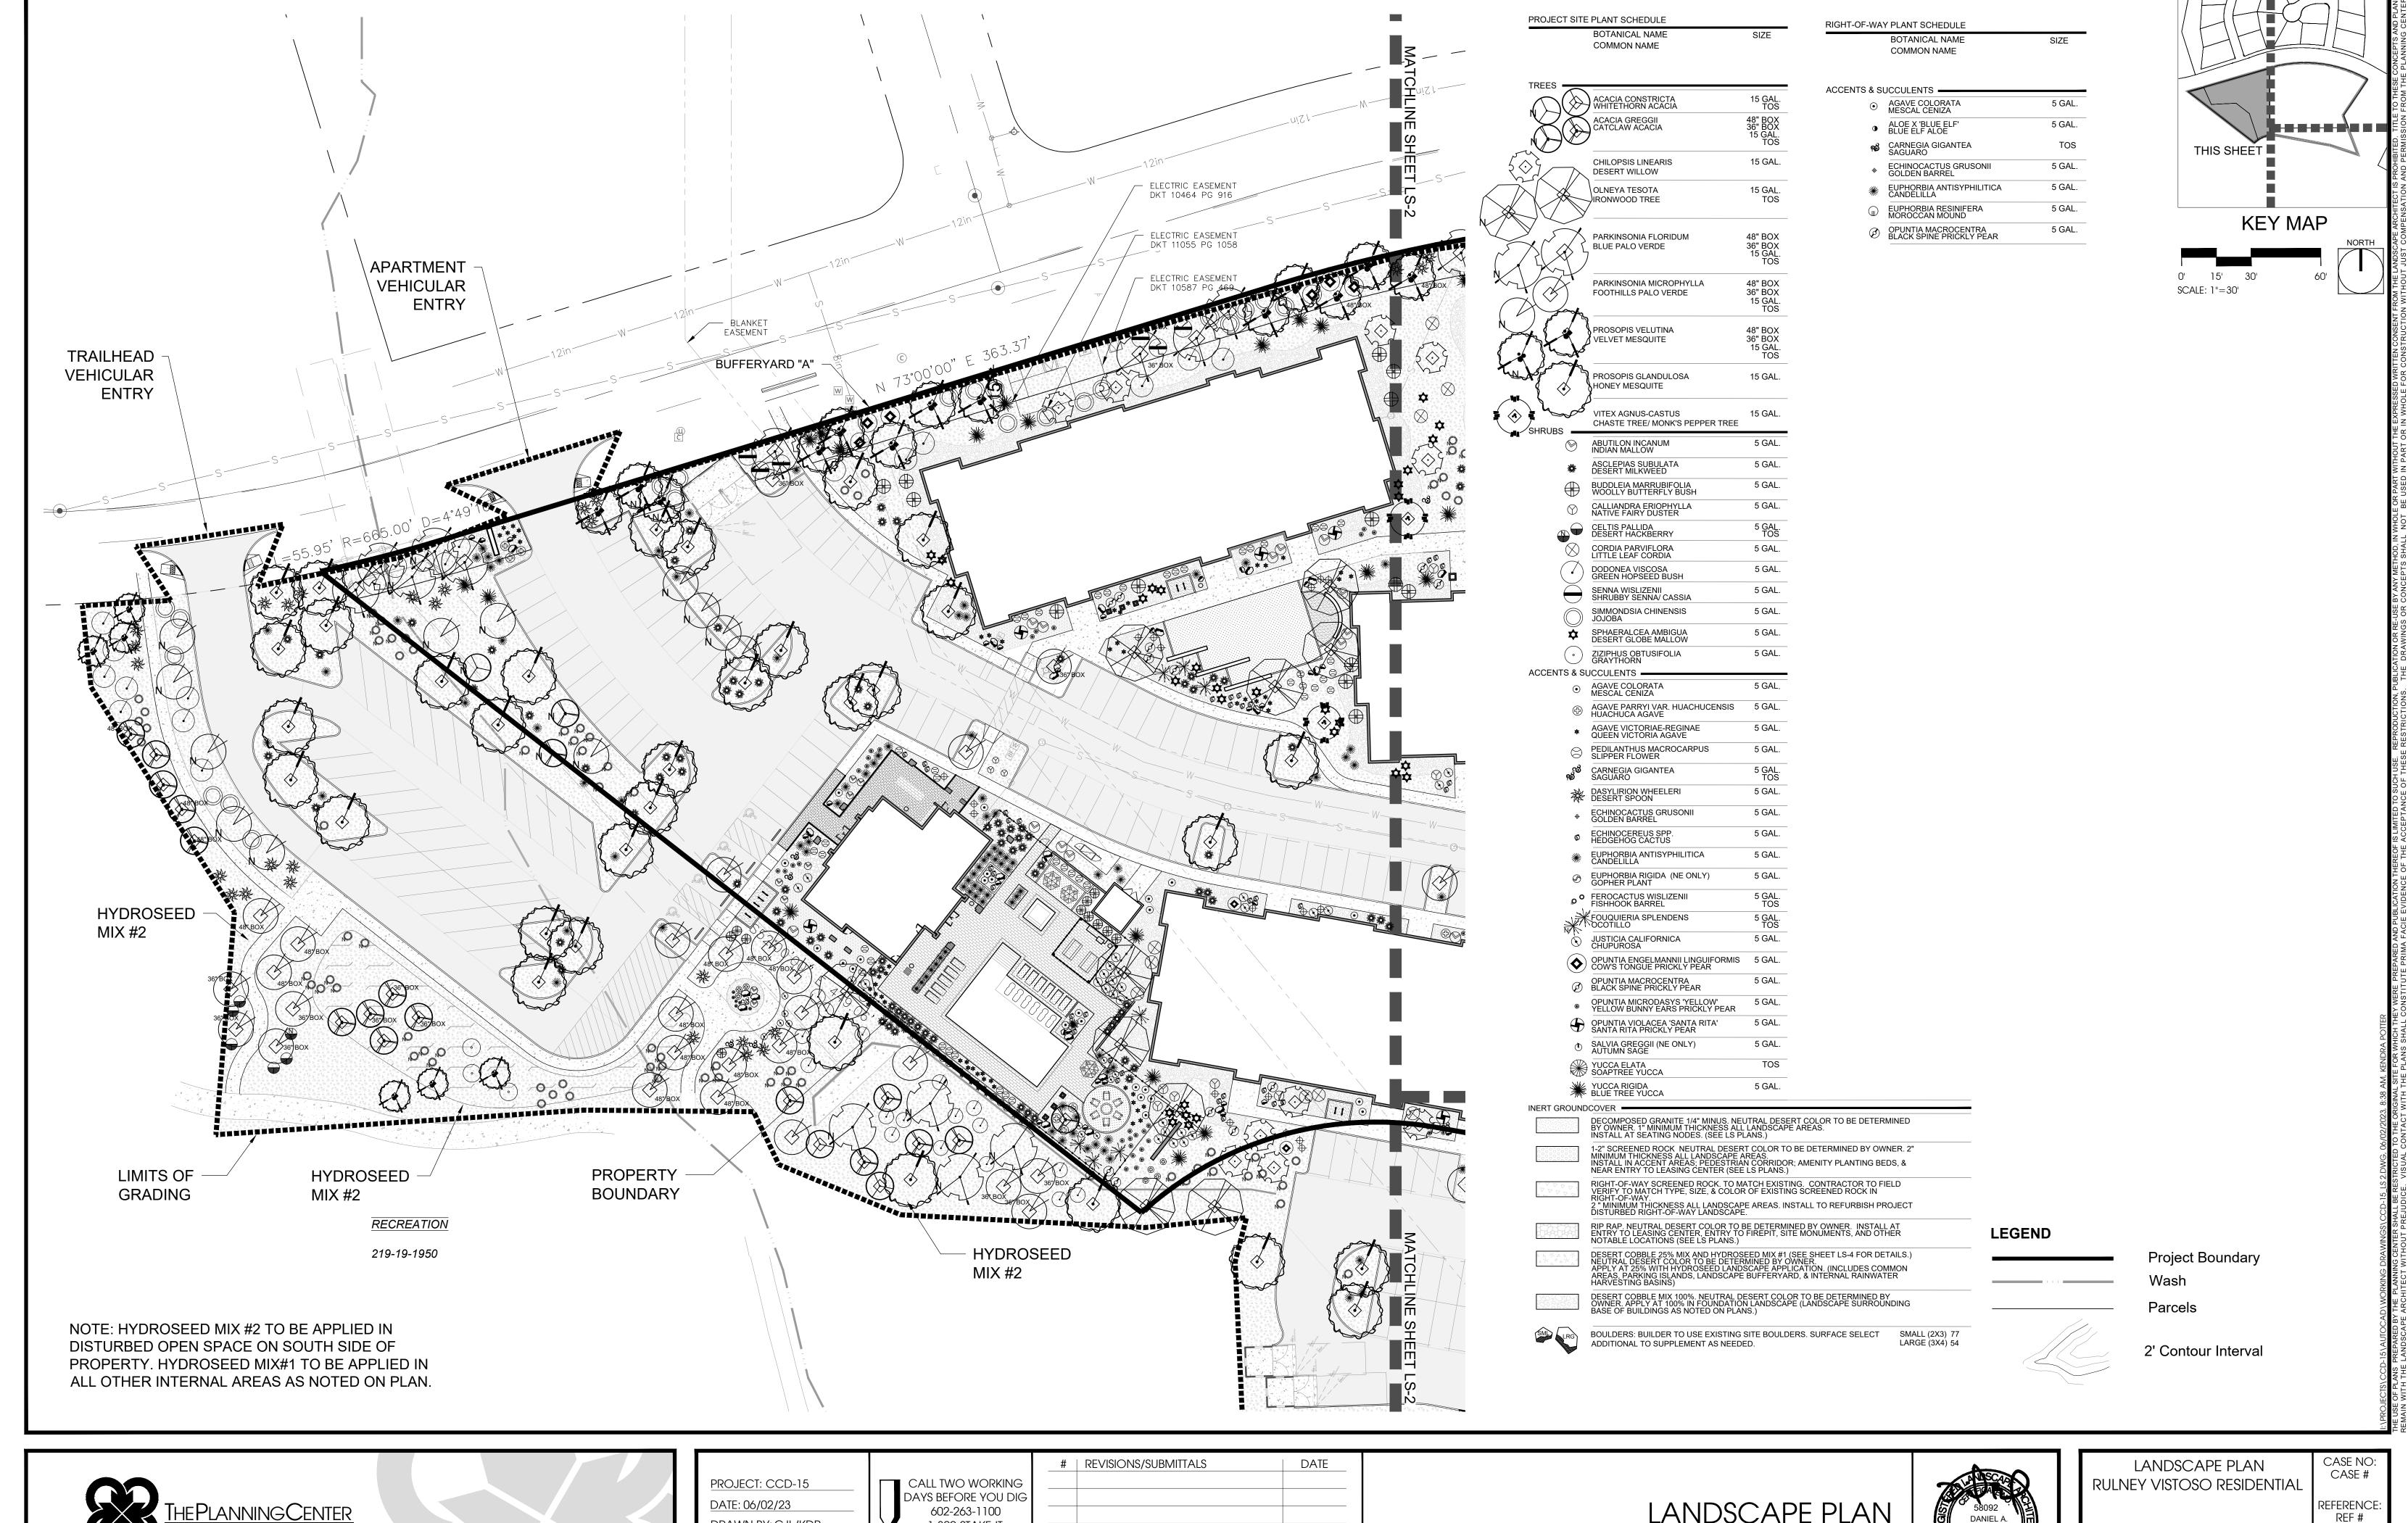LANDSCAPE PLAN


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A PORTION OF THE S.E. 1/4 OF SECTION

13 OF 28

23, TOWNSHIP 11 SOUTH, RANGE 13 EAST G.&S.R.M., TOWN OF ORO VALLEY, PIMA COUNTY, ARIZONA



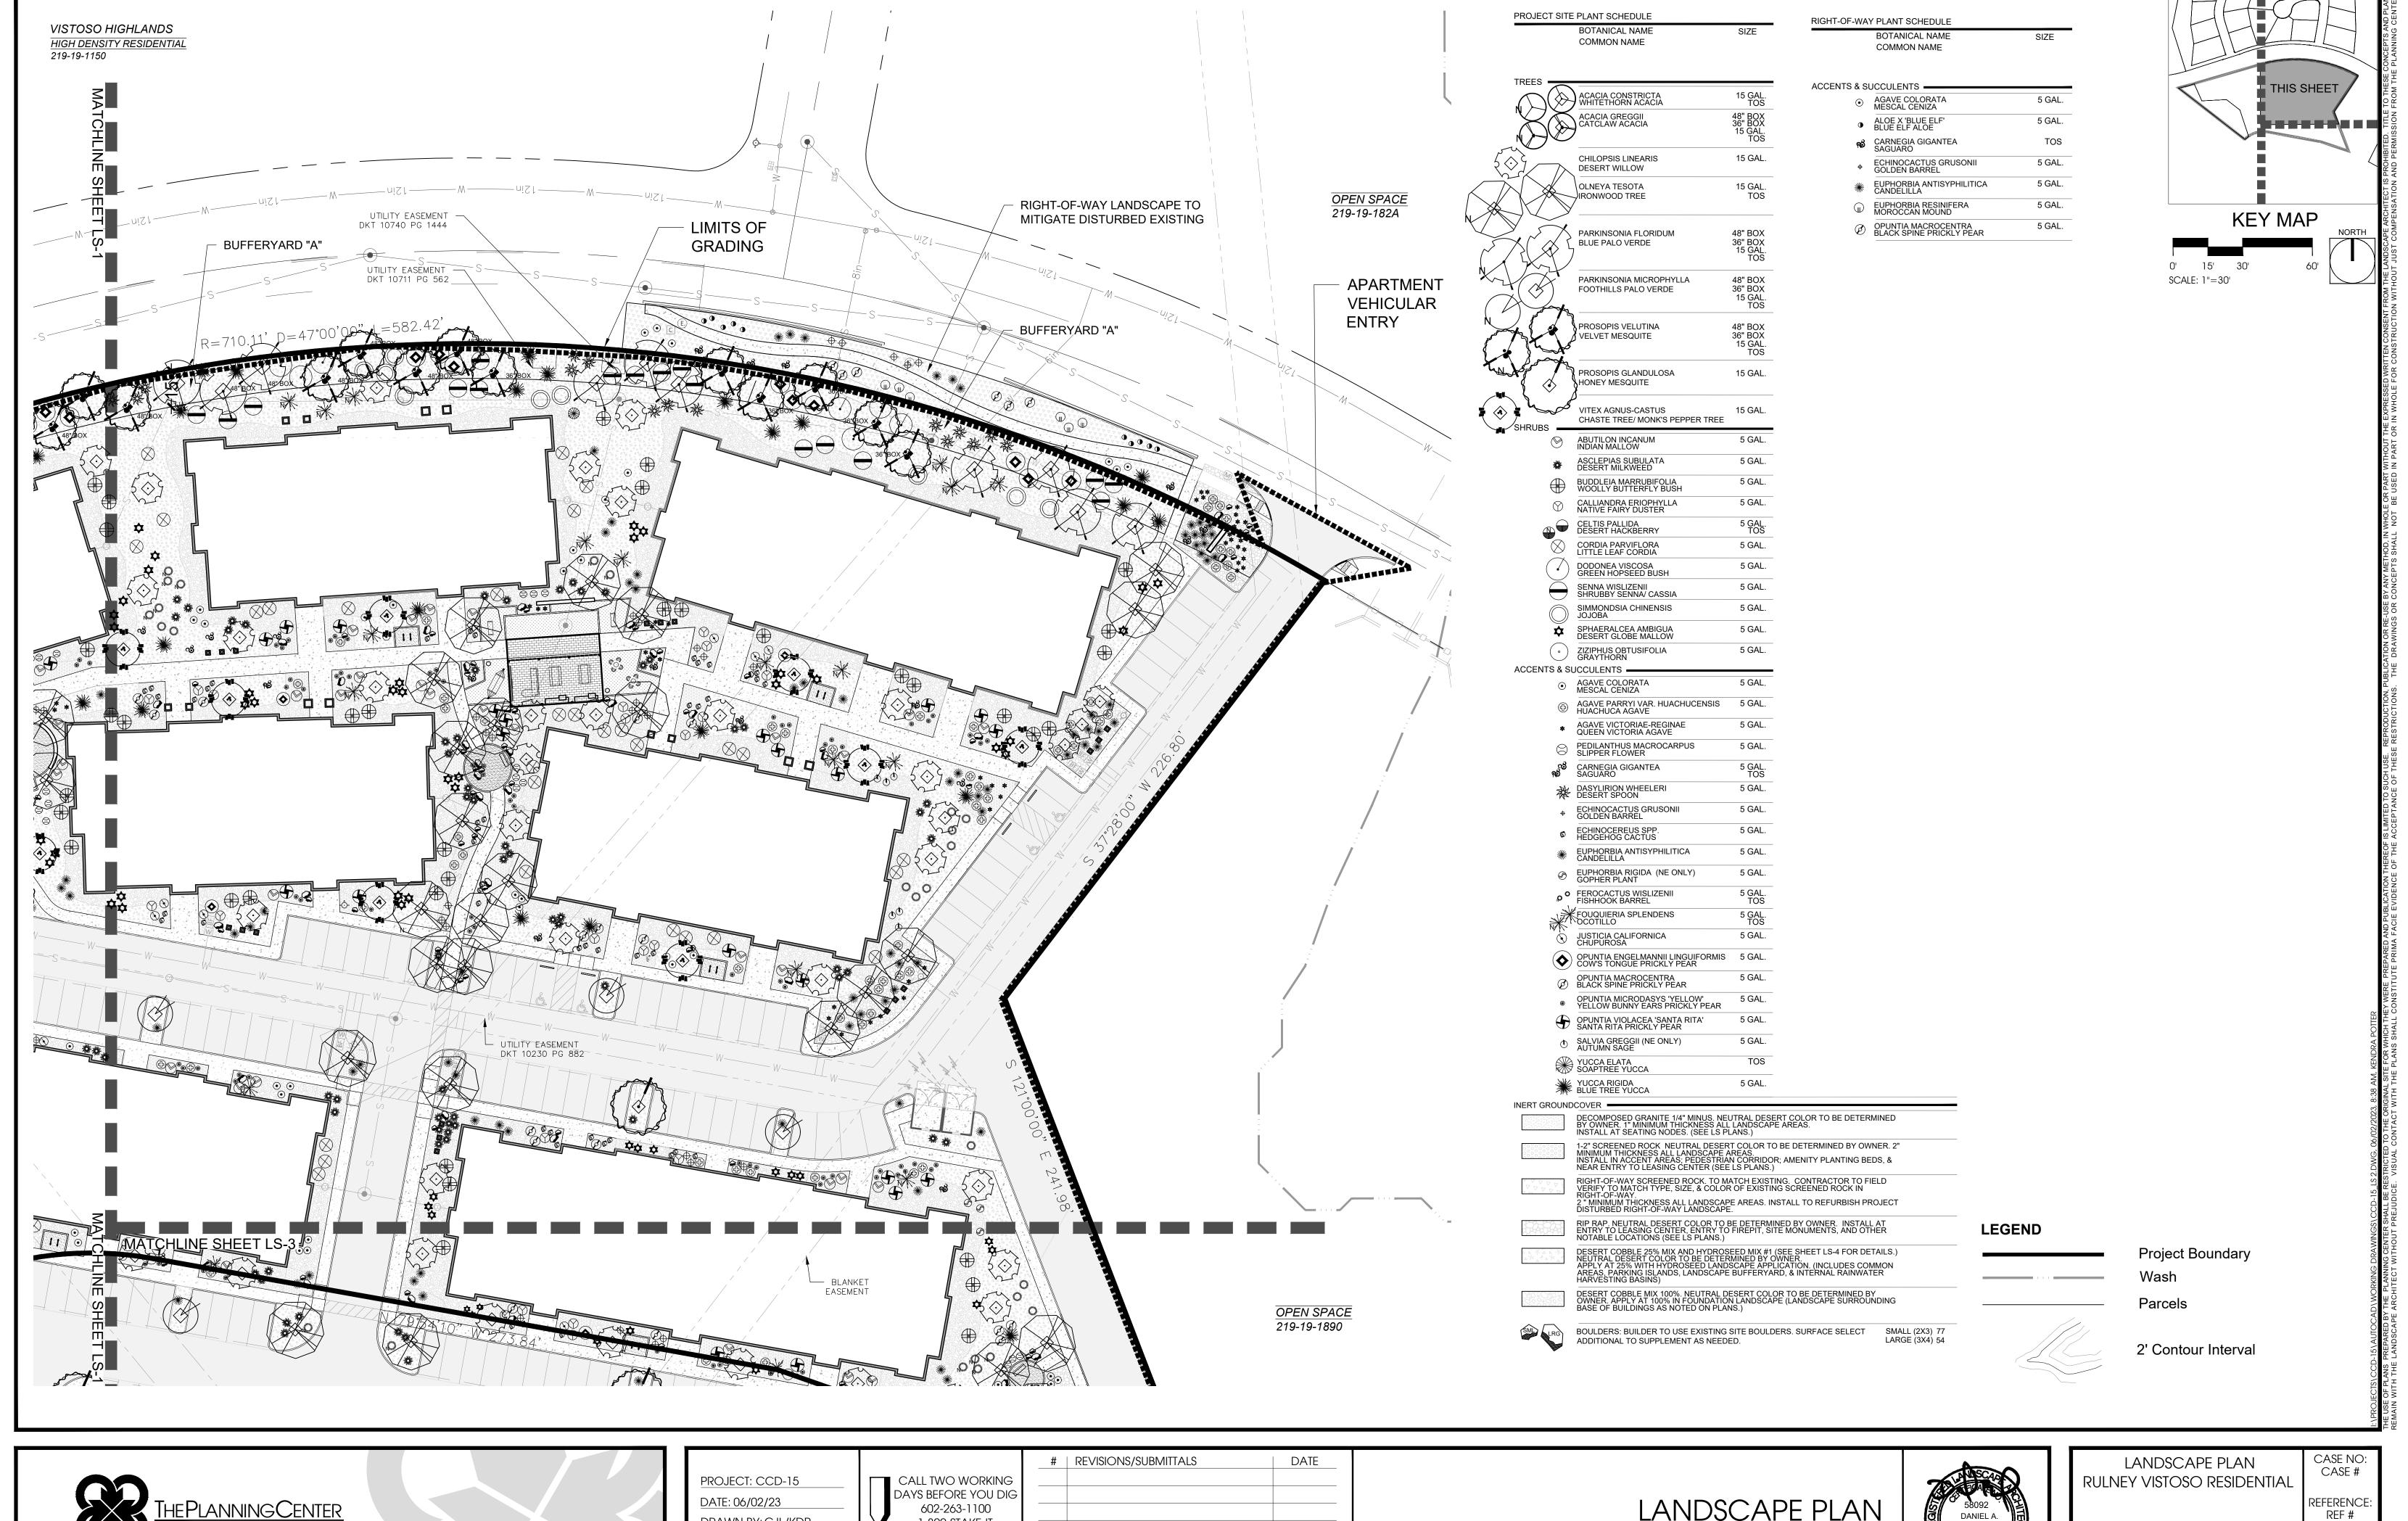

PROJECT: CCD-15 DATE: 06/02/23	CALL TWO WORKING DAYS BEFORE YOU DIG	
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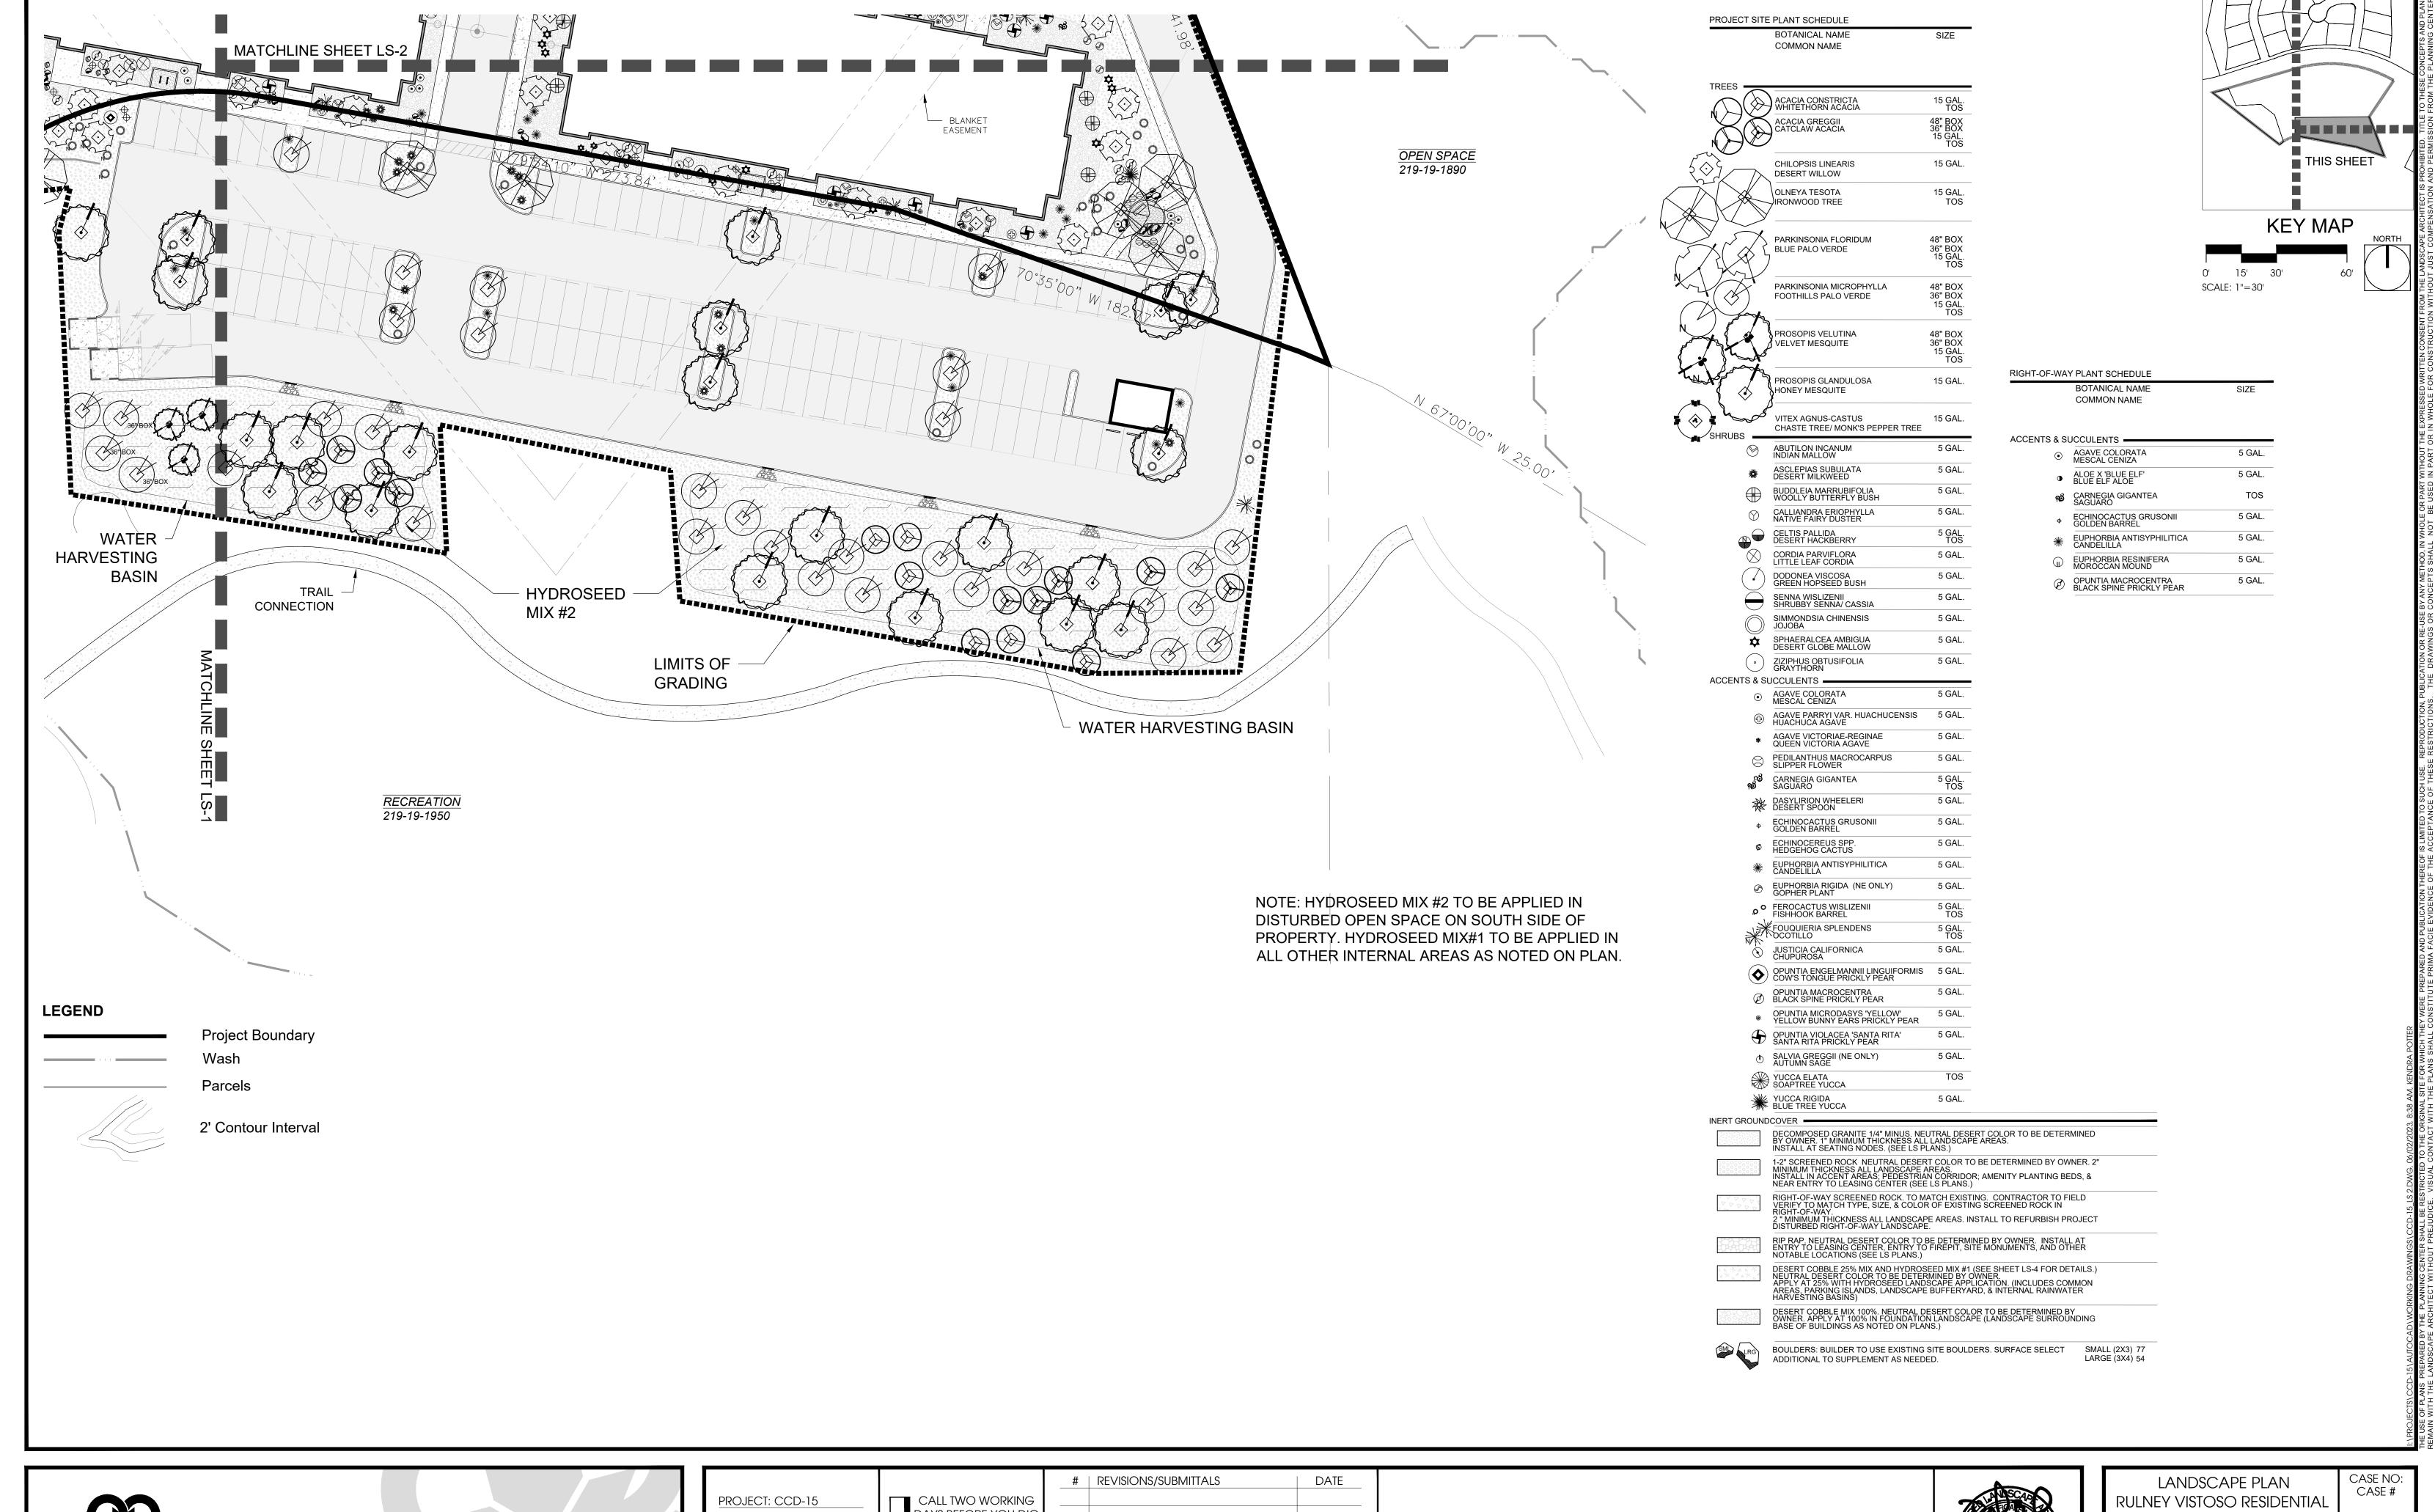
	LANDSCAPE PLAN
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LANDSCAPE PLAN RULNEY VISTOSO RESIDENTIAL	(
ROLIVET VIOLOGO REGIDEIVITA	RE
A PORTION OF THE S.E. 1/4 OF SECTION 23, TOWNSHIP 11 SOUTH, RANGE 13 EAST,	

G.&S.R.M., TOWN OF ORO VALLEY, PIMA COUNTY, ARIZONA

LS-2



THE PLANNING CENTER a division of TPC Group, Inc. 2 e congress ste 600 tucson az 85701 520.623.6146 520.622.1950 azplanningcenter.com

DAYS BEFORE YOU DIG DATE: 06/02/23 602-263-1100 DRAWN BY: CJL/KDP 1-800-STAKE-IT (OUTSIDE CHECKED BY: DB MARICOPA COUNTY)



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LANDSCAPE PLAN
RULNEY VISTOSO RESIDENTIAI

REFERENCE REF# A PORTION OF THE S.E. 1/4 OF SECTION 23, TOWNSHIP 11 SOUTH, RANGE 13 EAST LS-3 G.&S.R.M., TOWN OF ORO VALLEY, PIMA COUNTY, ARIZONA 15 OF 28

PLANTING NOTES

- 1. The owner's representative shall reserve the right to refuse any plant materials that are deemed unacceptable
- The owner's representative shall approve all material substitutions.
- 3. All plant material and specifications shall conform to the Arizona Nursery Association standards.
- 4. Plants shall feature growth habit that is normal for the species. Plants shall be healthy, vigorous, and free from disease, insect, or injury.
- All plant material shall be guaranteed for a period of one (1) year after final acceptance.
- 6. Plants shall be installed near sidewalks and hardscape areas with sufficient space for future growth (to full maturity) without the obstruction of adjacent pedestrian/vehicular circulation. The owner's representative shall approve of plan installation locations. Any plant location that is deemed "too close" to sidewalk or hardscape shall be relocated.
- 7. Young plants must be easily visible in the landscape after installation, to ensure that they are not trampled, neglected, or covered with rock mulch. Contractor shall flag any newly installed shrub, ground cover, or accent plant under 3" in height (above screened rock mulch) through the first season of growth. All deciduous shrubs and ground covers installed during the months of December-February and under 6" in height (above screened rock mulch) shall be flagged through the first growth season.
- 8. Contractor shall provide incidental grading in all landscaped areas to bring ground to finish grade, per civil and landscape plans. Finish grade shall be raked smooth before and after installation of plants, in preparation to receive screened decorative rock mulch. No screened rock mulch shall be applied to finish grade that is pock marked, trampled, settled, or eroded until after incidental grading to smooth surface.
- 9. All decorative screened rock shall be 1/2" (min.) below sidewalks and hardscape surfaces.
- 10. Contractor shall call in an Arizona 811 request at least 48 hours prior to any construction.
- 11. All signage and lighting to be addressed as part of a separate review and approval
- 12. All meters, shall have a backflow protection device installed on the customer side of the
- 13. Trees and shrubs shall be adequately supported when planted.
- 14. One (1) landscape island shall be placed every 9 parking spaces. One (1) canopy tree shall be planted per each landscape island. Per Oro Valley General Development code section C.6.B.ii.
- 15. Every landscape island in parking areas shall be designed for rainwater harvest. Per Oro Valley General Development Code Section C.6.B.ii.
- 16. A license agreement must be approved by town council prior to planting any landscape materials in the town right of way. Walls shall require a separate permit.

ROJECT	SITE PLANT SCHEDULE							RIGHT-OF-WA	AY PLANT SCHEDULE						
	BOTANICAL NAME COMMON NAME	SIZE	QTY	WATER USE TYPE	ADWR ANNUAL USE AT MATURITY (GAL)	ANNUAL WATER USE (GAL)	MONTHLY WATER USE (GAL)		BOTANICAL NAME COMMON NAME	SIZE	QTY	WATEF USE TYPE	ANNUAL	ANNUAL WATER USE (GAL)	MONTHI WATER USE (GAL)
REES -	ACACIA CONSTRICTA	15 GAL.	8	1	1 754	19,294	1608	ACCENTS & S	AGAVE COLORATA MESCAL CENIZA	5 GAL.	6	1	39	234	2
	WHITETHORN ACACIA	TOS	1	1	1,754 1,754	1,754	1608 146	\odot	MESCAL CENIZA						
	ACACIA GREGGII CATCLAW ACACIA	48" BOX 36" BOX	3	1	1,754 1,754	5,262 5,262	439 439	•	ALOE X 'BLUE ELF' BLUE ELF ALOE	5 GAL.	10	2	912	9,120	76
	<i></i>	15 GÅL. TOS	26 2	1	1,754 1,754	43,850 3,508	3,654 292	କ୍ଷ	CARNEGIA GIGANTEA SAGUARO	TOS	4	1	2,741	16,446	1,37
7	CHILOPSIS LINEARIS DESERT WILLOW	15 GAL.	42	2	5,702	119,742	9,979	•	ECHINOCACTUS GRUSONII GOLDEN BARREL	5 GAL.	5	3	29	145	1.
	OLNEYA TESOTA	15 GAL.	35	1	2,741	120,604	10,050	*	EUPHORBIA ANTISYPHILITICA CANDELILLA	5 GAL.	6	1	39	234	2
	IRONWOOD TREE	TOS	2	1	2,741	5,482	457		EUPHORBIA RESINIFERA MOROCCAN MOUND	5 GAL.	6	1	39	234	2
7 ~	PARKINSONIA FLORIDUM	48" BOX	2	2	5,702	11,404	950	Ø	OPUNTIA MACROCENTRA BLACK SPINE PRICKLY PEAR	5 GAL.	6	1	158	948	7
	BLUE PALO VERDE	36" BOX 36" BOX 15 GAL. TOS	2 15 2	2 2 2 2	5,702 5,702 5,702 5,702	11,404 11,404 96,934 11,404	950 950 8,078 950	NOTE: THE	PLANTS ON THE RIGH	IT OF WA	Y PI	_ANT	SCHE	DULE	
	PARKINSONIA MICROPHYLLA	48" BOX	12	1	1,754	21,048	1,754	REPRESEN	T THOSE PLANTS IDEI	NTIFIED A	AS P	ART	OF THE	EEXIS	TING
$(\ \ \ \ \ \ \ \ \ \ \ \ \ $	FOOTHILLS PALO VERDE	36" BOX 15 GAL.	12	1	1,754 1,754	21,048 117,518	1,754	RIGHT-OF-V	WAY LANDSCAPE.						
\ Ja	*	TOS	63 12	1	1,754	21,048	9,793 1,754	1410111-01-1	Will English E.						

2,851 2,851 14,255 950

34,212 34,212 171,060 11,404

5,702 5,702 5,702 5,702

57

219

439

405

39

110

57

101

158

5 GAL. 27 1 158 15,484

5 GAL. 111 1 158 5,214

5 GAL. 27 1 158 948

5 GAL. 6 2 57 342

1 1 281

5 GAL. 37 1 110 4,070

3,627

171

1,124 5,058

1,717

5,214

281

94 422

143

435

5 GAL. 39 3 29 1,363 114

5 GAL. 3 1 1,754 5,262

5 GAL. 52 1 39

5 GAL. 170 1 39

5 GAL. 62

5 GAL.

14,487

16,432

15 GAL. 52 2 5,702 205,272 17,106

15 GAL. 9 2 3,960

5 GAL. 50 2 39

HYDROSEED MIX #1 NO TREES (FOR USES INTERNAL TO THE PROJECT)

SHRUB

AMBROSIA DELTOIDEA TRIANGLE LEAF BURSAGE PLS/ACRE ATRIPLEX CANESCENS SALT BUSH PLS/ACRE PLS/ACRE CALLIANDRA EROPHYLLA NATIVE FAIRY DUSTER **ENCELIA FARINOSA** BRITTLEBUSH PLS/ACRE LARREA TRIDENTATA CREOSOTE 2 PLS/ACRE **SMALL PERENNIALS**

DESERT SENNA CASSIA COVESII

ANNUAL HERBS AND GRASSES SPHAERALCEA AMBIGUA DESERT GLOBE MALLOW PLS/ACRE PENSTEMON PARRYI PLS/ACRE PARRY'S PENSTEMON ESCHSCHOLTZIA MEXICANA MEXICAN POPPY PLS/ACRE

20 PLS/ACRE

PLS/ACRE

HYDROSEED MIX #2 EXTERNAL WITH TREES (FOR USE ALONG EXTERNAL WESTERN & **SOUTHERN PROJECT BOUNDARIES)**

NOTE: HYDROSEED MIX #2 MEETS ADDENDUM (D) ORO VALLEY APPROVED REVEGETATION SEED MIX PER TOWN OF ORO VALLEY ZONING CODE.

TREES

CHILOPSIS LINEARA **DESERT WILLOW** 0.5 PLS/ACRE OLNEYA TESOTA **IRONWOOD** PLS/ACRE PLS/ACRE PARKINSONIA FLORIDA **BLUE PALO VERDE** PARKINSONIA MICROPHYLLUM FOOTHILLS PAL VERDE PLS/ACRE VELVET MESQUITE PLS/ACRE PROSOPIS VELUTINA 0.5 PLS/ACRE SAMBUCAS MEXICANA MEXICAN ELDERBERRY

SHRUBS

REQUIRED:AT LEAST 4 SPECIES & MIN. 5 PLS/ACRE

TRIANGLE LEAF BURSAGE PLS/ACRE AMBROSIA DELTOIDEA CALLIANDRA ERIOPHYLLA **FAIRY DUSTER** PLS/ACRE PLS/ACRE **ENCELIA FARINOSA BRITTLEBUSH** LARREA TRIDENTATA CREOSOTE PLS/ACRE

SMALL PERENNIALS

REQUIRED AT LEAST 4 SPECIES & MIN 5 PLS/ACRE

PLS/ACRE **DESERT MARIGOLD** BAILEYA MULTIRADIATA **PSILOSTROPHE COOPERI** PAPER FLOWER PLS/ACRE PLS/ACRE SPHAERALCEA AMBIGUA DESERT GLOBEMALLOW ZINNIA PUMILA **DESERT ZINNIA** PLS/ACRE

PERENNIAL GRASSES

REQUIRED AT LEAST 4 SPECIES & MIN 5 PLS/ACRE

ARISTIDA PURPUREA **PURPLE THREE-AWN** PLS/ACRE **BOUTELOUA CURTIPENDULA** SIDE-OATS GRAMA PLS/ACRE DIGITARIA CALIFORNICA ARIZONA COTTONTOP 0.5 PLS/ACRE **ERAGROSTIS INTERMEDIA** PLAINS LOVE GRASS PLS/ACRE SPOROBOULS CRYPTANDRUS 0.5 PLS/ACRE SAND DROPSEED

ANNUAL HERBS & GRASSES

REQUIRED AT LEAST 4 SPECIES & MIN 5 PLS/ACRE

DATURA DISCOLOR ERIGERON DIVERGENS KALLSTROEMIA GRANDIFLORA **LUPINUS SPARSIFLORUS** PENSTEMON PARRYI

0.5 PLS/ACRE SACRED DATURA 0.5 PLS/ACRE SPREADING FLEABANE PLS/ACRE ARIZONA POPPY **DESERT LUPINE** PLS/ACRE PARRY'S PENSTEMON PLS/ACRE

> 27 PLS/ACRE

BOULDERS: BUILDER TO USE EXISTING SITE BOULDERS. SURFACE SELECT

DESERT COBBLE MIX 100%. NEUTRAL DESERT COLOR TO BE DETERMINED BY OWNER. APPLY AT 100% IN FOUNDATION LANDSCAPE (LANDSCAPE SURROUNDING BASE OF BUILDINGS AS NOTED ON PLANS.)

DECOMPOSED GRANITE 1/4" MINUS. NEUTRAL DESERT COLOR TO BE DETERMINED BY OWNER. 1" MINIMUM THICKNESS ALL LANDSCAPE AREAS. INSTALL AT SEATING NODES. (SEE LS PLANS.)

1-2" SCREENED ROCK NEUTRAL DESERT COLOR TO BE DETERMINED BY OWNER. 2" MINIMUM THICKNESS ALL LANDSCAPE AREAS.
INSTALL IN ACCENT AREAS; PEDESTRIAN CORRIDOR; AMENITY PLANTING BEDS, & NEAR ENTRY TO LEASING CENTER (SEE LS PLANS.)

RIGHT-OF-WAY.

2 " MINIMUM THICKNESS ALL LANDSCAPE AREAS. INSTALL TO REFURBISH PROJECT DISTURBED RIGHT-OF-WAY LANDSCAPE.

RIGHT-OF-WAY SCREENED ROCK. TO MATCH EXISTING. CONTRACTOR TO FIELD VERIFY TO MATCH TYPE, SIZE, & COLOR OF EXISTING SCREENED ROCK IN

RIP RAP. NEUTRAL DESERT COLOR TO BE DETERMINED BY OWNER. INSTALL AT ENTRY TO LEASING CENTER, ENTRY TO FIREPIT, SITE MONUMENTS, AND OTHER NOTABLE LOCATIONS (SEE LS PLANS.)

DESERT COBBLE 25% MIX AND HYDROSEED MIX #1 (SEE SHEET LS-4 FOR DETAILS.)
NEUTRAL DESERT COLOR TO BE DETERMINED BY OWNER.
APPLY AT 25% WITH HYDROSEED LANDSCAPE APPLICATION. (INCLUDES COMMON AREAS, PARKING ISLANDS, LANDSCAPE BUFFERYARD, & INTERNAL RAINWATER

48" BOX 36" BOX 15 GAL. TOS

PROSOPIS VELUTINA

PROSOPIS GLANDULOSA

VITEX AGNUS-CASTUS

CHASTE TREE/ MONK'S PEPPER TREE

VELVET MESQUITE

HONEY MESQUITE

ABUTILON INCANUM INDIAN MALLOW

ASCLEPIAS SUBULATA DESERT MILKWEED

CALLIANDRA ERIOPHYLLA NATIVE FAIRY DUSTER

CORDIA PARVIFLORA LITTLE LEAF CORDIA

DODONEA VISCOSA GREEN HOPSEED BUSH

SIMMONDSIA CHINENSIS JOJOBA

GAGAVE PARRYI VAR. HUACHUCENSIS HUACHUCA AGAVE

PEDILANTHUS MACROCARPUS SLIPPER FLOWER

SENNA WISLIZENII SHRUBBY SENNA/ CASSIA

SPHAERALCEA AMBIGUA DESERT GLOBE MALLOW

ZIZIPHUS OBTUSIFOLIA GRAYTHORN

AGAVE COLORATA MESCAL CENIZA

CARNEGIA GIGANTEA

MEDGEHOG CACTUS

DASYLIRION WHEELERI DESERT SPOON

ECHINOCACTUS GRUSONII
 GOLDEN BARREL

EUPHORBIA ANTISYPHILITICACANDELILLA

© EUPHORBIA RIGIDA (NE ONLY) GOPHER PLANT

FOUQUIERIA SPLENDENS

JUSTICIA CALIFORNICA CHUPUROSA

OPUNTIA MACROCENTRA BLACK SPINE PRICKLY PEAR

YUCCA ELATA SOAPTREE YUCCA

INERT GROUNDCOVER -

OPUNTIA VIOLACEA 'SANTA RITA' SANTA RITA PRICKLY PEAR

ACCENTS & SUCCULENTS -

(◆ •


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PROJECT: CCD-15 DATE: 06/02/23 DRAWN BY: CJL/KDP CHECKED BY: DB

CALL TWO WORKING DAYS BEFORE YOU DIG 602-263-1100 1-800-STAKE-IT (OUTSIDE MARICOPA COUNTY)

| REVISIONS/SUBMITTALS DATE

LANDSCAPE NOTES

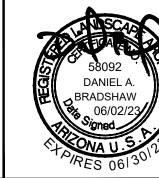

LANDSCAPE PLAN **RULNEY VISTOSO RESIDENTIAI**

A PORTION OF THE S.E. 1/4 OF SECTION 23, TOWNSHIP 11 SOUTH, RANGE 13 EAST G.&S.R.M., TOWN OF ORO VALLEY, PIMA COUNTY, ARIZONA

CASE NO:


CASE #

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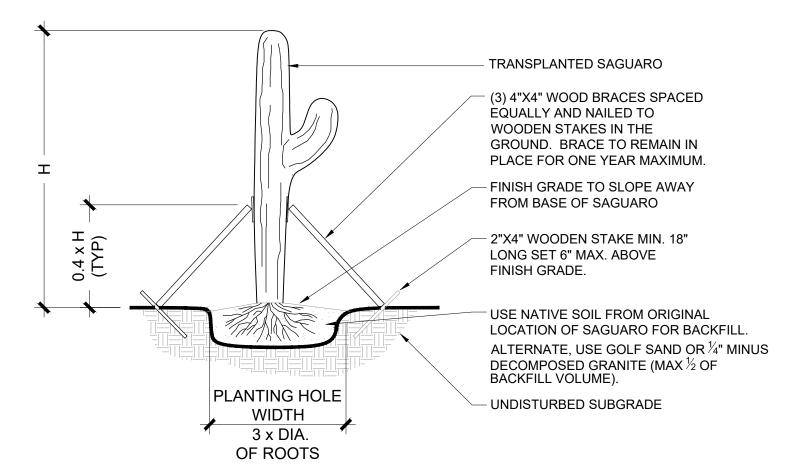
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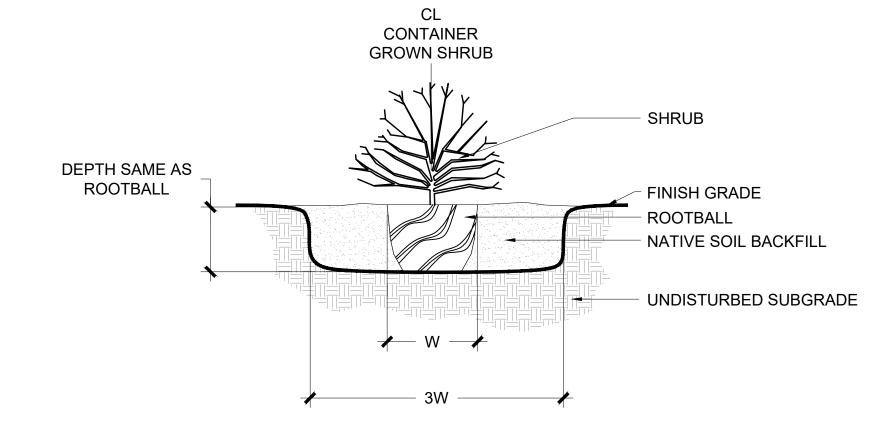
- 1. MARK THE NORTH SIDE OF THE TREE IN THE FIELD BEFORE TRANSPLANTING, AND WHEN TRANSPLANTING ROTATE THE TREE TO FACE NORTH, WHENEVER POSSIBLE
- 2. STAKING SHALL BE CONSTRUCTED SO TRUNK HAS FLEXIBILITY.
- 3. SUFFICIENT CLEARANCE SHALL BE MAINTAINED BETWEEN PLANTS AND UTILITY FACILITIES SO AS TO NOT HINDER UTILITY MAINTENANCE.
- 4. PRUNE TREE AT TIME OF STAKE REMOVAL, ONE YEAR AFTER INSTALLATION.
- 5. TREES SHALL BE MAINTAINED IN THEIR NATURAL FORM. OVER PRUNING AND/OR "BALLING" IS PROHIBITED.





- 1. ROOT PRUNE ALL SHREDDED OR DAMAGED ROOTS & DUST ENTIRE ROOT STRUCTURE WITH WETTABLE SULFUR (1.5 MIN) AND STREPTOMYCIN SPRAY AT PLANTING SITE. ROOTBALL SHALL BE 24" MIN WITH A MINIMUM ROOT LENGTH OF 6" ALL SIDES.
- 2. 2. CONTRACTOR TO USE ONLY SAGUAROS ORIENTED WITH TRUE NORTH AND LOCATE IN HOLE WITH USE OF COMPASS.
- 3. TRANSPLANT TO ORIGINAL DEPTH OF BURY.
- 4. LENGTH OF WOOD BRACES AND DISTANCE FROM BASE WILL VARY WITH HEIGHT AND WEIGHT OF SAGUARO AS WELL AS SLOPE OF GRADE. CUT AND POSITION STAKES AT AN ANGLE TO BEST SUPPORT EACH INDIVIDUAL SAGUARO.
- 5. DO NOT WATER.
- 6. REPLANT AND RESTAKE IF SAGUARO BECOMES UNSTABLE DUE TO WIND, RAIN, OVER WATERING, OR ANY OTHER REASON.

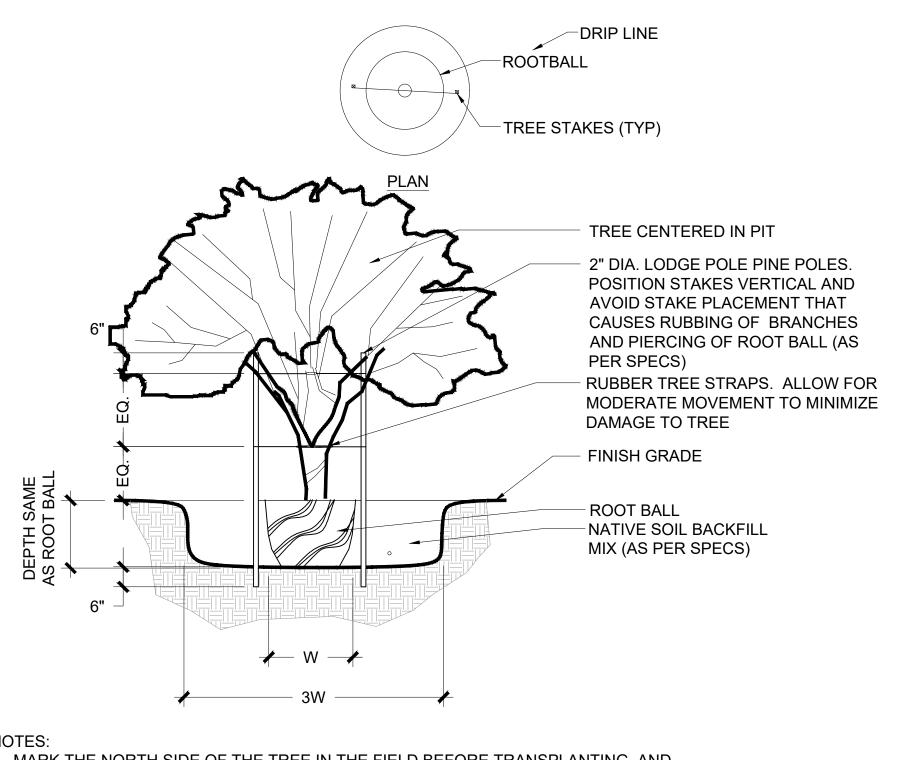SAGUARO INSTALLATION




NOTES:

- 1. SUFFICIENT CLEARANCE SHALL BE MAINTAINED BETWEEN PLANTS AND UTILITY FACILITIES SO AS TO NOT HINDER UTILITY MAINTENANCE.
- 2. CONTRACTOR SHALL ASSURE THAT PLANTS ARE LOCATED SO THAT AT FULL GROWTH PLANTS DO NOT INTERFERE WITH HARDSCAPE SURFACES SUCH AS WALKS AND PATHS
- 3. PLANTS SHALL BE MAINTAINED IN THEIR NATURAL FORM. OVER PRUNING AND/OR "BALLING" IS PROHIBITED.
- 4. BLOOMING AGAVES SHALL NOT BE REPLACED UNTIL BLOOM AND STALK ARE COMPLETELY SPENT. 5. BLOOM STALKS OF OTHER ACCENTS SUCH AS DESERT SPOONS AND YUCCAS SHALL REMAIN IN PLACE UNTIL STALK IS COMPLETELY SPENT.

SHRUB & ACCENT PLANTING

SCALE: NTS

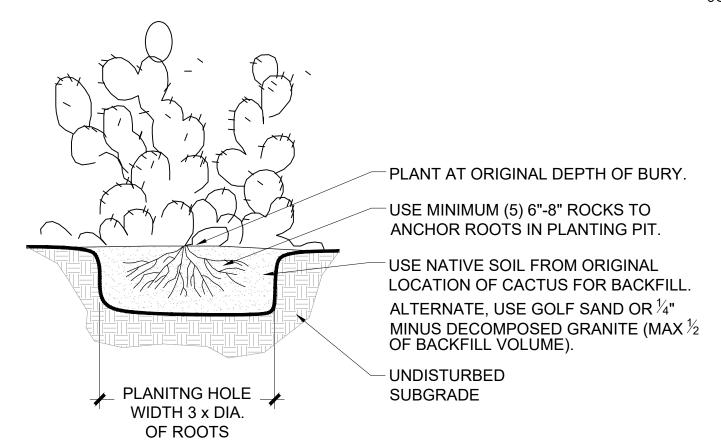

NOTES:

- 1. ROOT PRUNE ALL SHREDDED OR DAMAGED ROOTS & DUST ENTIRE ROOT STRUCTURE WITH WETTABLE SULFUR (1.5 MIN) AND STREPTOMYCIN SPRAY AT PLANTING SITE. ROOTBALL SHALL BE 24" MIN WITH A MINIMUM ROOT LENGTH OF 6" ALL SIDES
- 2. WATER WITH INSTALLATION AND WATER WEEKLY UNTIL MONSOONS ARRIVE IF TRANSPLANTED BETWEEN MAY-AUGUST.
- 3. REPLANT IF CACTUS BECOMES UNSTABLE DUE TO WIND, RAIN, OVER WATERING, OR ANY OTHER REASON.

SMALL CACTUS INSTALLATION

TEMPORARY WIDTH AS DETERMINED BY CONTRACTOR CONSTRUCTION FENCING (TYPE TO BE **DETERMINED BY** CONTRACTOR) **VERTICAL SUPPORT** (TYPE TO BE **DETERMINED BY** CONTRACTOR)

SCALE: NTS

1. TEMPORARY CONSTRUCTION FENCING TO BE PLACED AT LIMITS OF GRADING TO PROTECT EXISTING VEGETATION.

TEMPORARY CONSTRUCTION FENCE


OF AD PLANT AT ORIGINAL DEPTH OF USE MINIMUM (5) 6"-8" ROCKS TO ANCHOR ROOTS IN PLANTING PIT. USE NATIVE SOIL FROM ORIGINAL LOCATION OF OCOTILLO FOR BACKFILL. ALTERNATE, USE GOLF SAND OR 1/4" MINUS DECOMPOSED GRANITE (MAX ½ OF BACKFILL VOLUME). PLANITNG HOLE 🥢 WIDTH 3 x DIA. 🖈 - UNDISTURBED SUBGRADE OF ROOTS 1. ROOT PRUNE ALL SHREDDED OR DAMAGED ROOTS & DUST ENTIRE ROOT STRUCTURE WITH WETTABLE SULFUR

(1.5 MIN) AND STREPTOMYCIN SPRAY AT PLANTING SITE. ROOTBALL SHALL BE 24" MIN WITH A MINIMUM ROOT

2. WATER WITH INSTALLATION AND WATER WEEKLY UNTIL MONSOONS ARRIVE IF TRANSPLANTED BETWEEN

3. REPLANT IF OCOTILLO BECOMES UNSTABLE DUE TO WIND, RAIN, OVER WATERING, OR ANY OTHER REASON.

OCOTILLO PLANTING

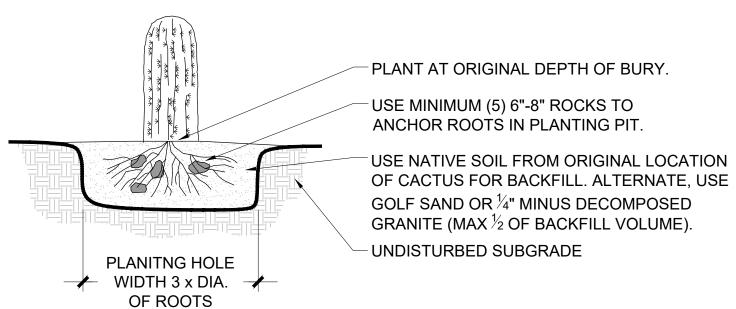


- 1. ROOT PRUNE ALL SHREDDED OR DAMAGED ROOTS & DUST ENTIRE ROOT STRUCTURE WITH WETTABLE SULFUR (1.5 MIN) AND STREPTOMYCIN SPRAY AT PLANTING SITE. ROOTBALL SHALL BE
- 24" MIN WITH A MINIMUM ROOT ENGTH OF 6" ALL SIDES. 2. WATER WITH INSTALLATION AND WATER WEEKLY UNTIL
- MONSOONS ARRIVE IF TRANSPLANTED BETWEEN MAY-AUGUST. REPLANT IF BARREL CACTUS BECOMES UNSTABLE DUE TO WIND, RAIN, OVER WATERING, OR ANY OTHER REASON.

BARREL CACTUS PLANTING

ALL BOULDERS TO BE SURFACE SELECT, FREE FROM SCARS, CHIPS AND ABRASIONS. LANDSCAPE CONTRACTOR TO TREAT ALL DEFECTS WITH 'EONITE' TO PROVIDE A WEATHERED, NATURAL APPEARANCE.

DEPRESS BOULDER MASS 1/3 BELOW GRADE AS SHOWN.

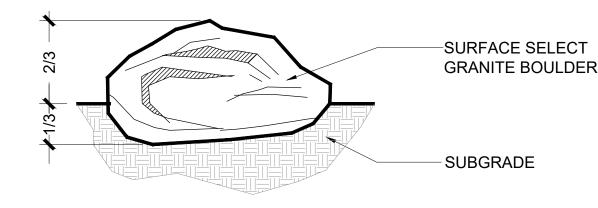

BOULDER PLACEMENT

THE PLANNING CENTER a division of TPC Group, Inc 2 e congress ste 600 tucson az 85701 520.623.6146 520.622.1950 azplanningcenter.com

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LANDSCAPE DETAILS



LANDSCAPE PLAN **RULNEY VISTOSO RESIDENTIAL**

A PORTION OF THE S.E. 1/4 OF SECTION 23, TOWNSHIP 11 SOUTH, RANGE 13 EAST G.&S.R.M., TOWN OF ORO VALLEY, PIMA


COUNTY, ARIZONA 17 OF 28

CASE NO:


CASE #

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LANDSCAPE PLAN RULNEY VISTOSO RESIDEN

REFERENCE REF# A PORTION OF THE S.E. 1/4 OF SECTION 23, TOWNSHIP 11 SOUTH, RANGE 13 EAST G.&S.R.M., TOWN OF ORO VALLEY, PIMA COUNTY, ARIZONA 18 OF 28

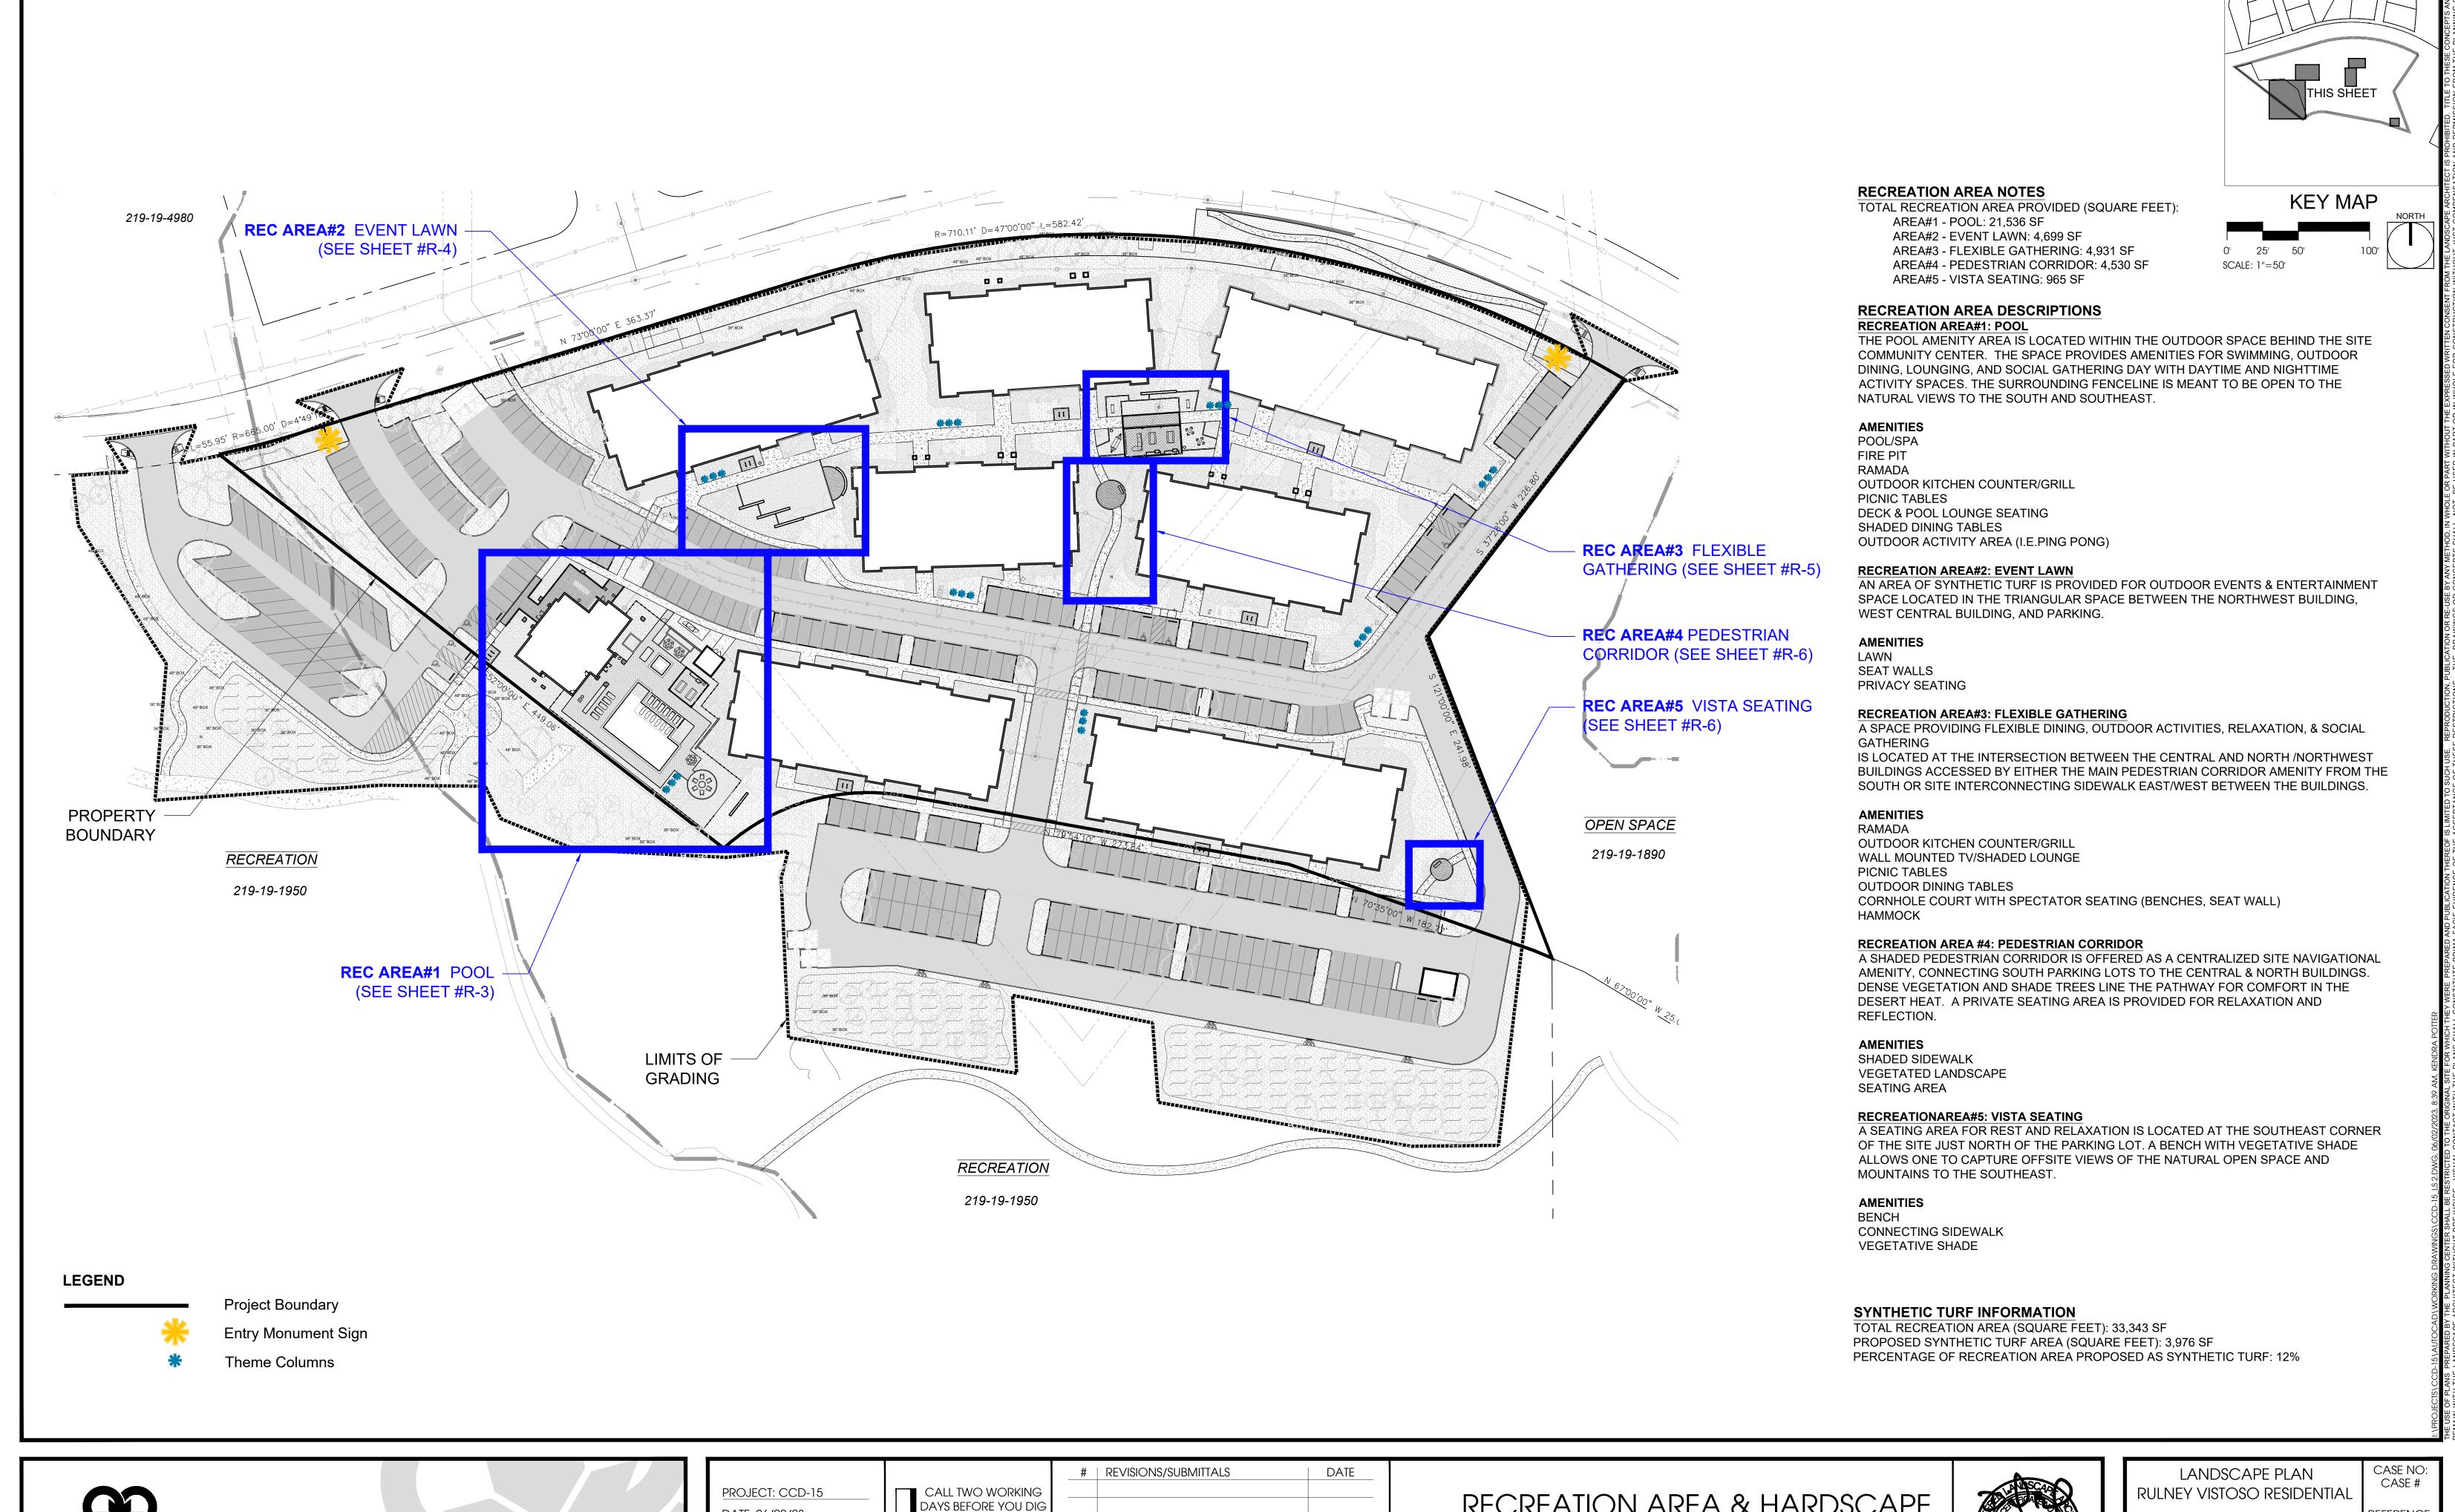MATERIAL SPECIFICATIONS

NOTE: SPECIFICATION NUMBER MATCHES NUMBER OF KEY NOTE ON LANDSCAPE RECREATION & HARDSCAPE PLANS (SEE THIS PAGE FOR LEGEND.)

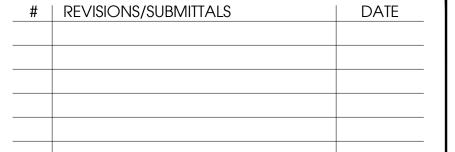HARDSCAPE SPECIFICATIONS (NOTE: ALL PRODUCTS & MATERIALS TO BE INSTALLED PER MANUFACTURER'S SPECIFICATIONS)

- 1. SYNTHETIC TURF (POOL LOUNGE, FLEX GATHERING SOCIAL AREAS, & EVENT LAWN): MFR. SOUTHWEST GREENS OF TUCSON (swgartificialgrasstucson.com) PRODUCT: BOLT 63 STYLE: GB-134 COLOR: 300 SPRING GREEN
- PILE HEIGHT: 1.625 FACE WEIGHT: 63 INSTALL ON $\frac{1}{4}$ " DG OF 3" DEPTH, COMPACTED TO 95%.
- SYNTHETIC TURF (CORNHOLE COURT): MFR. SOUTHEST GREENS OF TUCSON (swgartificialgrasstucson.com) PRODUCT: SWG BOCCE PRO STYLE: GB174 COLOR: 301 AMERICAN OLIVE PILE HEIGHT: 125 FACE WEIGHT: 31 INSTALL ON $\frac{1}{4}$ " DG OF 3" DEPTH, COMPACTED TO 95%.
- 2. DECORATIVE PAVER: NEUTRAL DESERT COLOR TO BE DETERMINED BY OWNER.
- 3. CONCRETE SIDEWALK: STANDARD CONCRETE PAVEMENT (SEE CIVIL PLANS FOR DETAIL)
- 4. CONCRETE HEADER: SEE DETAIL 2 SHEET LD-3
- 5. BICYCLE PARKING SURFACE & HEADER: SEE DETAILS 1 & 2 SHEET LD-4
- 6. RAISED PLANTER: SEE DETAIL 3SHEET LD-3
- 7. SEAT WALL: SEE DETAILS 5 & 6 SHEET LD-3
- 8. ENTRY MONUMENT SIGN: SEE DETAIL 5 SHEET LD-4
- 9. THEME COLUMN: SEE DETAIL 6 SHEET LD-4
- 10. THEME WALL: SEE DETAIL 3 SHEET LD-4
- 11. VIEW FENCE: TO BE DETERMINED BY OWNER. 12. GLASS FENCE: TO BE DETERMINED BY OWNER.

AMENITY & SITE FURNISHING SPECIFICATIONS (NOTE: ALL PRODUCTS & MATERIALS TO BE INSTALLED PER MANUFACTURER'S SPECIFICATIONS)

- 32. FIRE PIT: SEE DETAIL 1 SHEET LD-6
- 33. RAMADA: SEE DETAIL 1 SHEET LD-5
- 34. OUTDOOR KITCHEN COUNTER/GRILL: SEE DETAIL 2 SHEET LD-6
- 35. PICNIC TABLE: TO BE DETERMINED BY OWNER.
- 36. SHADED DINING TABLE WITH CHAIRS: TO BE DETERMINED BY OWNER.
- 37. COFFEE TABLE WITH CHAIRS: TO BE DETERMINED BY OWNER.
- 38. BACKLESS BENCH: TO BE DETERMINED BY OWNER.
- 39. HAMMOCK: TO BE DETERMINED BY OWNER.
- 40. RAMADA LOUNGE CHAIR: TO BE DETERMINED BY OWNER
- 41. DECK LOUNGE SEATING AREA (11 CHAIRS): TO BE DETERMINED BY OWNER.
- 42. POOL LOUNGE SEATING AREA (6 CHAIRS): TO BE DETERMINED BY OWNER
- 43. SHADED TV/ENTERTAINMENT WALL: SEE DETAIL 4 SHEET LD-4
- 44. OUTDOOR TELEVISION: TO BE DETERMINED BY OWNER.
- 45. CORNHOLE COURT: SEE DETAIL 3 SHEET LD-6
- 46. TRASH RECEPTACLE: COLOR: TO MATCH SITE FURNISHINGS PER OWNER SELECTION.
- 47. BICYCLE RACK: COLOR: TO MATCH SITE FURNISHINGS PER OWNER SELECTION.

LANDSCAPE SPECIFICATIONS: (NOTE: ALL PRODUCTS & MATERIALS TO BE INSTALLED PER MANUFACTURER'S SPECIFICATIONS)

- 70. DECOMPOSED GRANITE: $\frac{1}{4}$ " MINUS. COLOR: CONTRACTOR TO SELECT NEUTRAL DESERT COLOR DETERMINED BY OWNER.
- 71. 1-2" SCREENED ROCK: SIZE: 1" TO 2". COLOR: CONTRACTOR TO SELECT NEUTRAL DESERT COLOR DETERMINED BY OWNER.
- 72. *EXISTING RIGHT-OF-WAY SCREENED ROCK: CONTRACTOR TO FIELD VERIFY EXISTING SCREENED ROCK SIZE AND COLOR TO MATCH.
- 73. DECORATIVE RIP-RAP: SIZE: 2"-6" RIP-RAP. COLOR: CONTRACTOR TO SELECT NEUTRAL DESERT COLOR DETERMINED BY OWNER.
- 74. BOULDER (2'X3'): SIZE: 2'x3'. COLOR: CONTRACTOR TO SELECT NEUTRAL DESERT COLOR DETERMINED BY OWNER.
- 75. BOULDER (3'X4'): SIZE: 3'x4'. COLOR: CONTRACTOR TO SELECT NEUTRAL DESERT COLOR DETERMINED BY OWNER.
- 76. 100% SURFACE COVERAGE DESERT COBBLE DECORATIVE ROCK MIX: (40%) 3 SCREENED ROCK + (25%) 1 SCREENED ROCK + (20%) 2 SCREENED ROCK + (15%) 2 TO 4 RIP-RAP. COLOR: CONTRACTOR TO SELECT NEUTRAL DESERT COLOR DETERMINED BY OWNER.
- 77. 25% DESERT COBBLE DECORATIVE ROCK MIX & HYDROSEED: SIZE: 25% SURFACE COVERAGE OF DESERT COBBLE MIX AND 100% HYDROSEED SURFACE COVERAGE (SEE DESERT COBBLE DECORATIVE ROCK MIX.) COLOR: SEE DESERT COBBLE DECORATIVE ROCK MIX.
- 78. HYDROSEED MIX #1: FOR USE INTERNAL TO PROJECT BOUNDARY WITHOUT TREES: SEE LANDSCAPE PLAN NOTES SHEET LS-4
- 79. HYDROSEED MIX #2: FOR USE EXTERNAL TO WESTERN & SOUTHERN PROJECT BOUNDARIES WITH TREES: SEE LANDSCAPE PLAN NOTES SHEET LS-4

* NOTE: EXISTING RIGHT-OF-WAY AT LOCATION NOTED AS RIGHT-OF-WAY LANDSCAPE ON PLAN

KEY NOTES:

HARDSCAPE KEY NOTES

- (1) SYNTHETIC TURF
- (2) DECORATIVE PAVER
- 3 CONCRETE SIDEWALK
- (4) CONCRETE HEADER
- BICYCLE PARKING SURFACE & HEADER
- 6 RAISED PLANTER
- (7) SEAT WALL
- 8 ENTRY MONUMENT SIGN
- THEME COLUMN
- THEME WALL
- VIEW FENCE
- **GLASS FENCE**

AMENITY & SITE FURNISHING KEY NOTES

- POOL (DESIGNED AND PERMITTED BY OTHERS)
- (31) HOT TUB (DESIGNED AND PERMITTED BY OTHERS)
- FIRE PIT
- RAMADA
- OUTDOOR KITCHEN COUNTER/GRILL
- PICNIC TABLE
- SHADED DINING TABLE WITH CHAIRS
- COFFEE TABLE WITH CHAIRS
- BENCH
- HAMMOCK
- RAMADA LOUNGE CHAIR
- DECK LOUNGE SEATING AREA
- POOL LOUNGE SEATING AREA
- SHADED TV/ENTERTAINMENT WALL
- OUTDOOR TELEVISION
- CORNHOLE COURT
- TRASH RECEPTACLE
- BICYCLE RACK

LANDSCAPE KEY NOTES

- DECOMPOSED GRANITE
- 1-2" SCREENED ROCK
- EXISTING RIGHT-OF-WAY SCREENED ROCK
- DECORATIVE RIP-RAP
- BOULDER (2'X3')
- BOULDER (3'X4')
- 100% DESERT COBBLE DECORATIVE ROCK MIX
- 25% DESERT COBBLE DECORATIVE ROCK MIX & HYDROSEED
- HYDROSEED MIX #1 INTERNAL TO SITE BOUNDARY WITHOUT TREES
- HYDROSEED MIX #2 EXTERNAL TO SITE BOUNDARY WITH TREES




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RECREATION AREA & HARDSCAPE PLAN NOTES



LANDSCAPE PLAN **RULNEY VISTOSO RESIDENTIAL**

A PORTION OF THE S.E. 1/4 OF SECTION 23, TOWNSHIP 11 SOUTH, RANGE 13 EAST G.&S.R.M., TOWN OF ORO VALLEY, PIMA COUNTY, ARIZONA
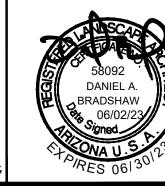
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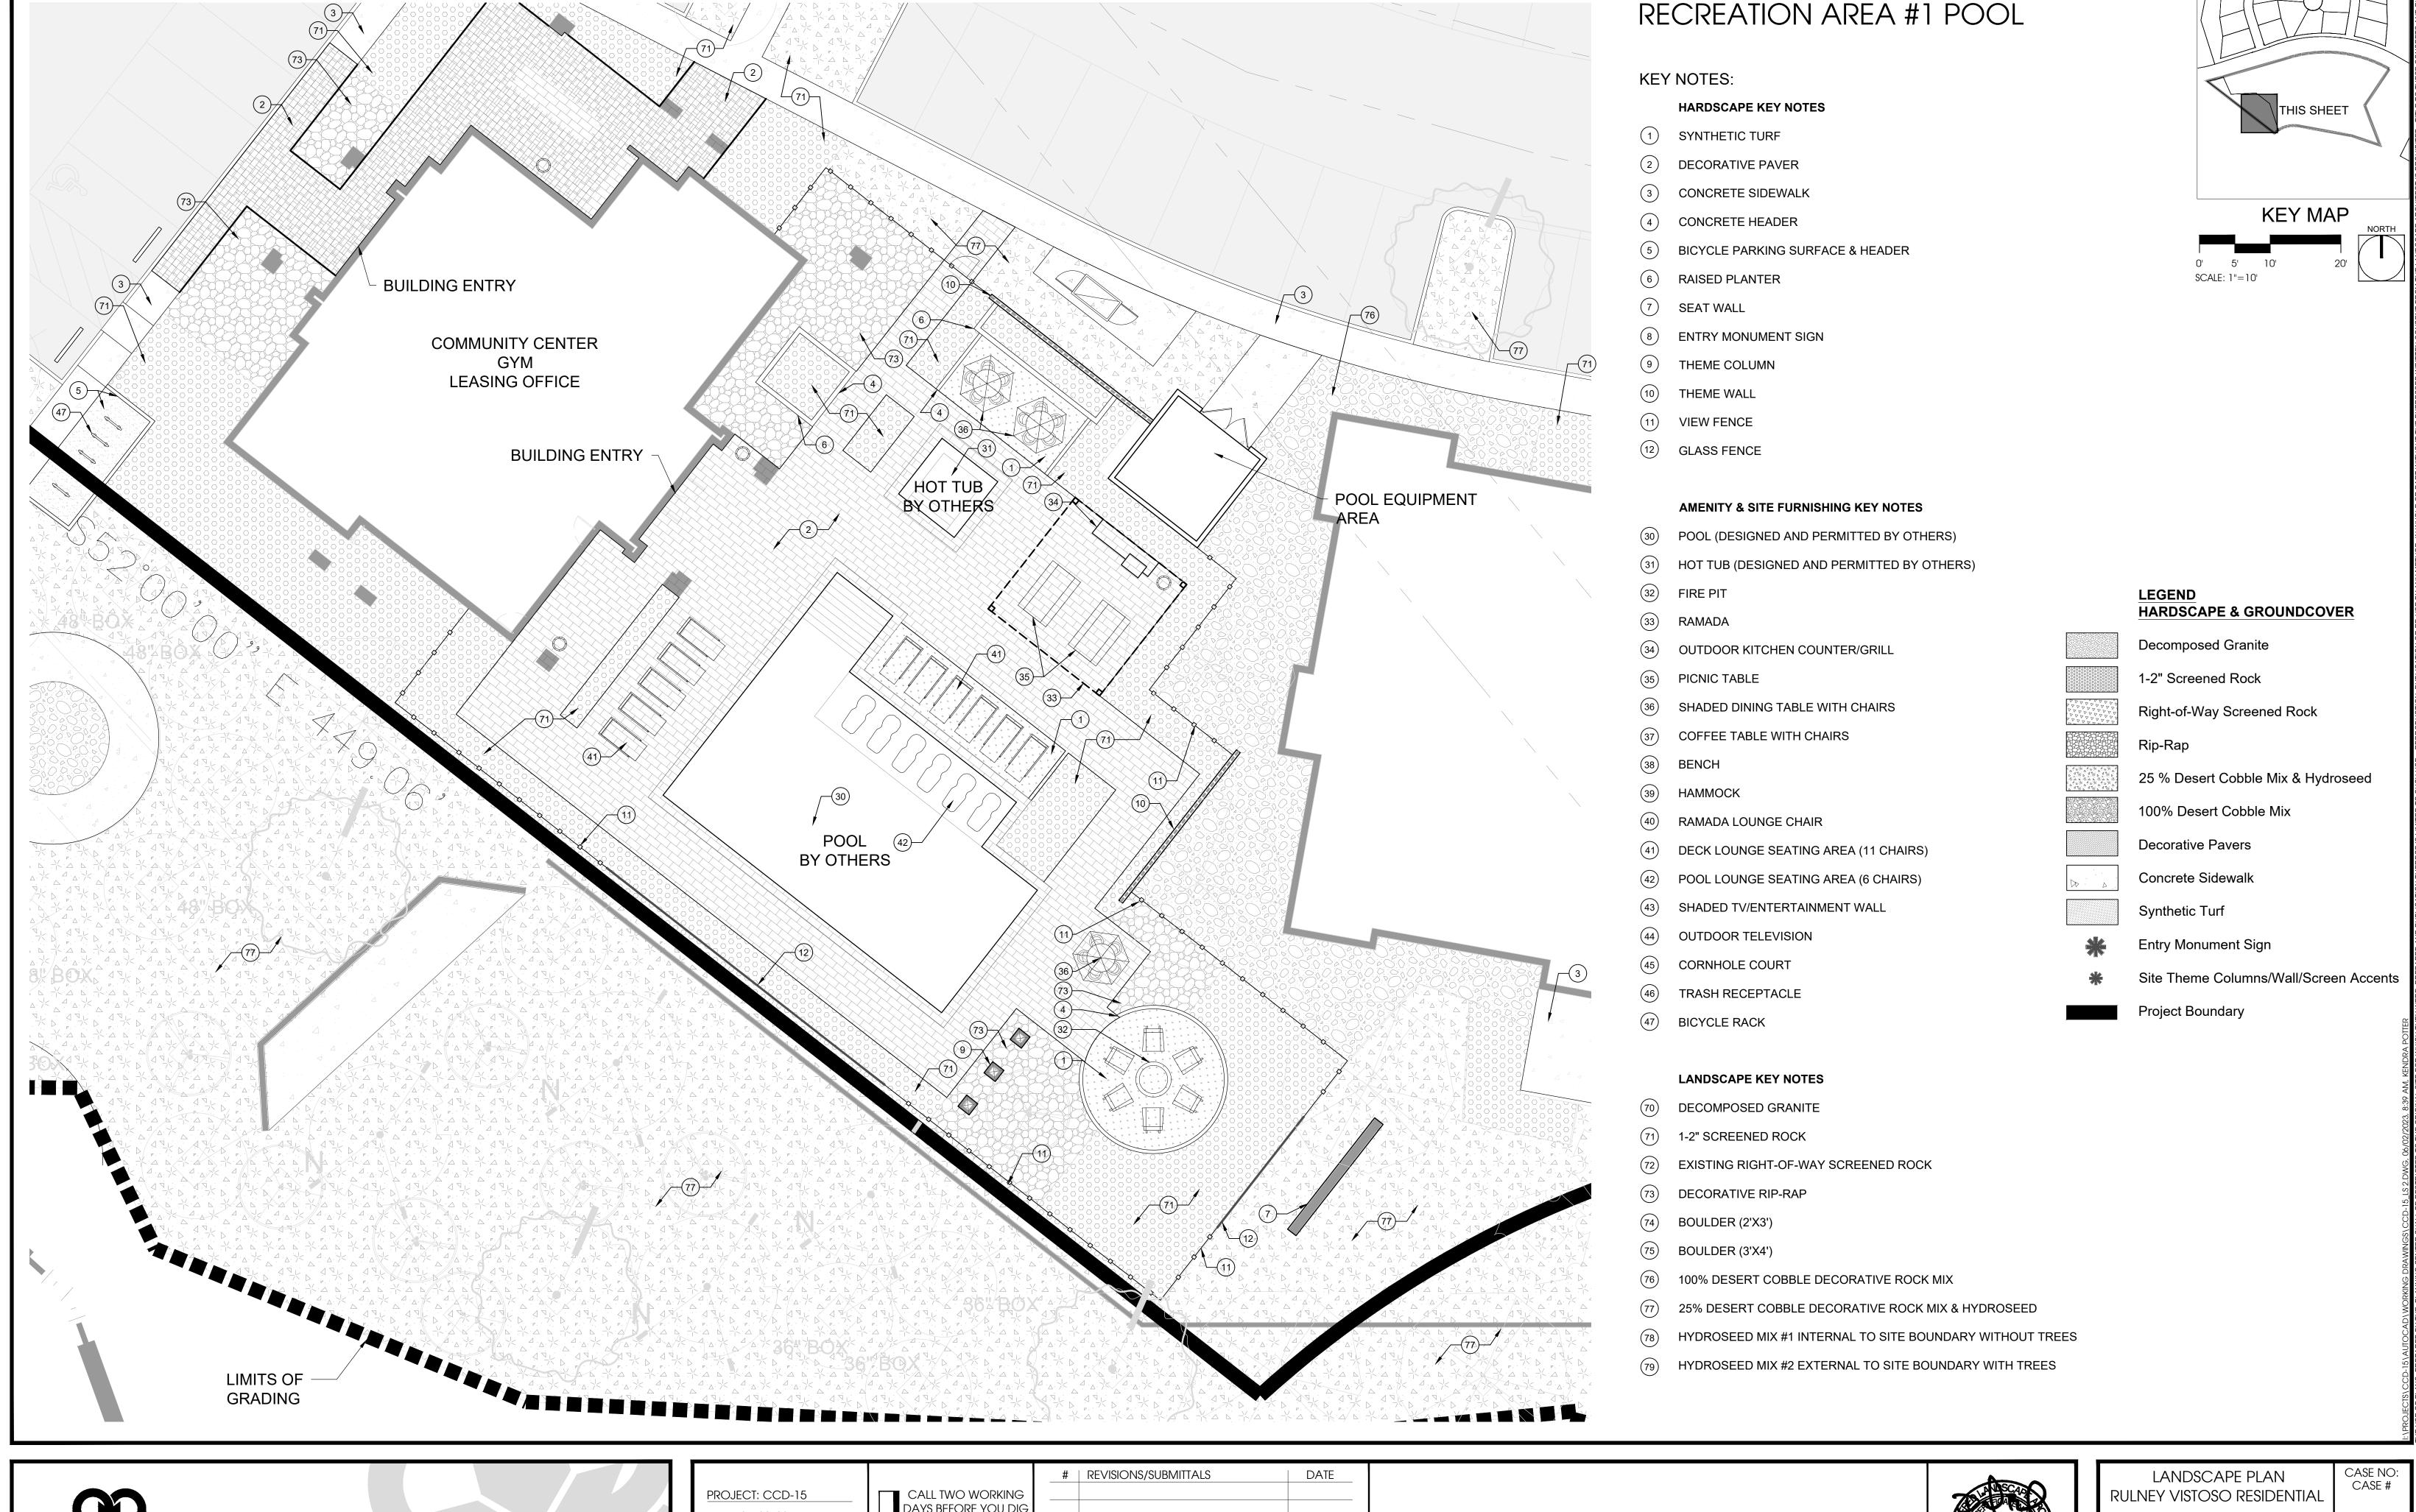
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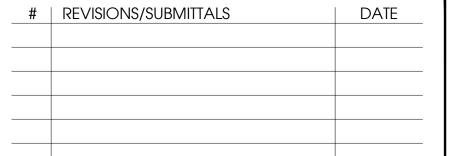
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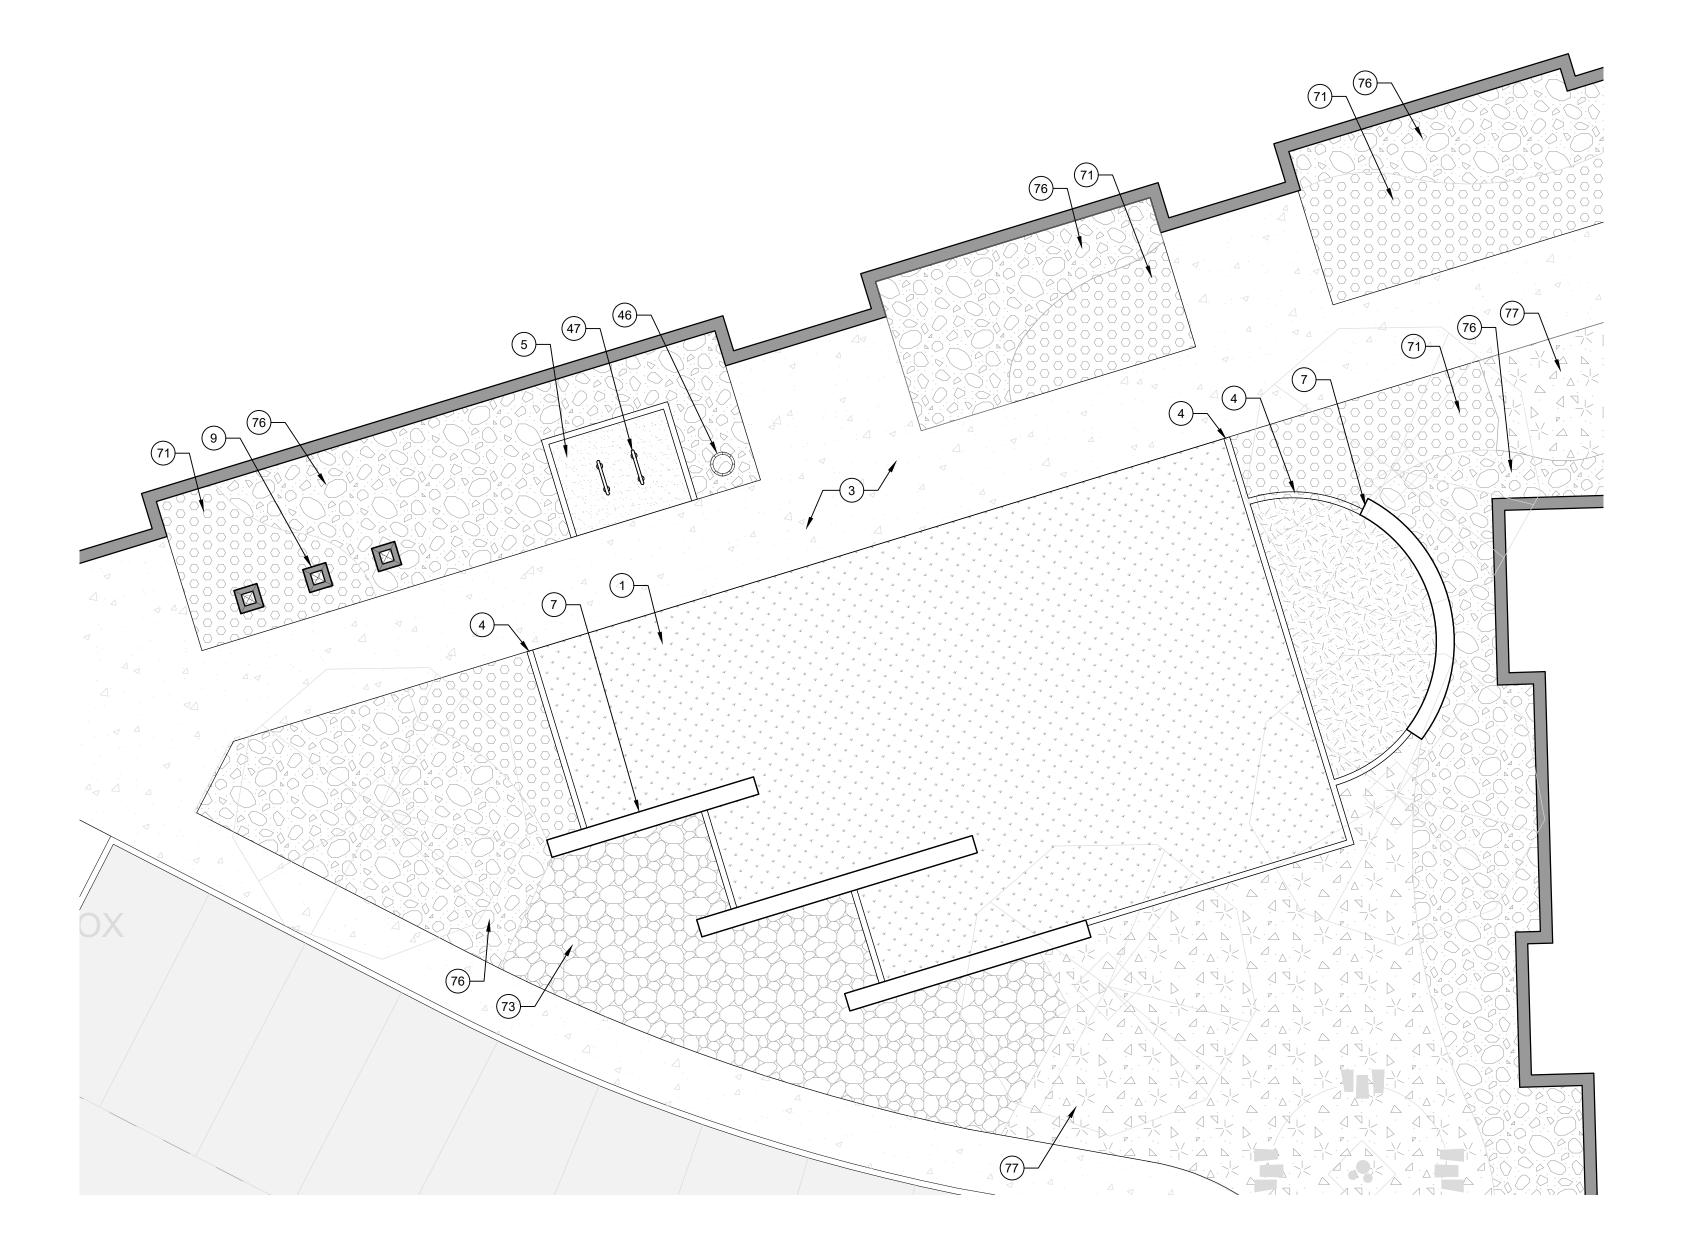




LANDSCAPE PLAN RULNEY VISTOSO RESIDEN

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RECREATION AREA #2 EVENT LAWN



KEY NOTES:

HARDSCAPE KEY NOTES

- (1) SYNTHETIC TURF
- 2 DECORATIVE PAVER
- (3) CONCRETE SIDEWALK
- (4) CONCRETE HEADER
- BICYCLE PARKING SURFACE & HEADER
- RAISED PLANTER
- SEAT WALL
- **ENTRY MONUMENT SIGN**
- THEME COLUMN
- THEME WALL
- (12) GLASS FENCE

VIEW FENCE


AMENITY & SITE FURNISHING KEY NOTES

- POOL (DESIGNED AND PERMITTED BY OTHERS)
- HOT TUB (DESIGNED AND PERMITTED BY OTHERS)
- 32
- OUTDOOR KITCHEN COUNTER/GRILL
- PICNIC TABLE
- SHADED DINING TABLE WITH CHAIRS
- COFFEE TABLE WITH CHAIRS
- HAMMOCK
- (40) RAMADA LOUNGE CHAIR
- DECK LOUNGE SEATING AREA (11 CHAIRS)
- POOL LOUNGE SEATING AREA (6 CHAIRS)
- (43) SHADED TV/ENTERTAINMENT WALL
- (44) OUTDOOR TELEVISION
- CORNHOLE COURT
- (46) TRASH RECEPTACLE
- 47 BICYCLE RACK

LANDSCAPE KEY NOTES

- 70 DECOMPOSED GRANITE
- 1-2" SCREENED ROCK
- (72) EXISTING RIGHT-OF-WAY SCREENED ROCK
- DECORATIVE RIP-RAP
- BOULDER (2'X3')
- BOULDER (3'X4')
- 100% DESERT COBBLE DECORATIVE ROCK MIX
- 25% DESERT COBBLE DECORATIVE ROCK MIX & HYDROSEED
- HYDROSEED MIX #1 INTERNAL TO SITE BOUNDARY WITHOUT TREES
- (79) HYDROSEED MIX #2 EXTERNAL TO SITE BOUNDARY WITH TREES



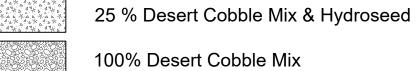

Rip-Rap



LEGEND

Decomposed Granite

1-2" Screened Rock

Right-of-Way Screened Rock







Site Theme Columns/Wall/Screen Accents

HARDSCAPE & GROUNDCOVER

THIS SHEET

KEY MAP

Project Boundary



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RECREATION AREA #2



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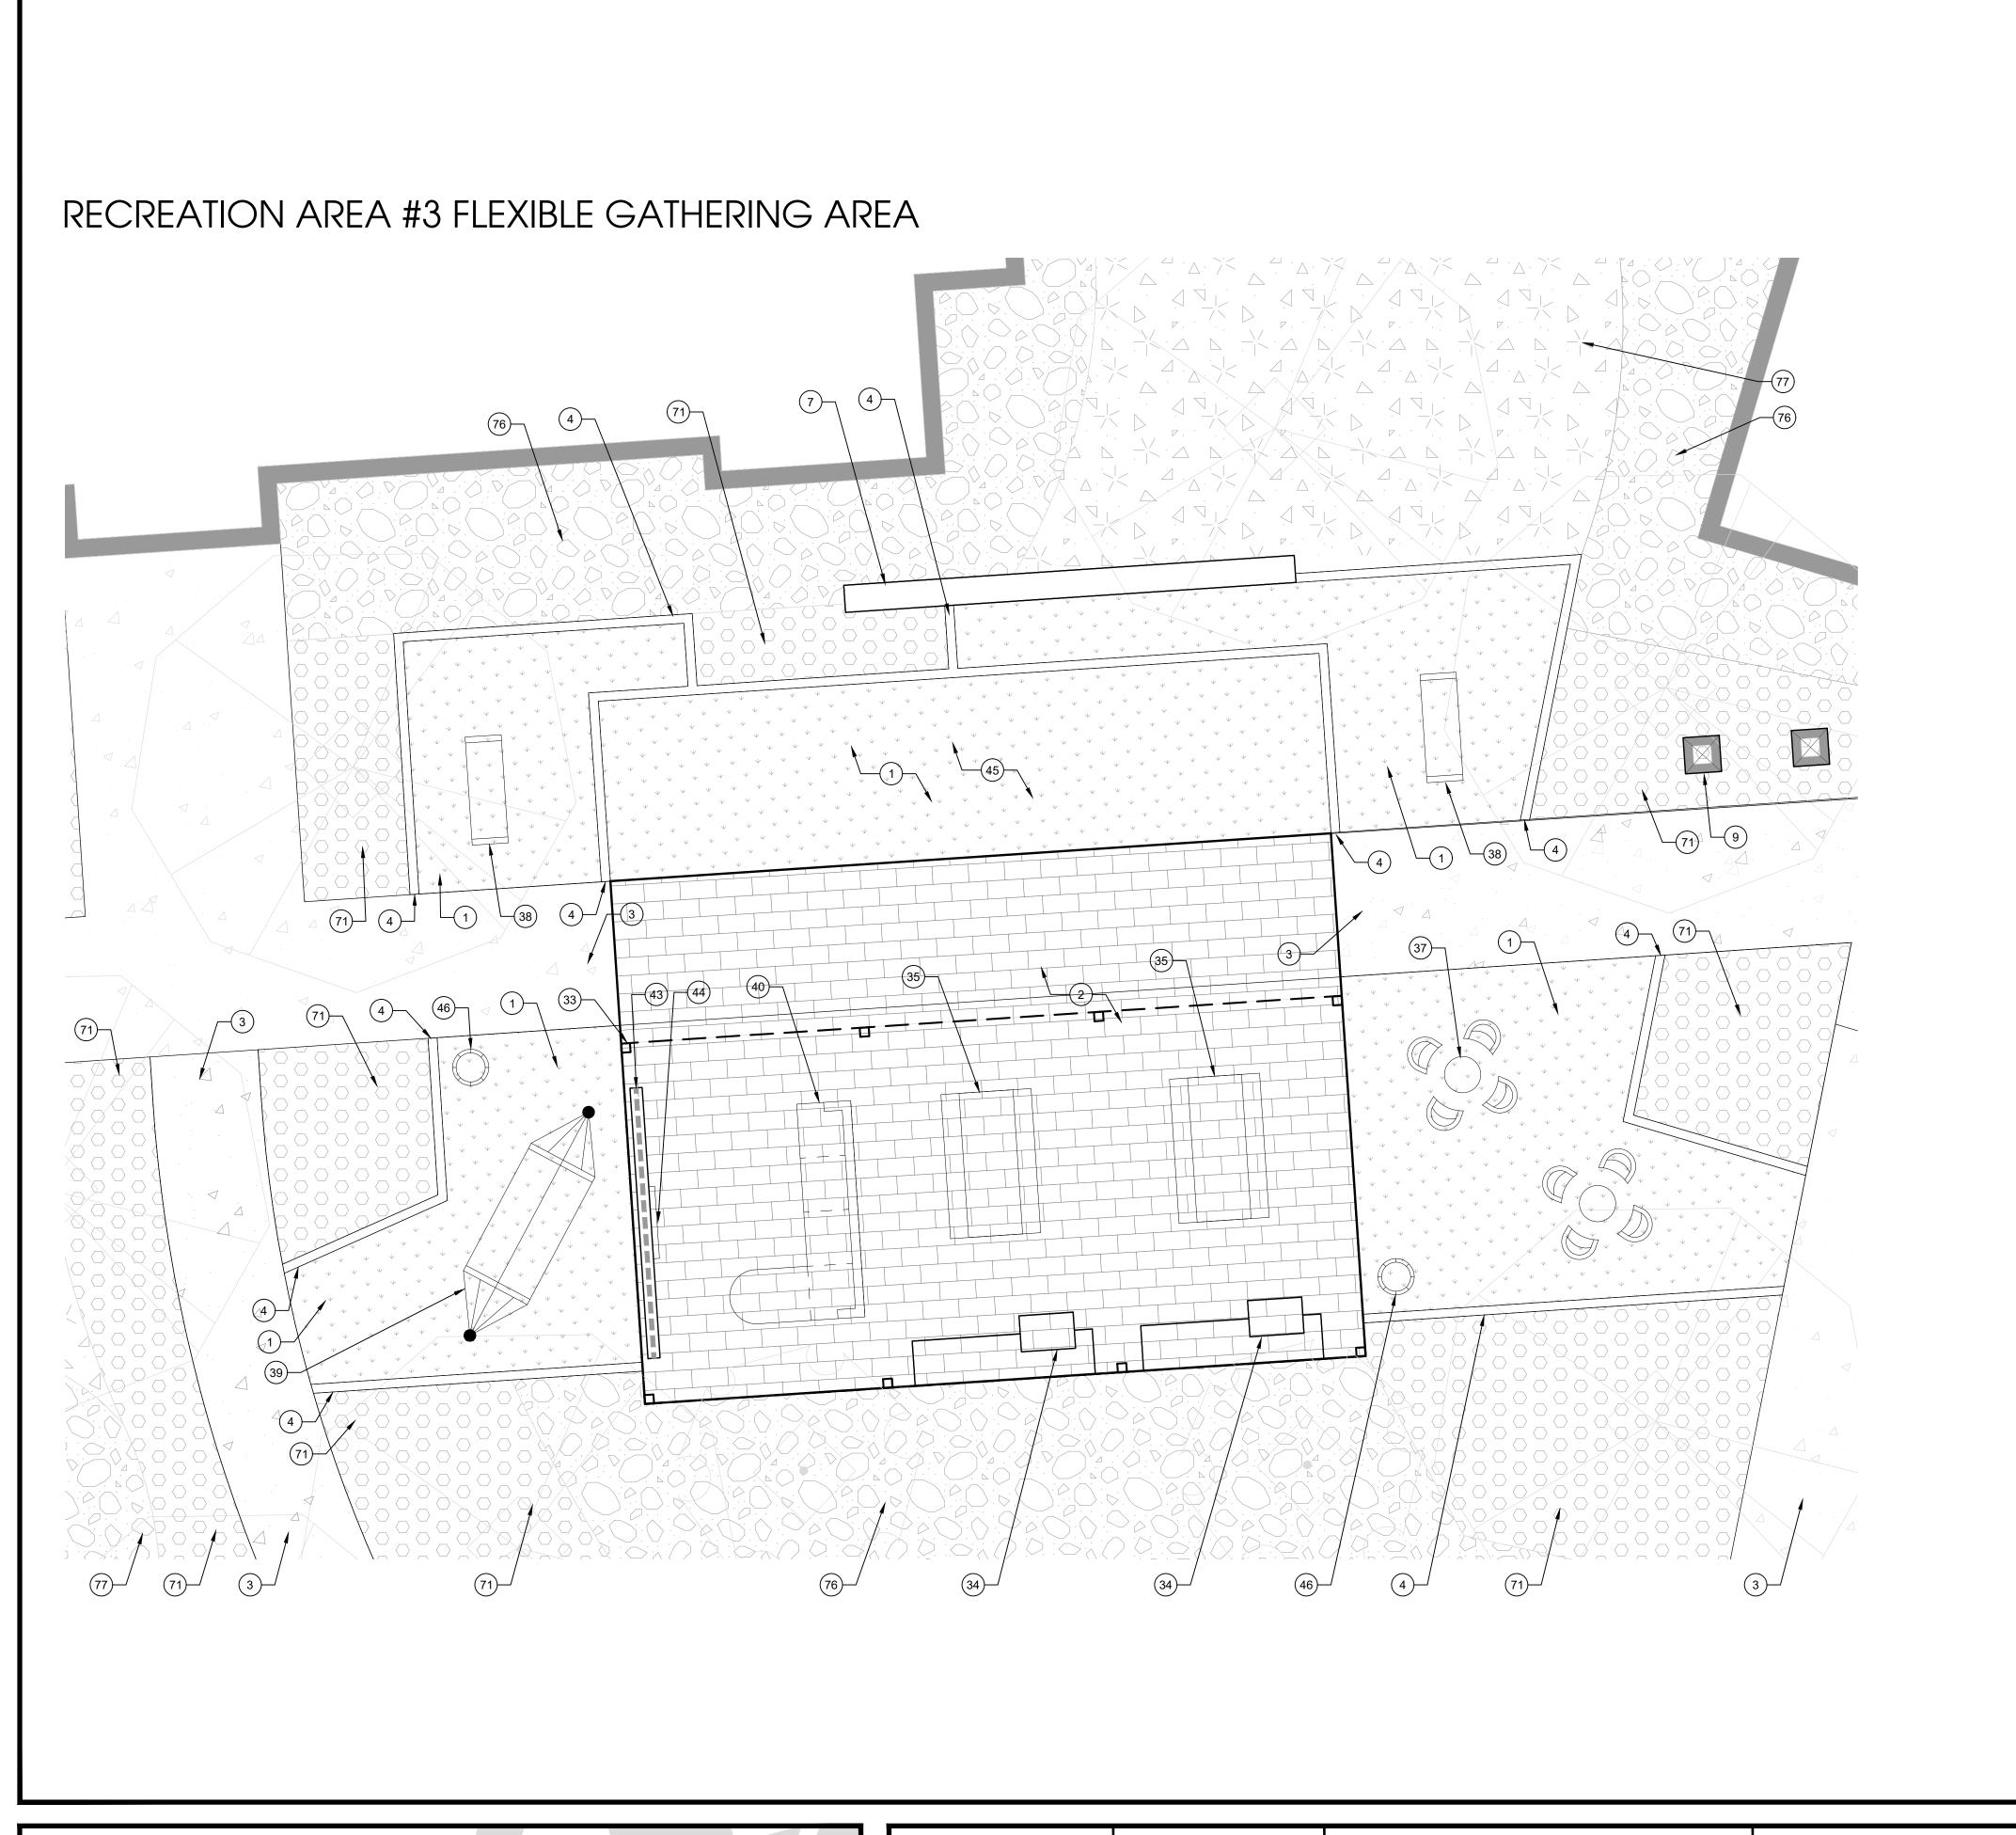
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KEY NOTES:

HARDSCAPE KEY NOTES

- SYNTHETIC TURF
- DECORATIVE PAVER
- CONCRETE SIDEWALK
- CONCRETE HEADER
- BICYCLE PARKING SURFACE & HEADER
- RAISED PLANTER
- SEAT WALL
- ENTRY MONUMENT SIGN
- THEME COLUMN
- THEME WALL
- **VIEW FENCE**
- (12) GLASS FENCE

AMENITY & SITE FURNISHING KEY NOTES

- POOL (DESIGNED AND PERMITTED BY OTHERS)
- HOT TUB (DESIGNED AND PERMITTED BY OTHERS)

- OUTDOOR KITCHEN COUNTER/GRILL
- SHADED DINING TABLE WITH CHAIRS
- COFFEE TABLE WITH CHAIRS
- HAMMOCK
- RAMADA LOUNGE CHAIR
- (41) DECK LOUNGE SEATING AREA (11 CHAIRS)
- POOL LOUNGE SEATING AREA (6 CHAIRS)
- SHADED TV/ENTERTAINMENT WALL
- **OUTDOOR TELEVISION**
- CORNHOLE COURT
- TRASH RECEPTACLE
- BICYCLE RACK

LANDSCAPE KEY NOTES

- DECOMPOSED GRANITE
- 1-2" SCREENED ROCK
- EXISTING RIGHT-OF-WAY SCREENED ROCK
- DECORATIVE RIP-RAP
- BOULDER (2'X3')
- BOULDER (3'X4')
- 100% DESERT COBBLE DECORATIVE ROCK MIX
- 25% DESERT COBBLE DECORATIVE ROCK MIX & HYDROSEED
- HYDROSEED MIX #1 INTERNAL TO SITE BOUNDARY WITHOUT TREES
- HYDROSEED MIX #2 EXTERNAL TO SITE BOUNDARY WITH TREES



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RECREATION AREA #3



LANDSCAPE PLAN RULNEY VISTOSO RESIDENTIAL

LEGEND

Rip-Rap

Decomposed Granite

1-2" Screened Rock

Right-of-Way Screened Rock

100% Desert Cobble Mix

Decorative Pavers

Concrete Sidewalk

Entry Monument Sign

Project Boundary

Synthetic Turf

25 % Desert Cobble Mix & Hydroseed

Site Theme Columns/Wall/Screen Accents

HARDSCAPE & GROUNDCOVER

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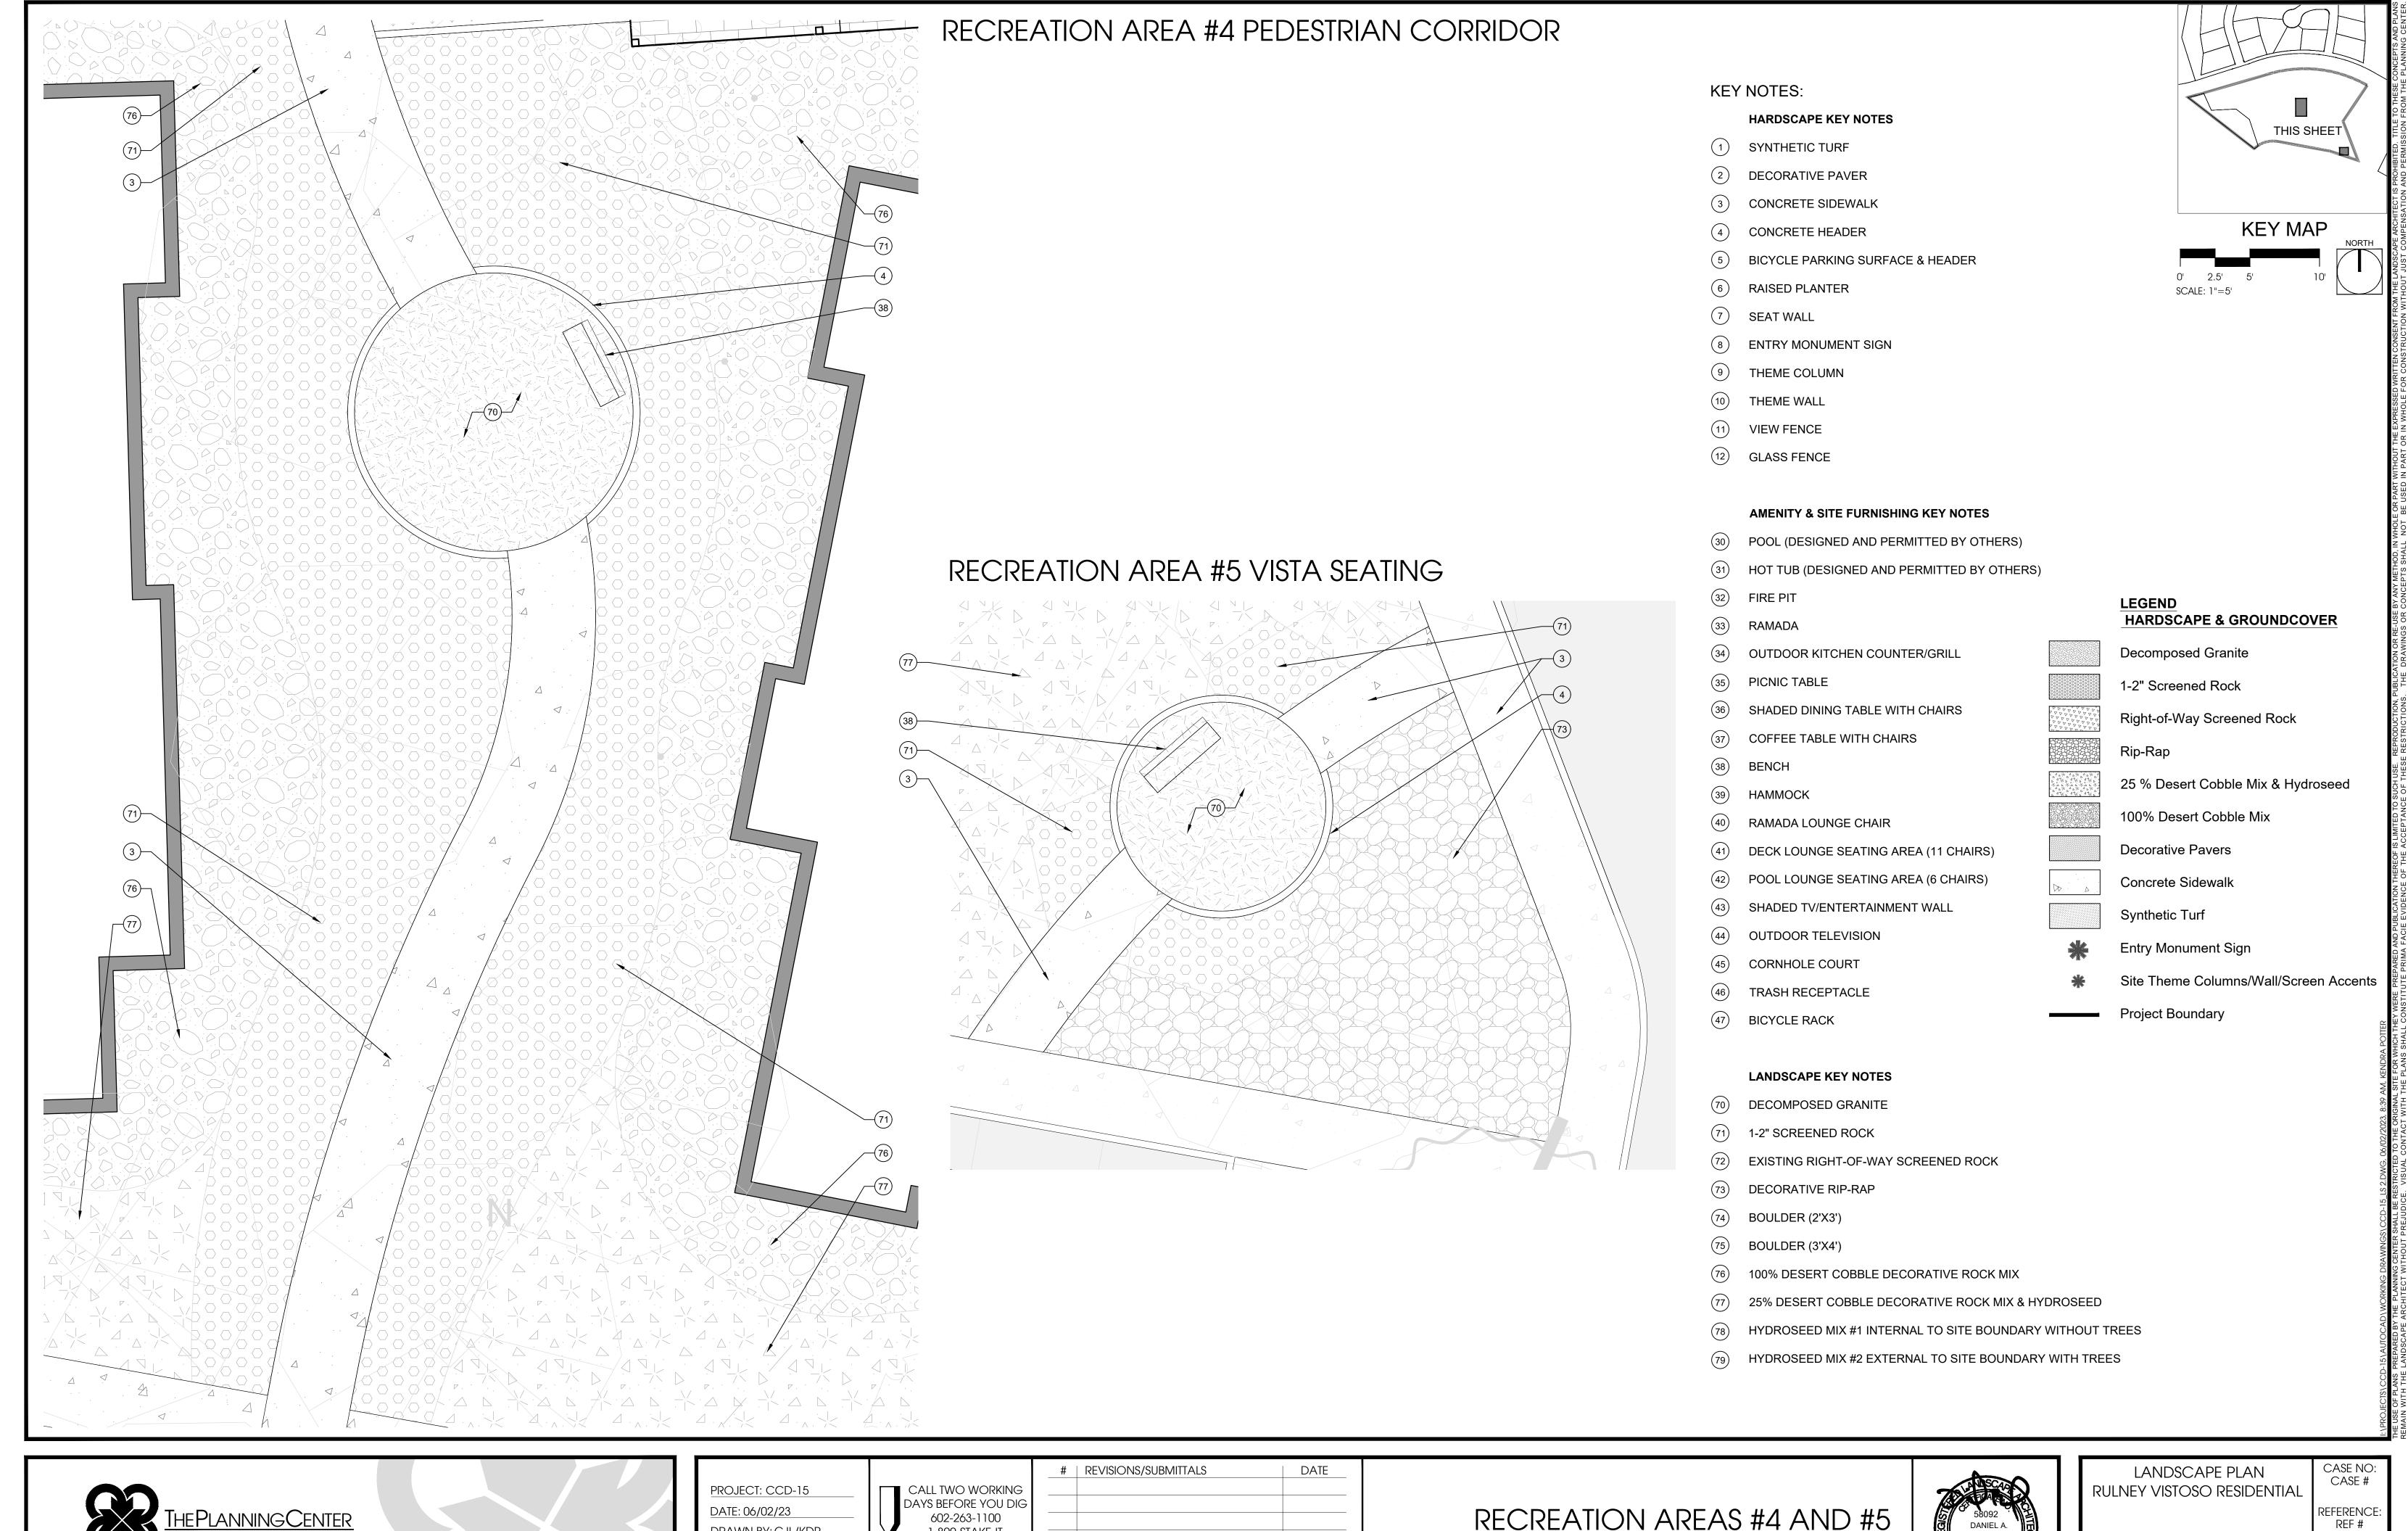
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REFERENCE: REF #

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KEY MAP





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602-263-1100 1-800-STAKE-IT MARICOPA COUNTY)

RECREATION AREAS #4 AND #5



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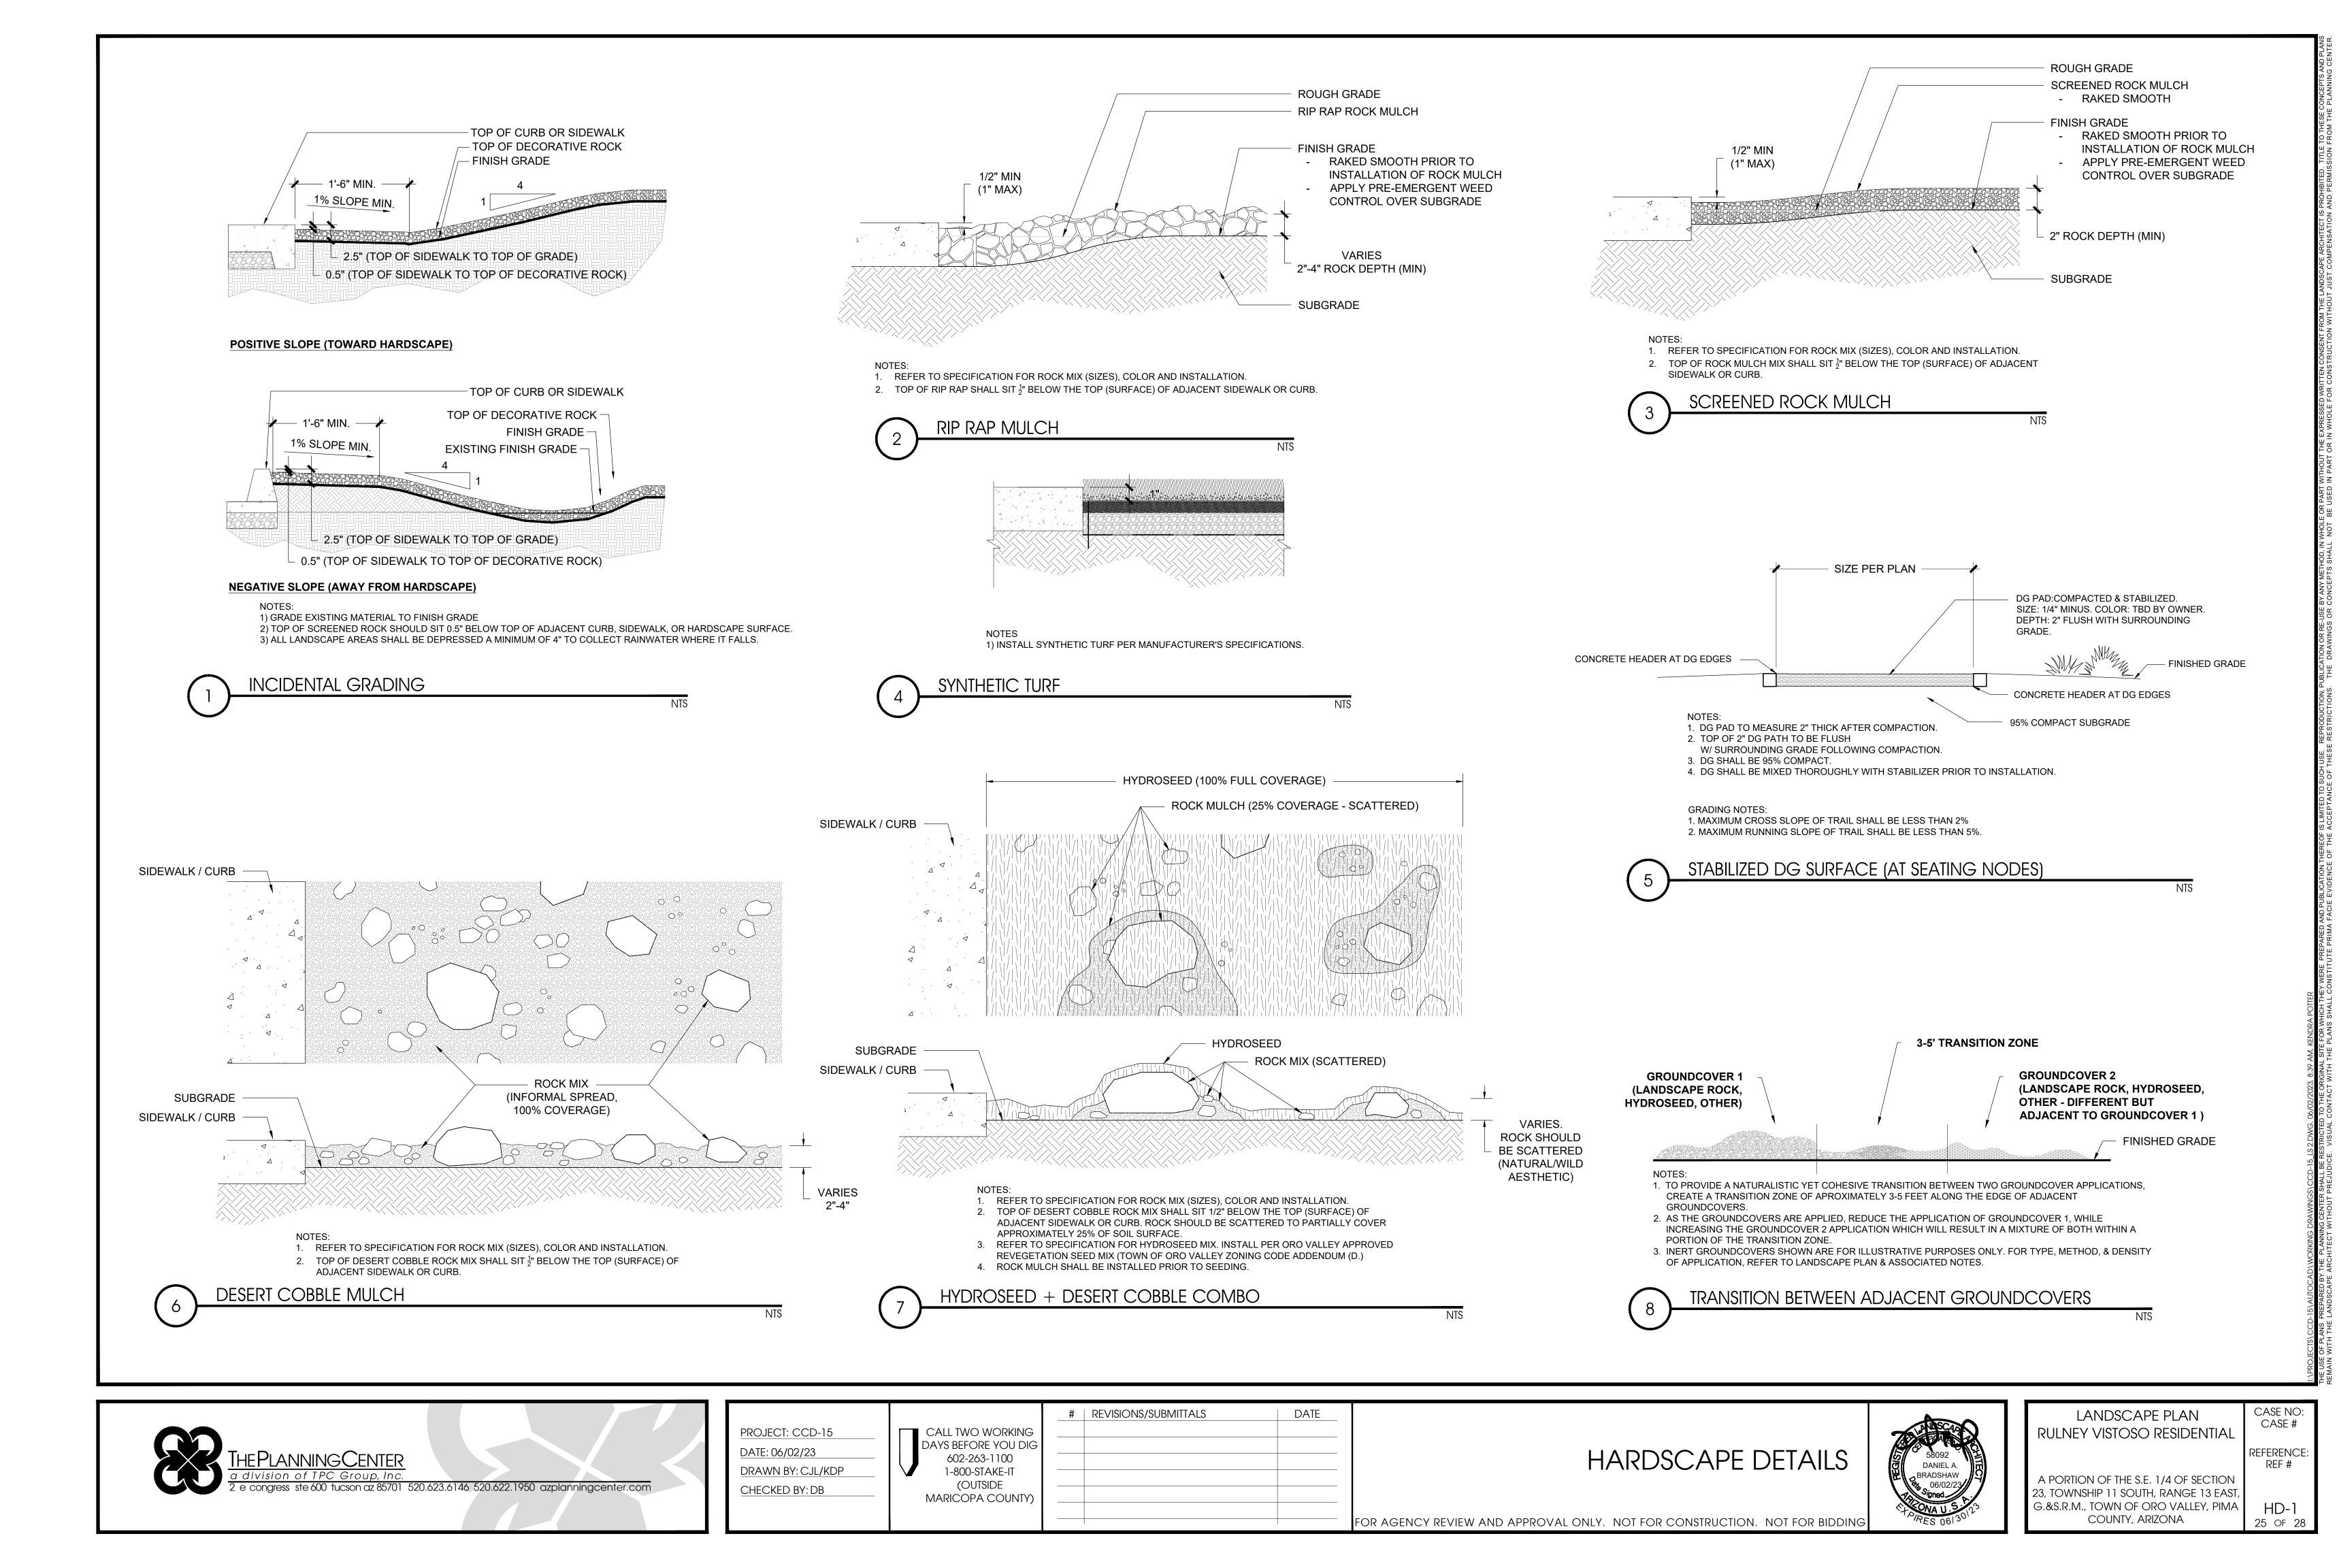






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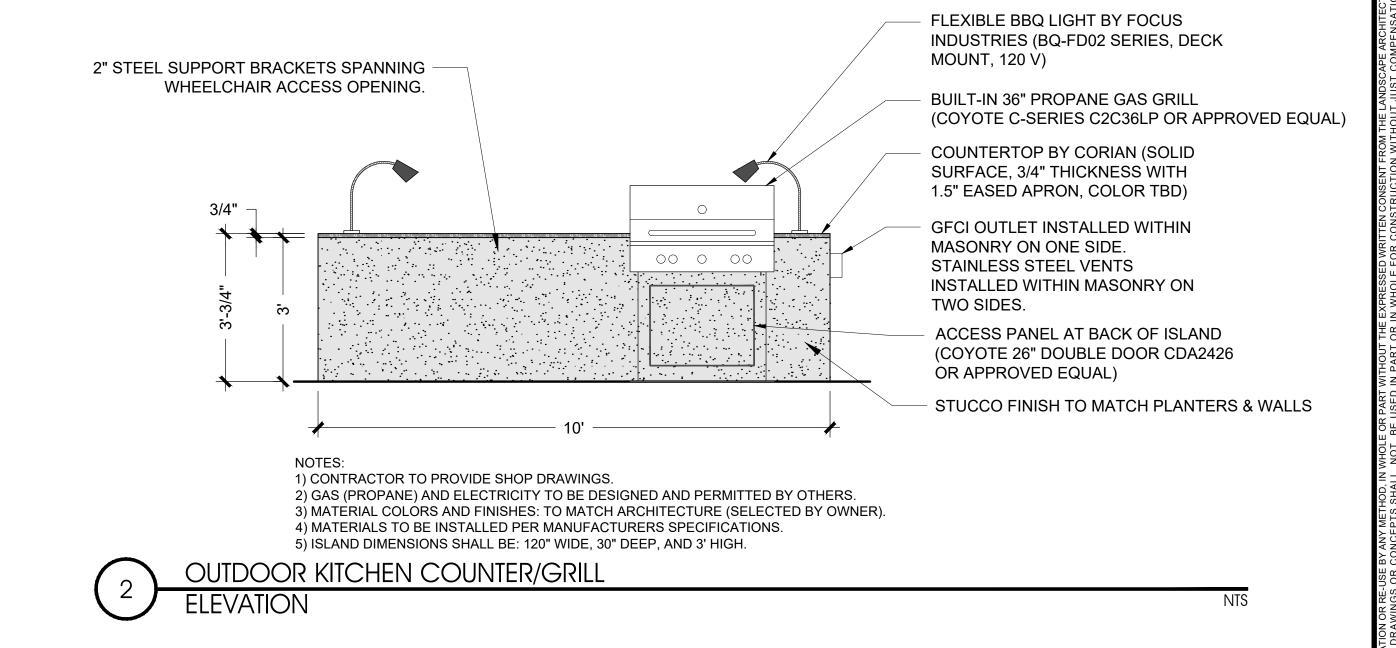
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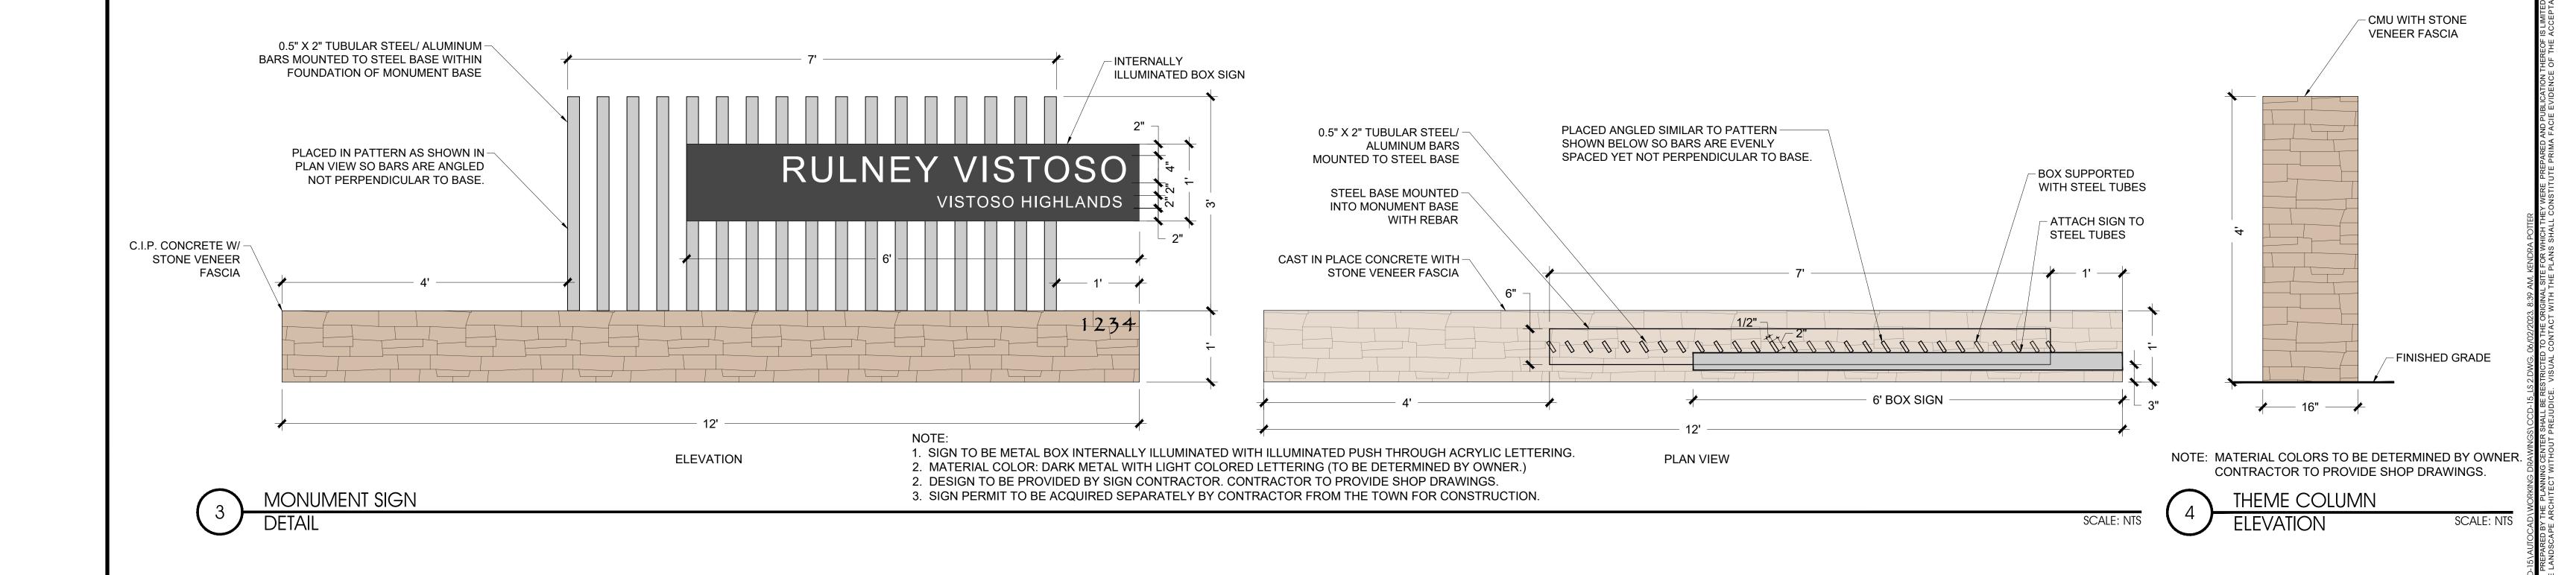








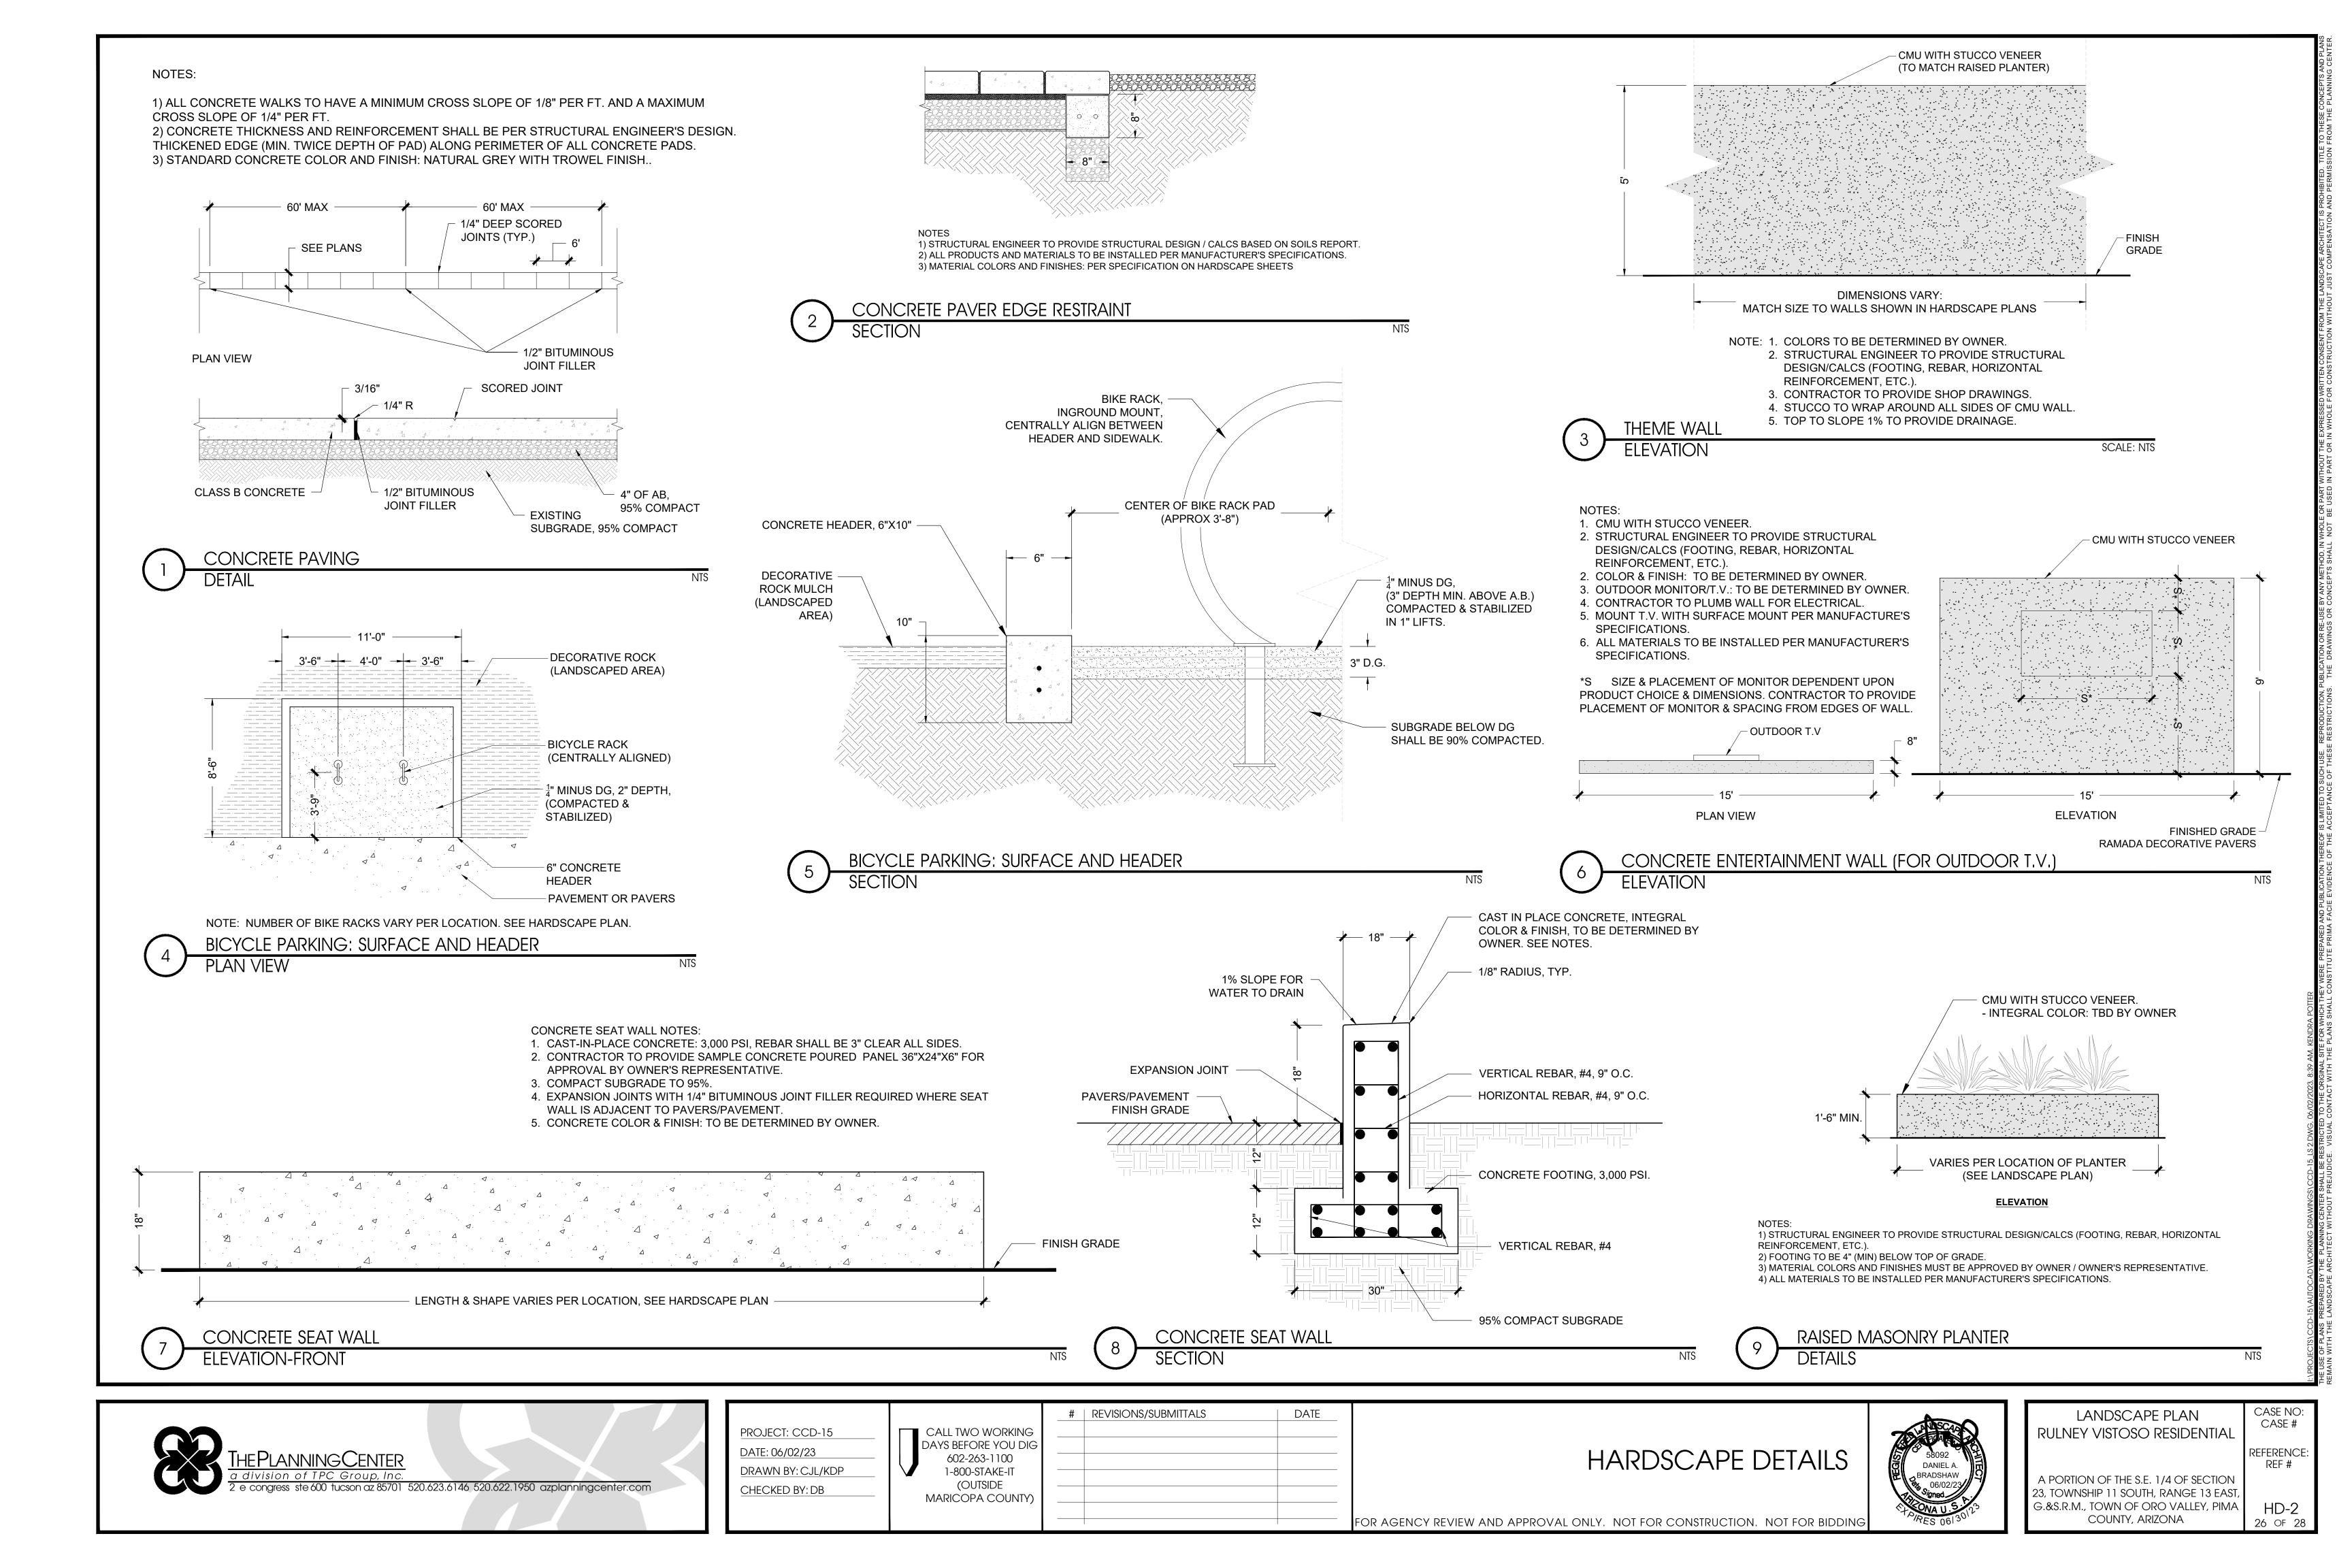

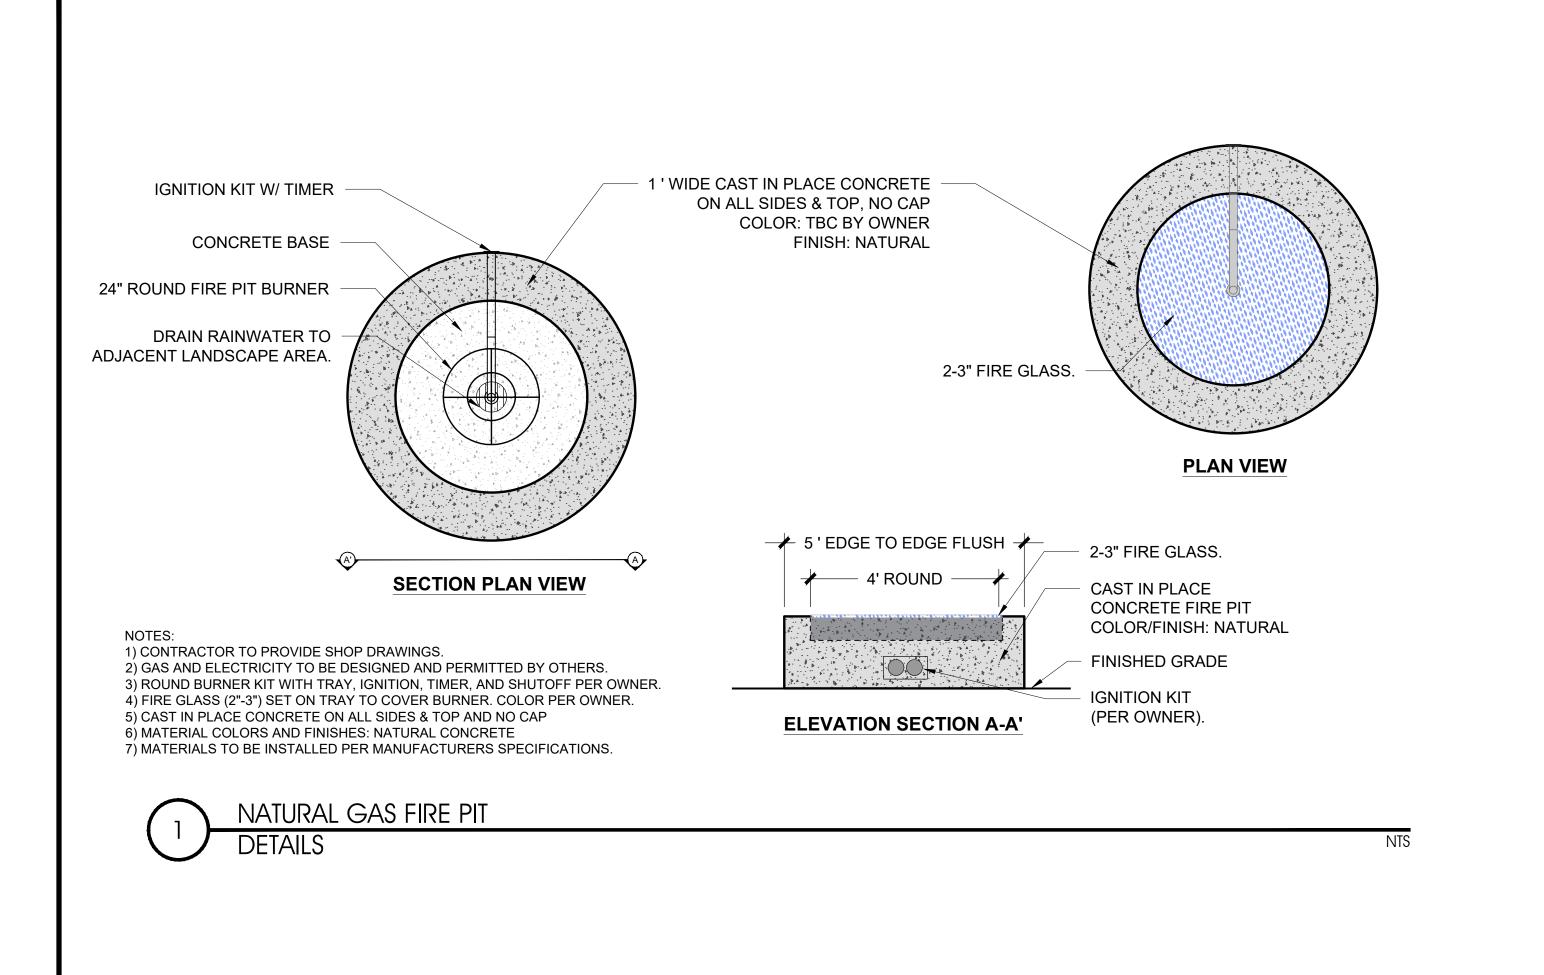






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COUNTY, ARIZONA





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HARDSCAPE DETAILS

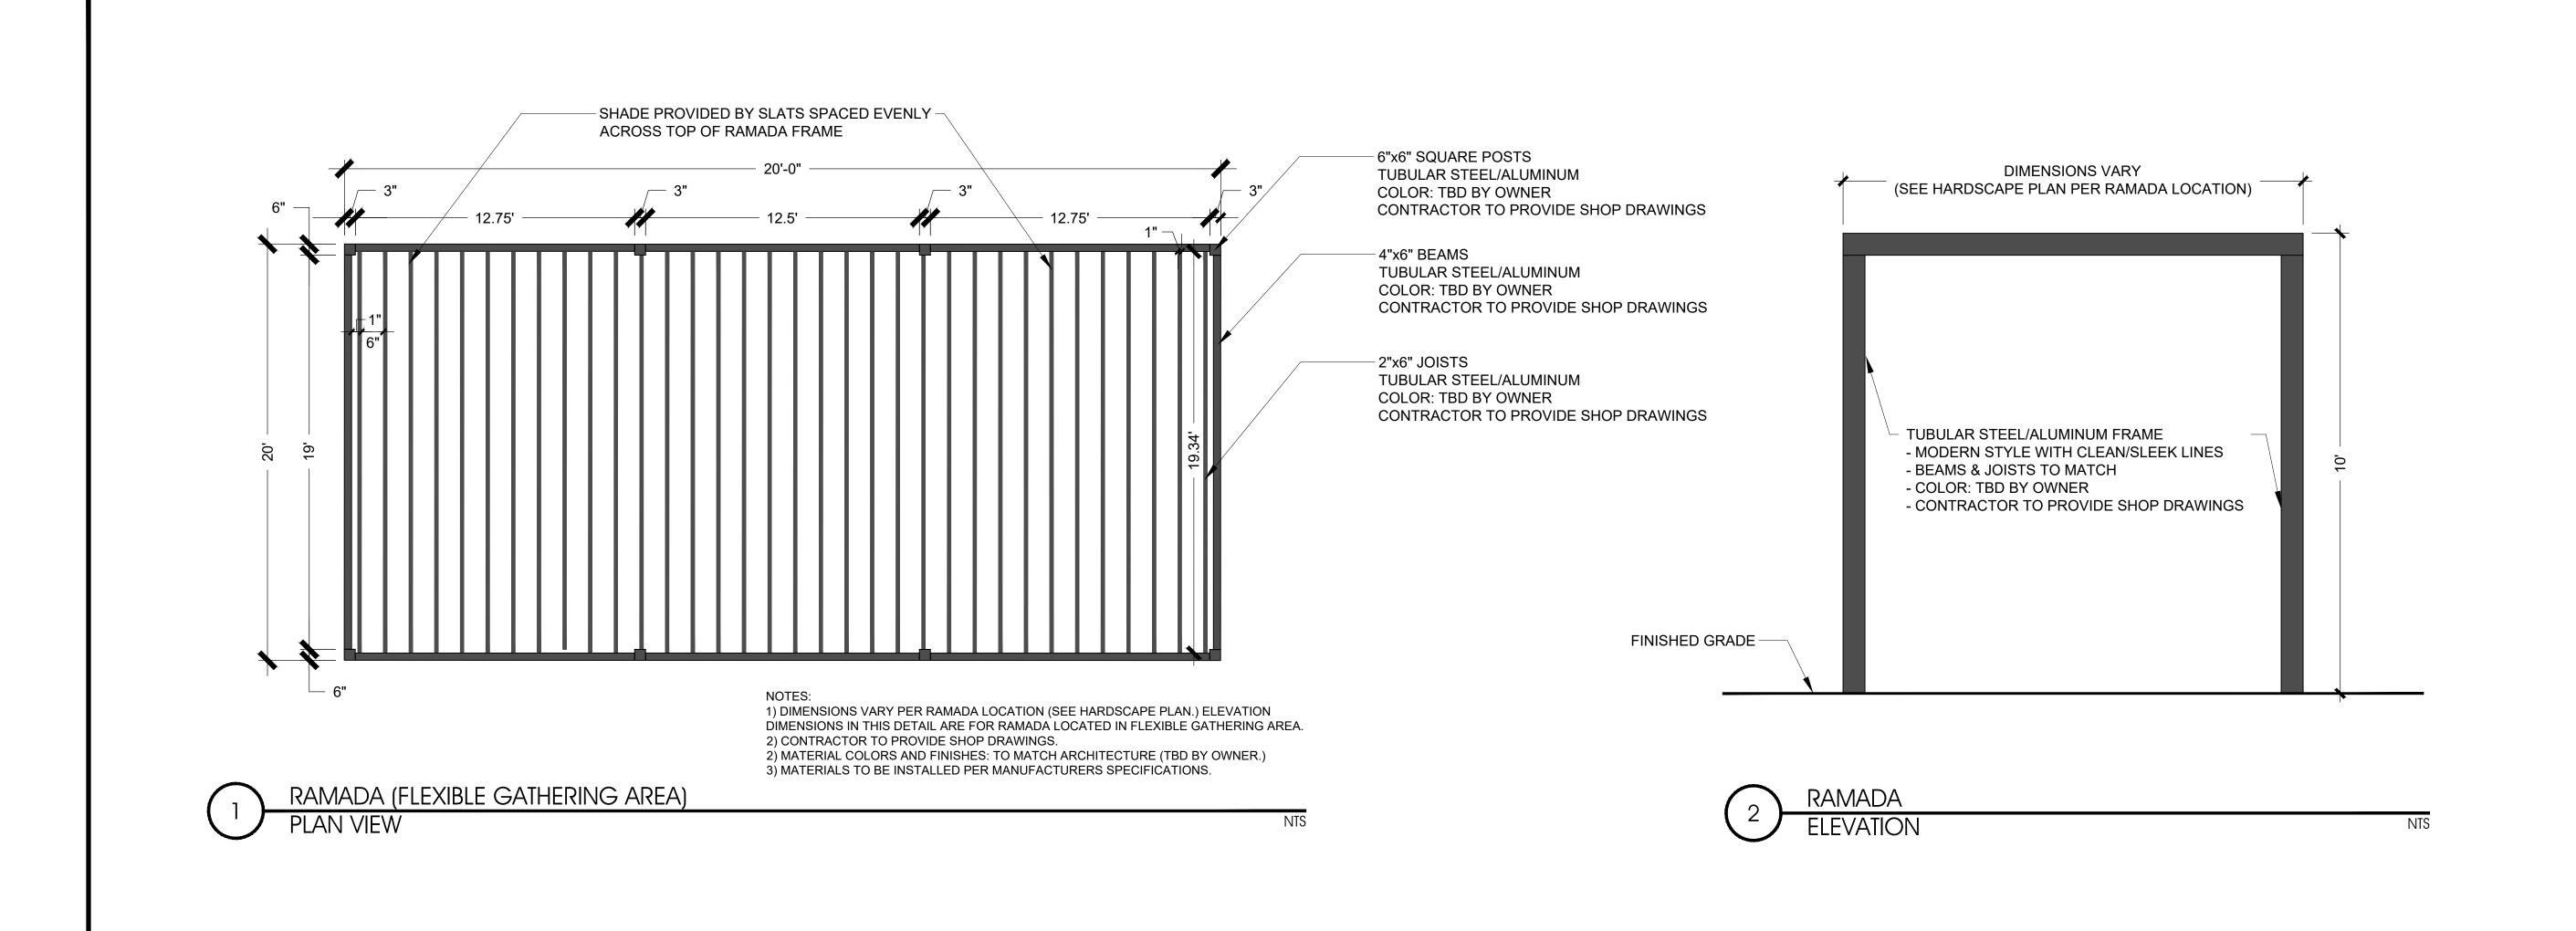

LANDSCAPE PLAN RULNEY VISTOSO RESIDENTIAL

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HD-4